MATCHLINE SEE DRAWING NO. L1.01 — EXISTING SIDEWALK (TYP.) ----- EXISTING R/W LINE (TYP.) — EXISTING SIGN (TYP.) EXISTING EASEMENT -

Sunshine

Call 811 or www.sunshine811.com two full

business days before digging to have utilities located and marked.

Check positive response codes before you dig!

EXISTING TREE INVENTORY/DISPOSITION

| TREE # | BOTANICAL NAME | COMMON NAME | TRUNK DBH (in) | CANOPY SPREAD (ft) | CANOPY AREA (sf) | CLEAR TRUNK | DISPOSITION | CONDITION | CANOPY MITIGATION (sf) | COMMENTS |
|--------|-----------------------|--------------------|-------------------|--------------------------|---------------------|----------------|-------------|--------------|---------------------------|-------------------|
| 1 | Bursera simaruba | Gumbo Limbo | 5 | 15 | 177 | | Remove | Fair | 177 | |
| 2 | Bursera simaruba | Gumbo Limbo | 5 | 15 | 177 | | Remove | Fair | 177 | |
| 3 | Bursera simaruba | Gumbo Limbo | 5 | 15 | 177 | | Remove | Fair | 177 | |
| 4 | Roystonea elata | Royal Palm | 18 | 15 | 177 | 15 | Remove | Fair | 177 | |
| 5 | Bursera simaruba | Gumbo Limbo | 5 | 15 | 177 | | Remove | Fair | 177 | |
| 6 | Bursera simaruba | Gumbo Limbo | 5 | 15 | 177 | | Remove | Fair | 177 | |
| 7 | Bursera simaruba | Gumbo Limbo | 5 | 15 | 177 | | Remove | Fair | 177 | |
| 8 | Roystonea elata | Royal Palm | 18 | 15 | 177 | 15 | Remove | Fair | 177 | |
| 9 | | | | | | | | | | |
| 10 | | | | | | | | | | |
| 11 | Roystonea elata | Royal Palm | 18 | 15 | 177 | | Remove | Fair | 177 | |
| 12 | Roystonea elata | Royal Palm | 18 | 15 | 177 | | Remove | Fair | 177 | |
| 13 | Adonidia | Veitchia merrillii | 6 | 10 | 79 | 20 | Remove | Fair | 79 | |
| 14 | Adonidia | Veitchia merrillii | 6 | 10 | 79 | 20 | Remove | Fair | 79 | |
| 15 | Adonidia | Veitchia merrillii | 6 | 10 | 79 | 10 | Remove | Fair | 79 | |
| 16 | | | | | | | | | | |
| 17 | | | | | | | | | | |
| 18 | Adonidia | Veitchia merrillii | 6 | 10 | 79 | 10 | Remove | Fair | 79 | |
| 19 | Bursera simaruba | Gumbo Limbo | 5 | 15 | 177 | - | Remove | Fair | 177 | |
| 20 | Bursera simaruba | Gumbo Limbo | 5 | 15 | 177 | | Remove | Fair | 177 | |
| 21 | Bursera simaruba | Gumbo Limbo | 5 | 15 | 177 | | Remove | Fair | 177 | |
| 22 | Bursera simaruba | Gumbo Limbo | 5 | 15 | 177 | | Remove | Fair | 177 | |
| 23 | Bursera simaruba | Gumbo Limbo | 5 | 15 | 177 | | Remove | Fair | 177 | |
| 24 | Bursera simaruba | Gumbo Limbo | 5 | 15 | 177 | | Remove | Fair | 177 | |
| 25 | Adonidia | Veitchia merrillii | 6 | 10 | 79 | 10 | Remove | Fair | 79 | |
| 26 | Addition | Verterna mermin | | | 13 | | Kemove | 1 411 | , , | |
| 27 | Adonidia | Veitchia merrillii | 6 | 10 | 79 | 10 | Remove | Fair | 79 | |
| 28 | Adomaid | Verterna mermin | | 10 | 73 | 10 | Remove | ı un | ,,, | |
| 29 | Adonidia | Veitchia merrillii | 6 | 10 | 79 | 10 | Remove | Fair | 79 | |
| 30 | Sabal palmetto | Cabbage Palm | 36 | 25 | 491 | 5 | Remove | Fair | 491 | Cluster |
| 31 | Mangifera indica | Mango Tree | | 20 | 314 | | Remove | | 314 | Multi-Trunk |
| 32 | Roystonea elata | Royal Palm | 12 18 | 15 | 177 | 15 | Remove | Fair Fair | 177 | iviuiti- I I UIIK |
| 33 | Roystonea elata | Royal Palm | 18 | 15 | 177 | 15 | Remove | Fair Fair | 177 | |
| 34 | Noystonea elata | Noyairaiiii | 10 | 13 | 1// | 12 | Nemove | FdII | 1// | |
| | Roystonea elata | Royal Palm | 10 | 15 | 177 | 1 [| Domovo | Га:- | 177 | |
| 35 | • | • | 18 | 15 | 177 | 15 | Remove | Fair | 177 | |
| 36 | Bursera simaruba | Gumbo Limbo | 5 | 15 | 177 | | Remove | Fair | 177 | NA. 14: T |
| 37 | Mangifera indica | Mango Tree | 12 | 20 | 314 | | Remove | Fair | 314 | Multi-Trunk |
| 38 | Syagrus romanzoffiana | | 6 | 5 | 20 | 3 | Remove | Poor | 20 | |
| 39 | Bursera simaruba | Gumbo Limbo | 5 | 15 | 177 | | Remove | Fair | 177 | |
| 40 | Roystonea elata | Royal Palm | 18 | 15 | 177 | 15 | Remove | Fair | 177 | |
| 41 | Bursera simaruba | Gumbo Limbo | 5 | 15 | 177 | | Remove | Fair | 177 | |
| 42 | Bursera simaruba | Gumbo Limbo | 5 | 15 | 177 | | Remove | Fair | 177 | |
| 43 | Swietenia mahagoni | Mahogany | 36 | 45 | 1,590 | | Remove | Fair | 1,590 | |
| 44 | Roystonea elata | Royal Palm | 18 | 15 | 177 | 15 | Remove | Fair | 177 | ĺ |

TREE INVENTORY NOTE: TREE LOCATIONS NOT PROVIDED WITH SURVEY. TREES IDENTIFIED VIA MOST CURRENT AERIAL IMAGERY, GOOGLE STREETVIEW AND FIELD OBSERVATIONS.

LEGEND

TREE/ PALM TO REMAIN. REFER TO TREE INVENTORY CHART ABOVE



TREE TO BE REMOVED/ RELOCATED. REFER TO TREE INVENTORY CHART ABOVE



TREE IDENTIFICATION NUMBER



500 West Cypress Creek Road Suite 630 Ft. Lauderdale, FL 33309 **954.730.0707** www.chenmoore.com

REGISTRATION

CRISTOBAL A. BETANCOURT, RLA
REGISTRATION NO. 6666941
DATE: _5/6/2021_



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CLIENT

OAKLAND PARK DIXIE, LLC

PROJECT INFORMATION

SKY BUILDING

PROJECT NUMBER 20-487.001

CLIENT PROJECT NUMBER

VERIFY SCALES

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DATE OF ISSUE 03.18.2021

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DRAWN BY

CHECKED BY

DRAWING TITLE

TREE DISPOSITION PLAN

L1 OF 26

NE 39TH STREET - EXISTING R/W LINE (TYP.) __EXISTING SIGN (TYP.)

MATCHLINE SEE DRAWING NO. L1.00

EXISTING TREE INVENTORY/DISPOSITION

| TREE # | BOTANICAL NAME | COMMON NAME | TRUNK DBH (in) | CANOPY SPREAD (ft) | CANOPY AREA (sf) | CLEAR TRUNK | DISPOSITION | CONDITION | CANOPY MITIGATION (sf) | COMMENTS |
|-----------|-----------------------|--------------------|-------------------|--------------------------|---------------------|----------------|-------------|-----------|---------------------------|-------------|
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| 4 | Roystonea elata | Royal Palm | 18 | 15 | 177 | 15 | Remove | Fair | 177 | |
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| 6 | Bursera simaruba | Gumbo Limbo | 5 | 15 | 177 | | Remove | Fair | 177 | |
| 7 | Bursera simaruba | Gumbo Limbo | 5 | 15 | 177 | | Remove | Fair | 177 | |
| 8 | Roystonea elata | Royal Palm | 18 | 15 | 177 | 15 | Remove | Fair | 177 | |
| 9 | | | | | <u> </u> | | | | | |
| 10 | | | | | ' | | | | | |
| 11 | Roystonea elata | Royal Palm | 18 | 15 | 177 | | Remove | Fair | 177 | |
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| 13 | Adonidia | Veitchia merrillii | 6 | 10 | 79 | 20 | Remove | Fair | 79 | |
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| 28 | ! | | ! | <u> </u> | <u> </u> | | | | | |
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| 31 | Mangifera indica | Mango Tree | 12 | 20 | 314 | | Remove | Fair | 314 | Multi-Trunk |
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| 35 | Roystonea elata | Royal Palm | 18 | 15 | 177 | 15 | Remove | Fair | 177 | |
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| 37 | Mangifera indica | Mango Tree | 12 | 20 | 314 | | Remove | Fair | 314 | Multi-Trunk |
| 38 | Syagrus romanzoffiana | Queen Palm | 6 | 5 | 20 | 3 | Remove | Poor | 20 | |
| 39 | Bursera simaruba | Gumbo Limbo | 5 | 15 | 177 | | Remove | Fair | 177 | |
| 40 | Roystonea elata | Royal Palm | 18 | 15 | 177 | 15 | Remove | Fair | 177 | |
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| 43 | Swietenia mahagoni | Mahogany | 36 | 45 | 1,590 | | Remove | Fair | 1,590 | |
| 44 | Roystonea elata | Royal Palm | 18 | 15 | 177 | 15 | Remove | Fair | 177 | |
| OTAL CANO | PY SF TO BE MITIGATED | | <u> </u> | | | - | | | 7,693 | |

TREE INVENTORY NOTE: TREE LOCATIONS NOT PROVIDED WITH SURVEY. TREES IDENTIFIED VIA MOST CURRENT AERIAL IMAGERY, GOOGLE STREETVIEW AND FIELD OBSERVATIONS.

LEGEND




TREE/ PALM TO REMAIN. REFER TO TREE INVENTORY CHART ABOVE



TREE TO BE REMOVED/ RELOCATED. REFER TO TREE INVENTORY CHART ABOVE



TREE IDENTIFICATION NUMBER

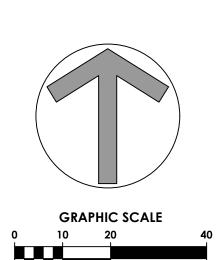

Sunshine

Call 811 or www.sunshine811.com two full business days before digging to have utilities located and marked.

Check positive response codes before you dig!

chen moore and associates

500 West Cypress Creek Road Suite 630 Ft. Lauderdale, FL 33309 **954.730.0707** www.chenmoore.com

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CLIENT

OAKLAND PARK DIXIE, LLC

PROJECT INFORMATION

SKY BUILDING

PROJECT NUMBER 20-487.001

CLIENT PROJECT NUMBER

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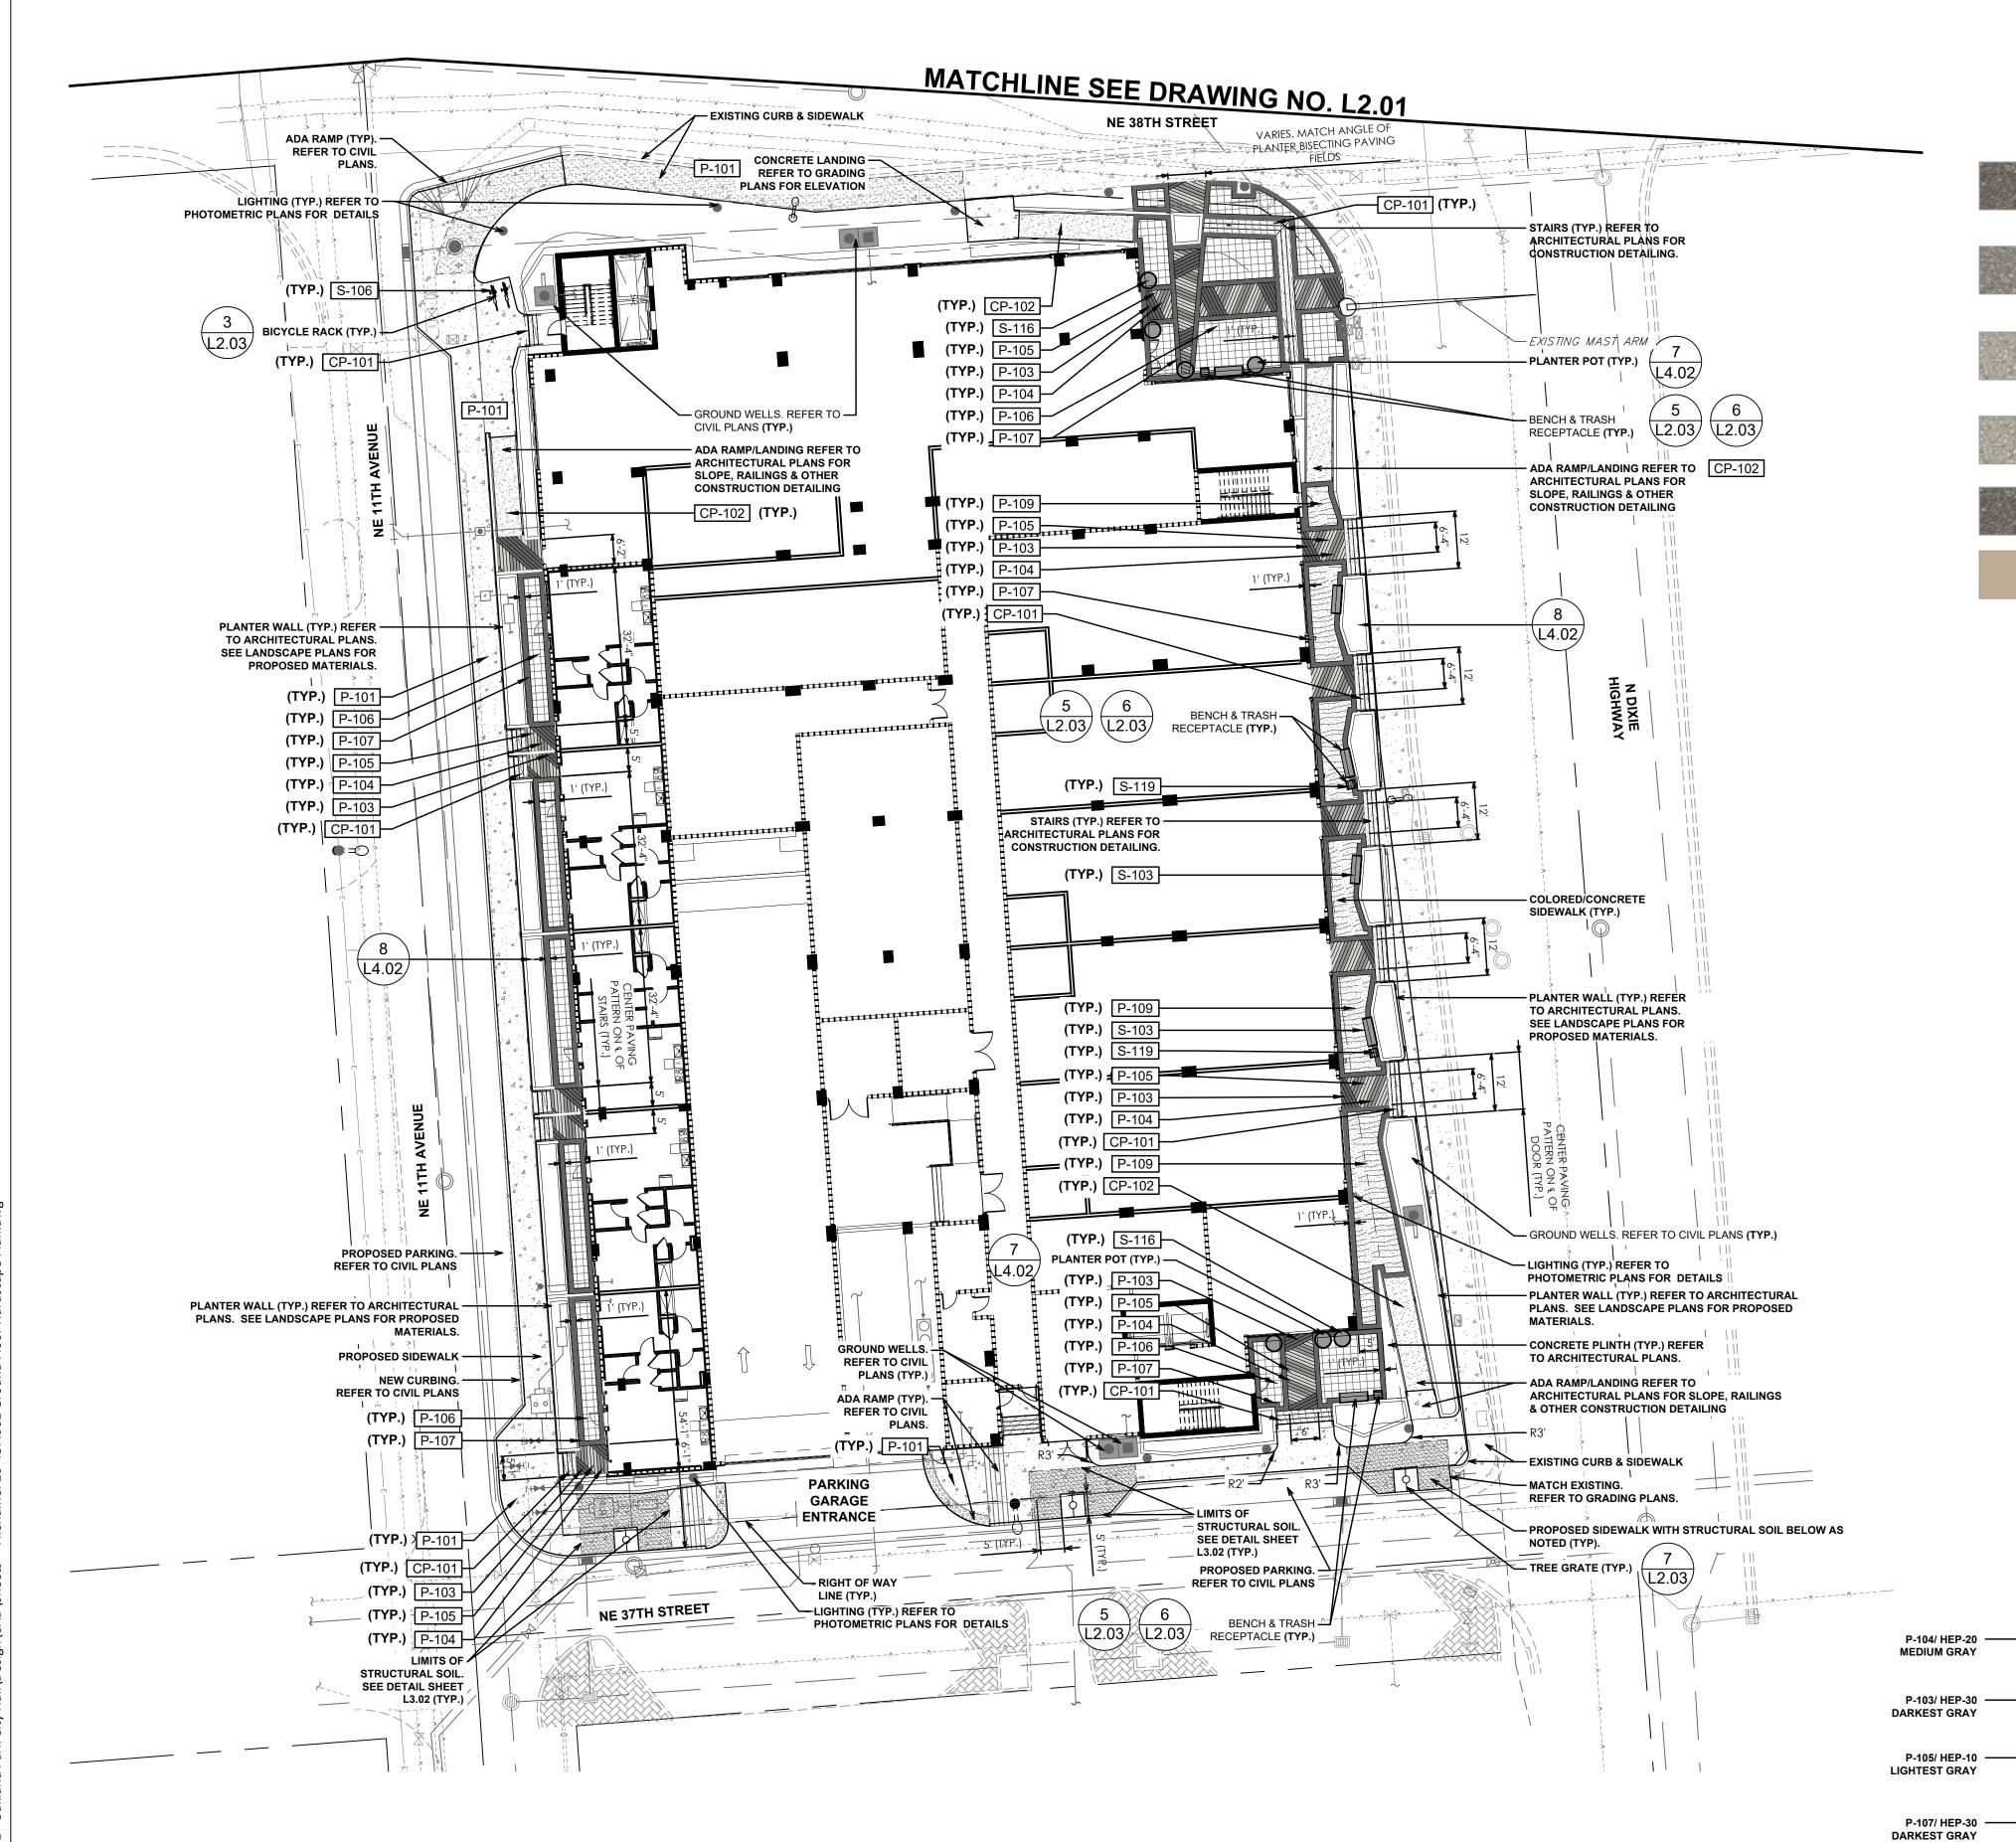
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Eł

DRAWING TITLE

TREE DISPOSITION PLAN



PAVING SCHEDULE

| SYMBOL | DESCRIPTION | QIY |
|--------|---|------------------|
| P-101 | 4" THICK (PEDESTRIAN) CONCRETE SIDEWALK. COLOR: NATURAL GRAY FINISH: LIGHT BROOM | 8,498 sf |
| P-103 | 4"X4"X2" ECO PREMIER PEDESTRIAN PAVERS COLOR: HEP-30 MANUFACTURER: WAUSAU TILE PATTERN: STACKED BOND | 802 sf |
| P-104 | 4"X4"X2" ECO PREMIER PEDESTRIAN PAVERS COLOR: HEP-20 MANUFACTURER: WAUSAU TILE PATTERN: STACKED BOND | 792 sf |
| P-105 | 4"X4"X2" ECO PREMIER PEDESTRIAN PAVERS COLOR: HEP-10 MANUFACTURER: WAUSAU TILE PATTERN: STACKED BOND | 801 sf |
| P-106 | 18"X18"X2" ECO PREMIER PEDESTRIAN PAVERS COLOR: HEP-10 MANUFACTURER: WAUSAU TILE | 3,071 sf |
| P-107 | 12"X12"X2" ECO PREMIER PEDESTRIAN PAVER COLOR: HEP-30 MANUFACTURER:WAUSAU TILE | 2,740 sf |
| P-109 | SOLACHROME COLORED CONCRETE COLOR: COOL TAUPE/WHITE CEMENT MANUFACTURER: SCOFIELD SR 0.475/SRI 56 | 3,316 sf |
| CP-101 | CONCRETE STAIR. REFER TO STRUCTURAL/ENGIN CONSTRUCTION DETAILING. | IEERING PLANS FC |

SITE FURNISHINGS SCHEDULE

COLOR: NATURAL GRAY

CONSTRUCTION DETAILING.

COLOR: NATURAL GRAY

FINISH: STIFF BROOM


| 2 | SYMBOL | DESCRIPTION | QTY |
|---|--------|---|-----|
| [| S-101 | 5`X5` TREE GRATE MANUFACTURER: IRONSMITH MODEL: ADA SQUARE OPENING: 24" FINISH: BLACK POWDER COAT | 3 |
| [| S-103 | 72" AIRI STIX BENCH BY ANOVA POWDER COATED ALUMINUM. COLOR TBD. | 13 |
| [| S-106 | MADRAX OPAL BIKE RACK COLOR: POWDER COAT STORM METALLIC MOUNTING: INGROUND | 5 |
| [| S-116 | 42" FIBERGLASS POT MANUFACTURER: OLD TOWN FIBERGLASS MODEL: BALBOA FINISH: GLOSS COLOR: TBD | 21 |
| [| S-119 | ANOVA 45 GALLON DUAL RECYCLER WITH SIDE DOOR MODEL AE2645RCT-STX | 8 |


COLOR:TBD

TYPICAL PAVING COLOR GUIDE DETAIL (N.T.S.)

CONCRETE RAMP. REFER TO STRUCTURAL/ENGINEERING PLANS FOR 1,278 sf

FINISH: STIFF BROOOM, PERPENDICULAR TO DIRECTION OF RAMP.

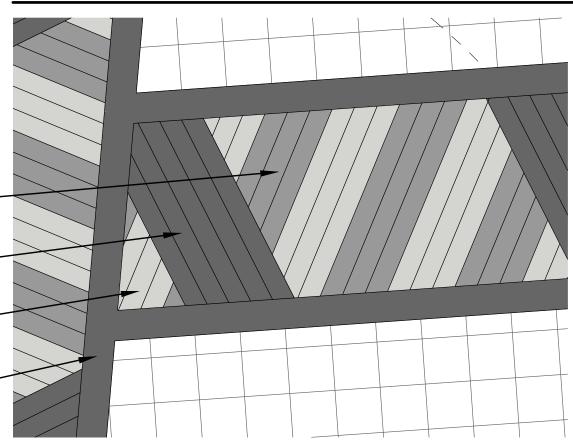

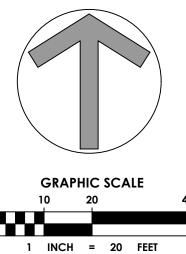



500 West Cypress Creek Road Suite 630 Ft. Lauderdale, FL 33309 **954.730.0707** www.chenmoore.com

REGISTRATION

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CLIENT PROJECT NUMBER

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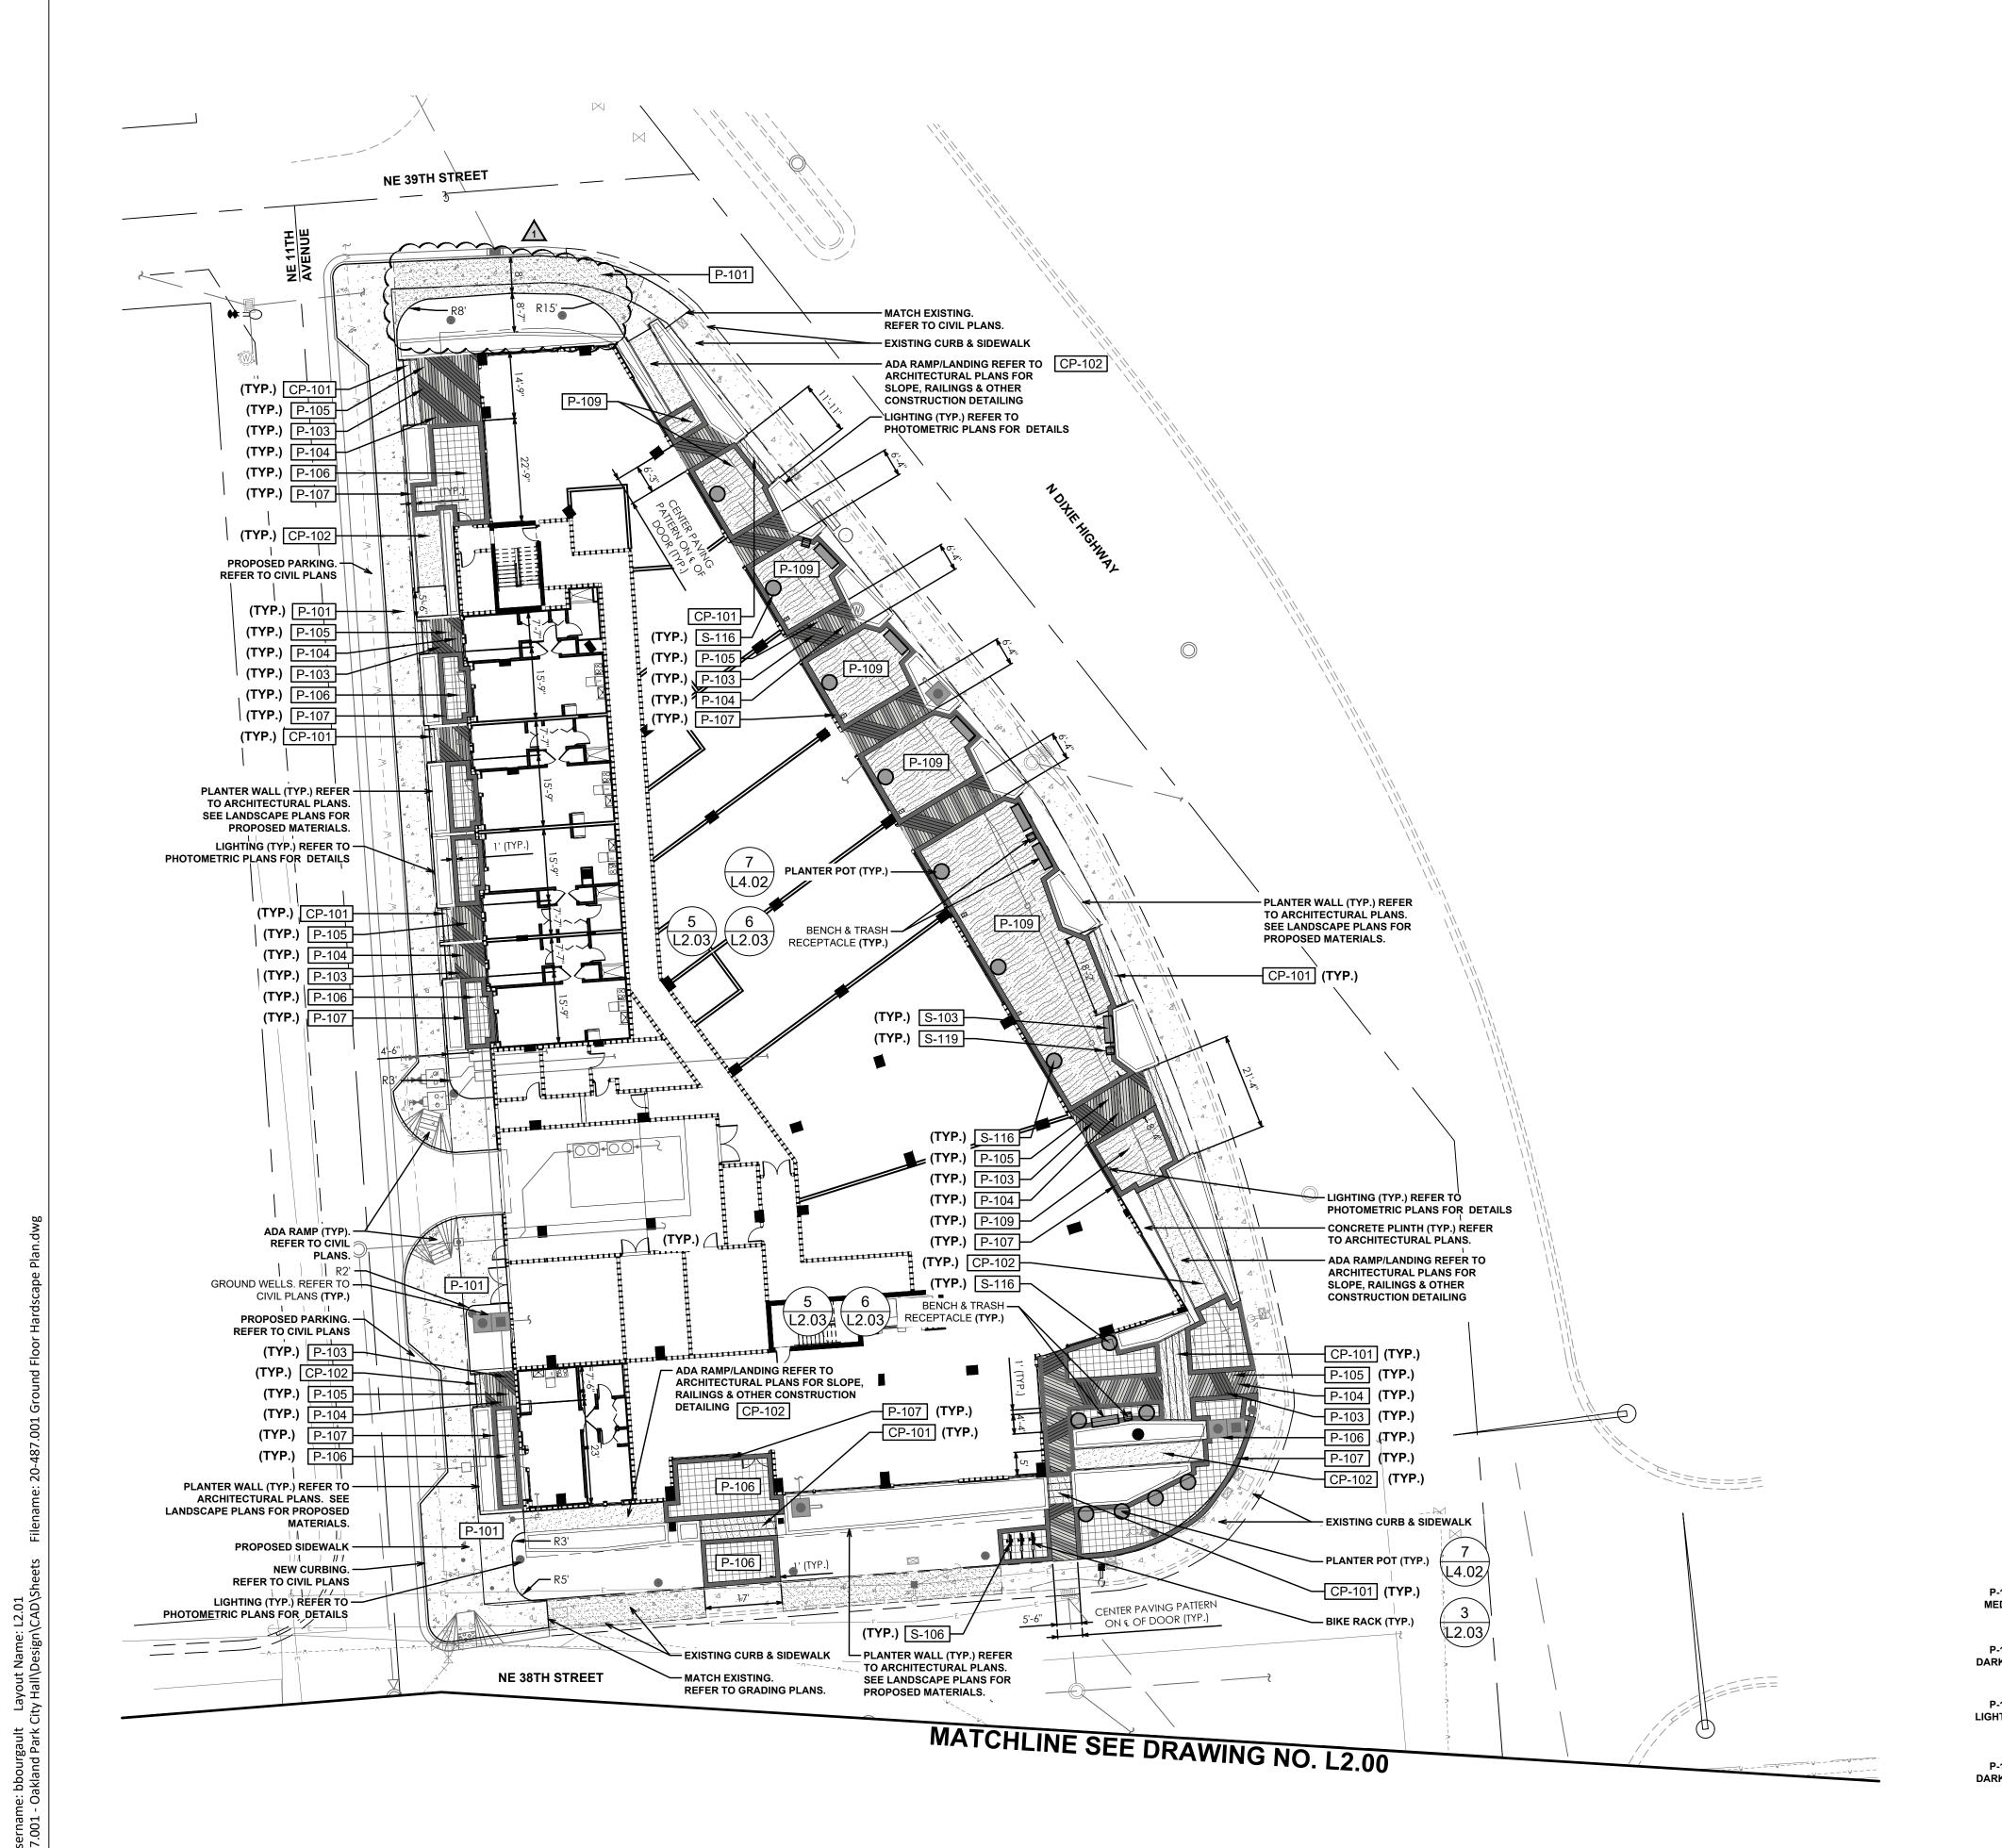
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GROUND FLOOR HARDSCAPE PLAN

L2.00




PAVING SCHEDULE

<u>SYMBOL</u> <u>DESCRIPTION</u> 4" THICK (PEDESTRIAN) CONCRETE SIDEWALK COLOR: NATURAL GRAY FINISH: LIGHT BROOM 4"X4"X2" ECO PREMIER PEDESTRIAN PAVERS COLOR: HEP-30 MANUFACTURER: WAUSAU TILE PATTERN: STACKED BOND 4"X4"X2" ECO PREMIER PEDESTRIAN PAVERS COLOR: HEP-20 MANUFACTURER: WAUSAU TILE PATTERN: STACKED BOND 4"X4"X2" ECO PREMIER PEDESTRIAN PAVERS COLOR: HEP-10 MANUFACTURER: WAUSAU TILE PATTERN: STACKED BOND 18"X18"X2" ECO PREMIER PEDESTRIAN PAVERS 3,071 sf COLOR: HEP-10 MANUFACTURER: WAUSAU TILE 12"X12"X2" ECO PREMIER PEDESTRIAN PAVER 2,740 sf COLOR: HEP-30 MANUFACTURER:WAUSAU TILE SOLACHROME COLORED CONCRETE 3,316 sf COLOR: COOL TAUPE/WHITE CEMENT MANUFACTURER: SCOFIELD SR 0.475/SRI 56 CONCRETE STAIR. REFER TO STRUCTURAL/ENGINEERING PLANS FOR 935 sf CONSTRUCTION DETAILING. COLOR: NATURAL GRAY FINISH: STIFF BROOM CONCRETE RAMP. REFER TO STRUCTURAL/ENGINEERING PLANS FOR 1,278 sf CONSTRUCTION DETAILING. COLOR: NATURAL GRAY FINISH: STIFF BROOOM, PERPENDICULAR TO DIRECTION OF RAMP.


SITE FURNISHINGS SCHEDULE

| SYMBOL | DESCRIPTION | QTY |
|--------|---|-----|
| S-101 | 5`X5` TREE GRATE MANUFACTURER: IRONSMITH MODEL: ADA SQUARE OPENING: 24" FINISH: BLACK POWDER COAT | 3 |
| S-103 | 72" AIRI STIX BENCH BY ANOVA POWDER COATED ALUMINUM. COLOR TBD. | 13 |
| S-106 | MADRAX OPAL BIKE RACK COLOR: POWDER COAT STORM METALLIC MOUNTING: INGROUND | 5 |
| S-116 | 42" FIBERGLASS POT MANUFACTURER: OLD TOWN FIBERGLASS MODEL: BALBOA FINISH: GLOSS COLOR: TBD | 21 |
| S-119 | ANOVA 45 GALLON DUAL RECYCLER WITH SIDE DOOR MODEL AE2645RCT-STX | 8 |

TYPICAL PAVING COLOR GUIDE DETAIL (N.T.S.)

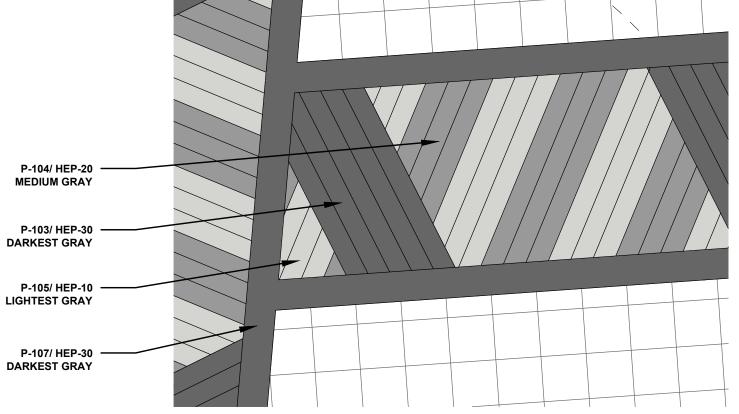

COLOR:TBD

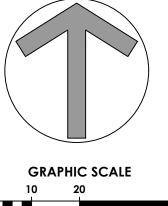

1 INCH = 20 FEET

DRC SUBMITTAL. NOT FOR CONSTRUCTION.



500 West Cypress Creek Road Suite 630 Ft. Lauderdale, FL 33309 954.730.0707 www.chenmoore.com

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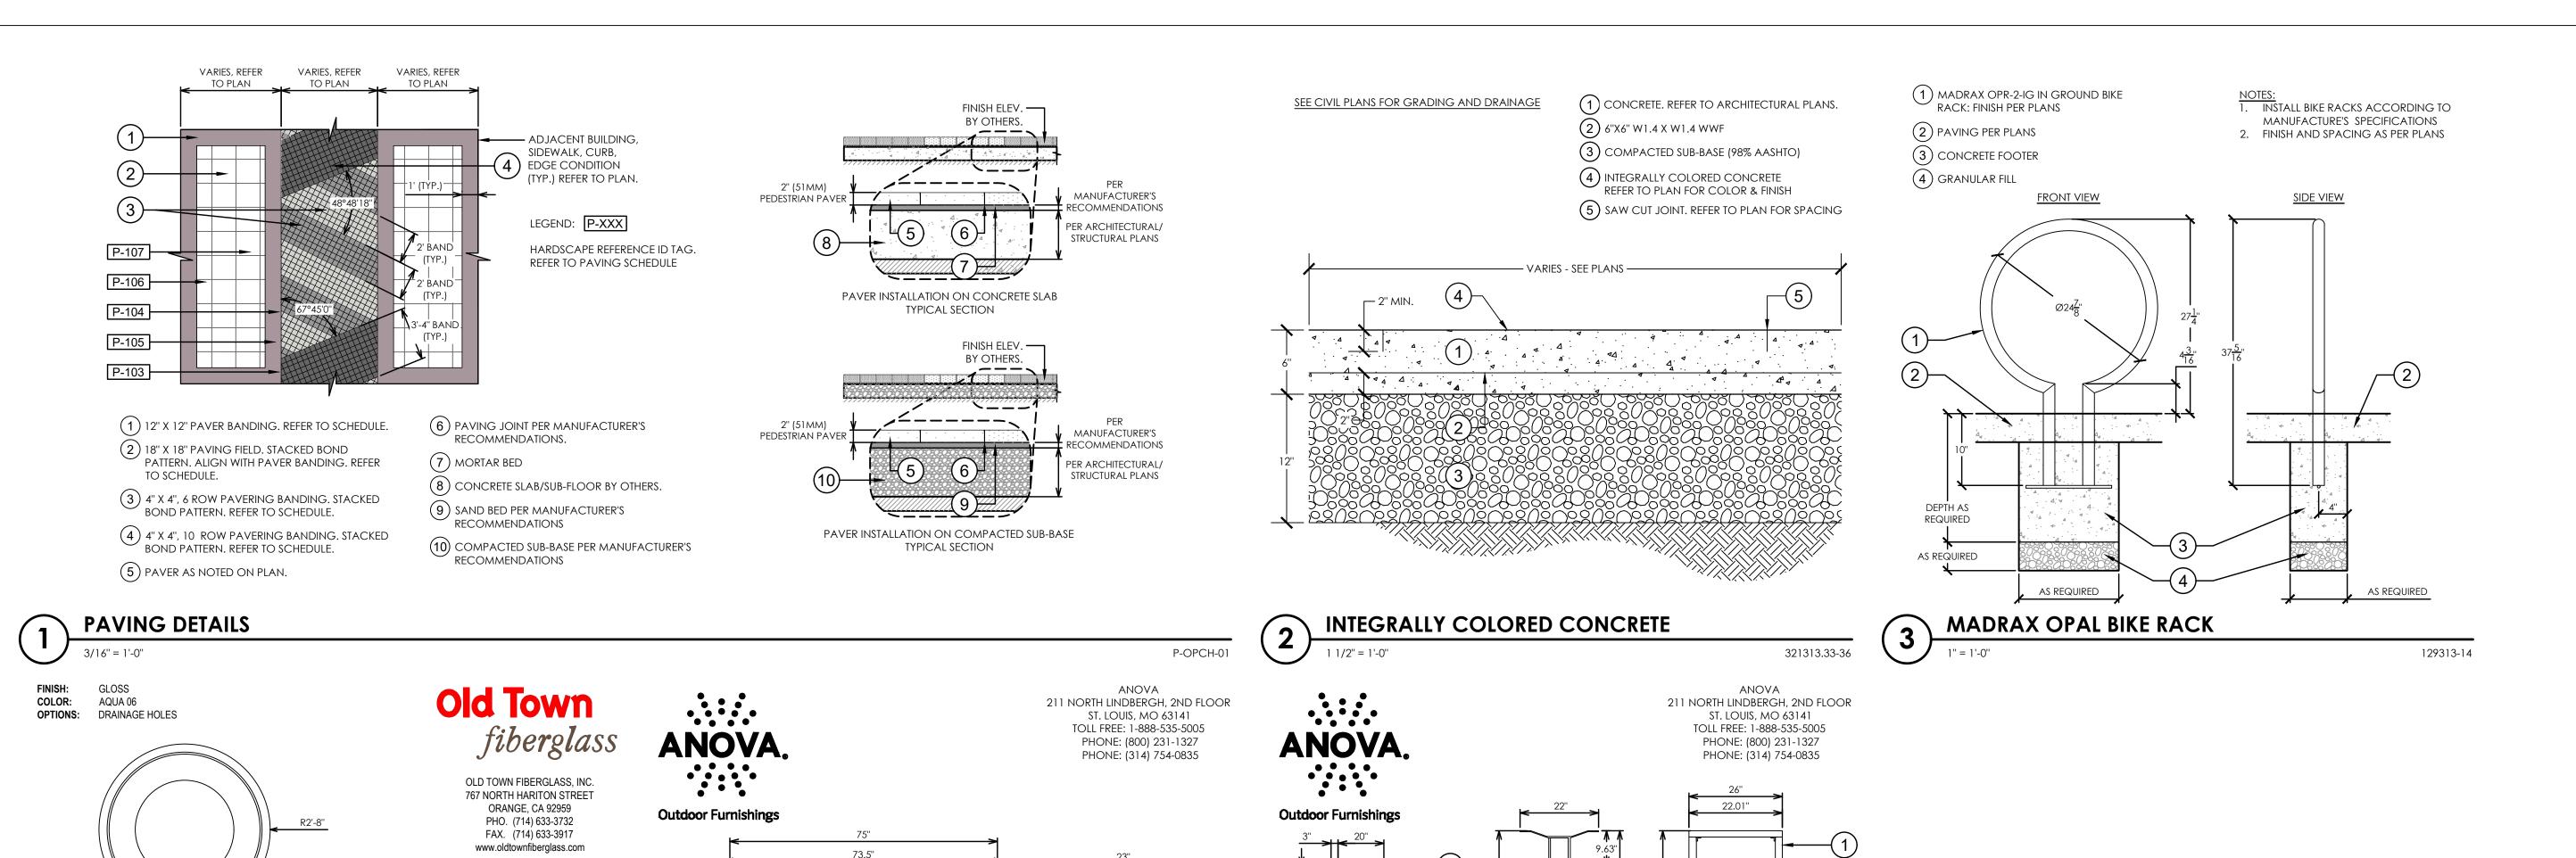
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GROUND FLOOR HARDSCAPE PLAN

L2.0



SURFACE MOUNT

52.24"

DOOR SWING

REFER TO PLAN FOR

THE WIND DESIGN CRITERIA PER FLORIDA BUILDING CODE, CURRENT EDITION.

129343.13-55

SIDE DOOR, CANOPY

MANUFACTURER'S SPECIFICATIONS

ANOVA AIRI STIX RECYCLER - MODEL AE2645RCT-STX

(2) SURFACE MOUNT, PER

WIDTH VARIES. REFER TO PLAN. SEE LANDSCAPE PLAN FOR PALETTE.

STRUCTURAL ENGINEER SHALL PROVIDE SIGNED & SEALED SHOP DRAWINGS FOR REINFORCEMENT REQUIRED FOR PLANTER WALLS. SHOP DRAWINGS SHALL BE SIGNED AND SEALED BY A REGISTERED ENGINEERING IN THE STATE OF FLORIDA DEPICTING

4 COMPACTED SUB-BASE, BY OTHERS

P-SW-04

FRONT ELEVATION

ANOVA 6' AIRI STIX BENCH - MODEL AE2680STX

(1) AIRI STIX 6' CONTOUR BENCH, REFER TO PLAN FOR COLOR.

(2) SURFACE MOUNT, PER MANUFACTURER'S SPECIFICATIONS

1) PLANTER WALL WITH SMOOTH STUCCO FINISH.

GRADING PLANS, BY OTHERS.

(10) FINISH GRADE.

(2) SIDEWALK, PAVERS OR SURFACING. REFER TO PLANS. SLOPE PER

(4) SEPARATION MEMBRANE PER ARCHITECTURAL PLANS AND DETAILS.

(7) underground drip irrigation. Refer to irrigation plans

(9) PLANTER DRAINAGE INLET. REFER TO MEP PLANS FOR NUMBER OF REQUIRED INCLETS, SIZING AND CONNECTION INTO DRAINAGE

(12) POST-TENSION CONCRETE SLAB. REFER TO STRUCTURAL PLANS.

(13) Slope planter floor at 1% towards drain. Refer to mep plans

PLANTER WALL WITH DRAINAGE DETAIL

(3) SLOPE TOP OF WALL 1% TOWARD PLANTER FOR DRAINAGE

 $(\,5\,)$ Drainage medium by rooflite or approved equal.

(6) PLANTING MEDIUM. REFER TO PLANTER SOIL DETAIL.

(8) DRAINAGE INLET COVER. REFER TO MEP PLANS.

(11) MULCH, REFER TO LANDSCAPE PLANS.

(3) CONCRETE SLAB, BY OTHERS

P-SW-07

IRONSMITH

41-701 CORPORATE WAY, #3 PALM DESERT, CA 92260

(800) 338-4766

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60" X 60"" UNFINISHED CAST IRON TREE GRATE IN TWO SECTIONS

(PEDESTRIAN LOAD ONLY).

(3) 30" X 60" TREE GRATE SECTION.

(4) 1/2" SLOT MAXIMUM OPENING.

(5) 1/2" X 1" X 1/4" THICK GRINDING PADS FOR LEVELING - TYP. 4 OR

(6) 1-3/4" x 1-3/4" X 1/4" STEEL ANGLE

(8) ADJACENT SIDEWALK. REFER TO

9 PLANTING MEDIUM. REFER TO LANDSCAPE PLAN.

SQUARE TREE GRATE FRAME IRONSMITH MODEL # M4800F

(7) 1/2" NELSON STD WELDED TO

(2) 24" TREE OPENING.

MORE PLACES.

CIVIL PLANS.

(4) COMPACTED SUB-BASE, BY OTHERS

5'-4''

OLDTOWN FIBERGLASS 64" URN (BALBOA)

ELEVATION

ELEVATION VIEW

TREE GRATE 60 X60



20-487.001

CLIENT PROJECT NUMBER

PROJECT NUMBER

500 West Cypress Creek Road

Suite 630

Ft. Lauderdale, FL 33309

954.730.0707

www.chenmoore.com

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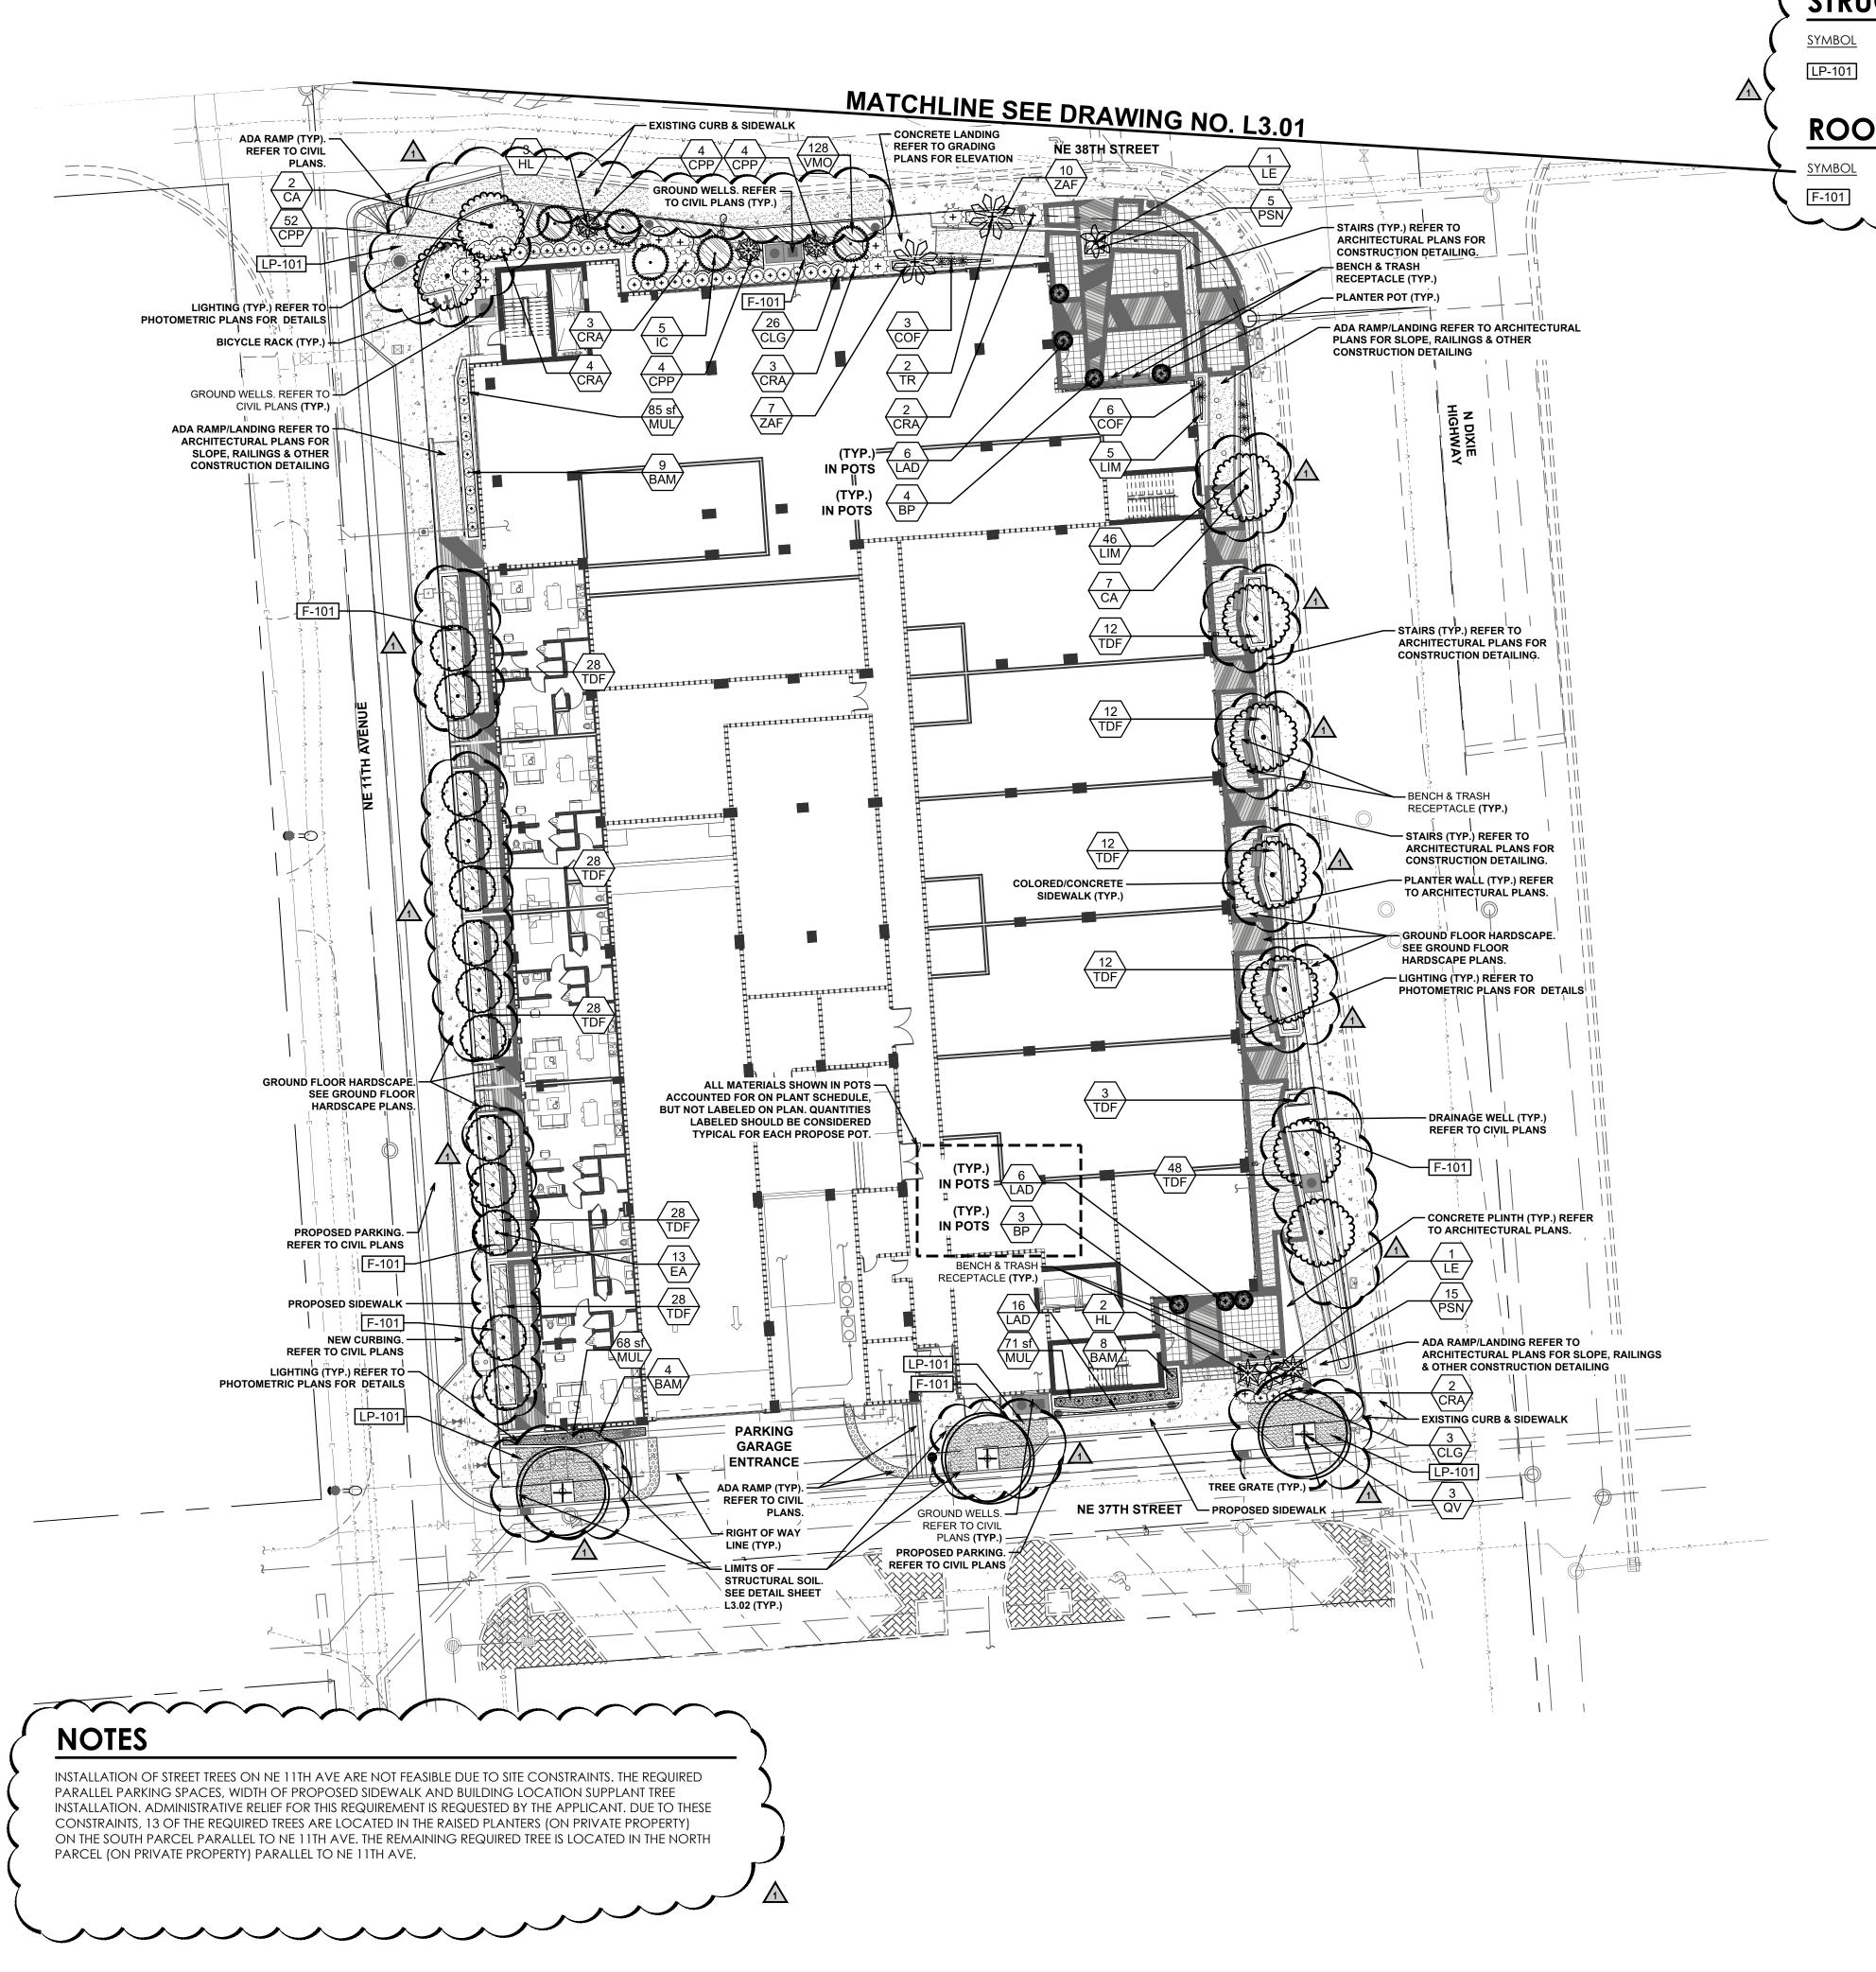
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GROUND FLOOR HARDSCAPE DETAILS

L2.02



STRUCTURAL SOIL SCHEDULE

 $\sim\sim\sim\sim$

<u>DESCRIPTION</u> CU-STRUCTURAL SOIL 264.16 cy

ROOT BARRIER SCHEDULE

<u>DESCRIPTION</u> <u>QTY</u> ROOT BARRIER 96 If

GROUND LEVEL PLANT LEGEND

CODE COMMON NAME Yesterdsay, Today & Tomorrow

Dahoon Holly

CODE COMMON NAME

Bottle Palm

Licuala Palm

SS3 Cabbage Palmetto Florida Thatch Palm

STREET TREE COMMON NAME Autograph Tree CA

QV Highrise Oak <u>SHRUBS</u> <u>CODE</u> COMMON NAME

White Stopper

Small Leaf Clusia

CRA Queen Emma Crinum Lily

Golden Goddess Hedge Bamboo

Pink Pepper Ti Plant

CODE COMMON NAME

CPP Petra Croton PSN Wild Coffee

Dwarf Fakahatchee Grass

VMO Mrs. Schillers Delight Walter`s Viburnum

Coontie Palm

CODE COMMON NAME

Depressed Shrubverbena

CODE COMMON NAME

LIM

MUL MULCH

Lilyturf

GRAPHIC SCALE 1 INCH = 20 FEET

500 West Cypress Creek Road Suite 630 Ft. Lauderdale, FL 33309 954.730.0707 www.chenmoore.com

REGISTRATION

CRISTOBAL A. BETANCOURT, RLA REGISTRATION NO. 6666941 DATE: <u>5/6/2021</u>



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CLIENT

OAKLAND PARK DIXIE, LLC

PROJECT INFORMATION

SKY BUILDING

PROJECT NUMBER 20-487.001

CLIENT PROJECT NUMBER

VERIFY SCALES

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REVISIONS

⚠ DRC COMMENTS

DATE OF ISSUE 03.18.2021


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DRAWING TITLE

GROUND FLOOR LANDSCAPE **PLAN**



STRUCTURAL SOIL SCHEDULE GROUND LEVEL PLANT LEGEND

DESCRIPTION CU-STRUCTURAL SOIL 264.16 cy

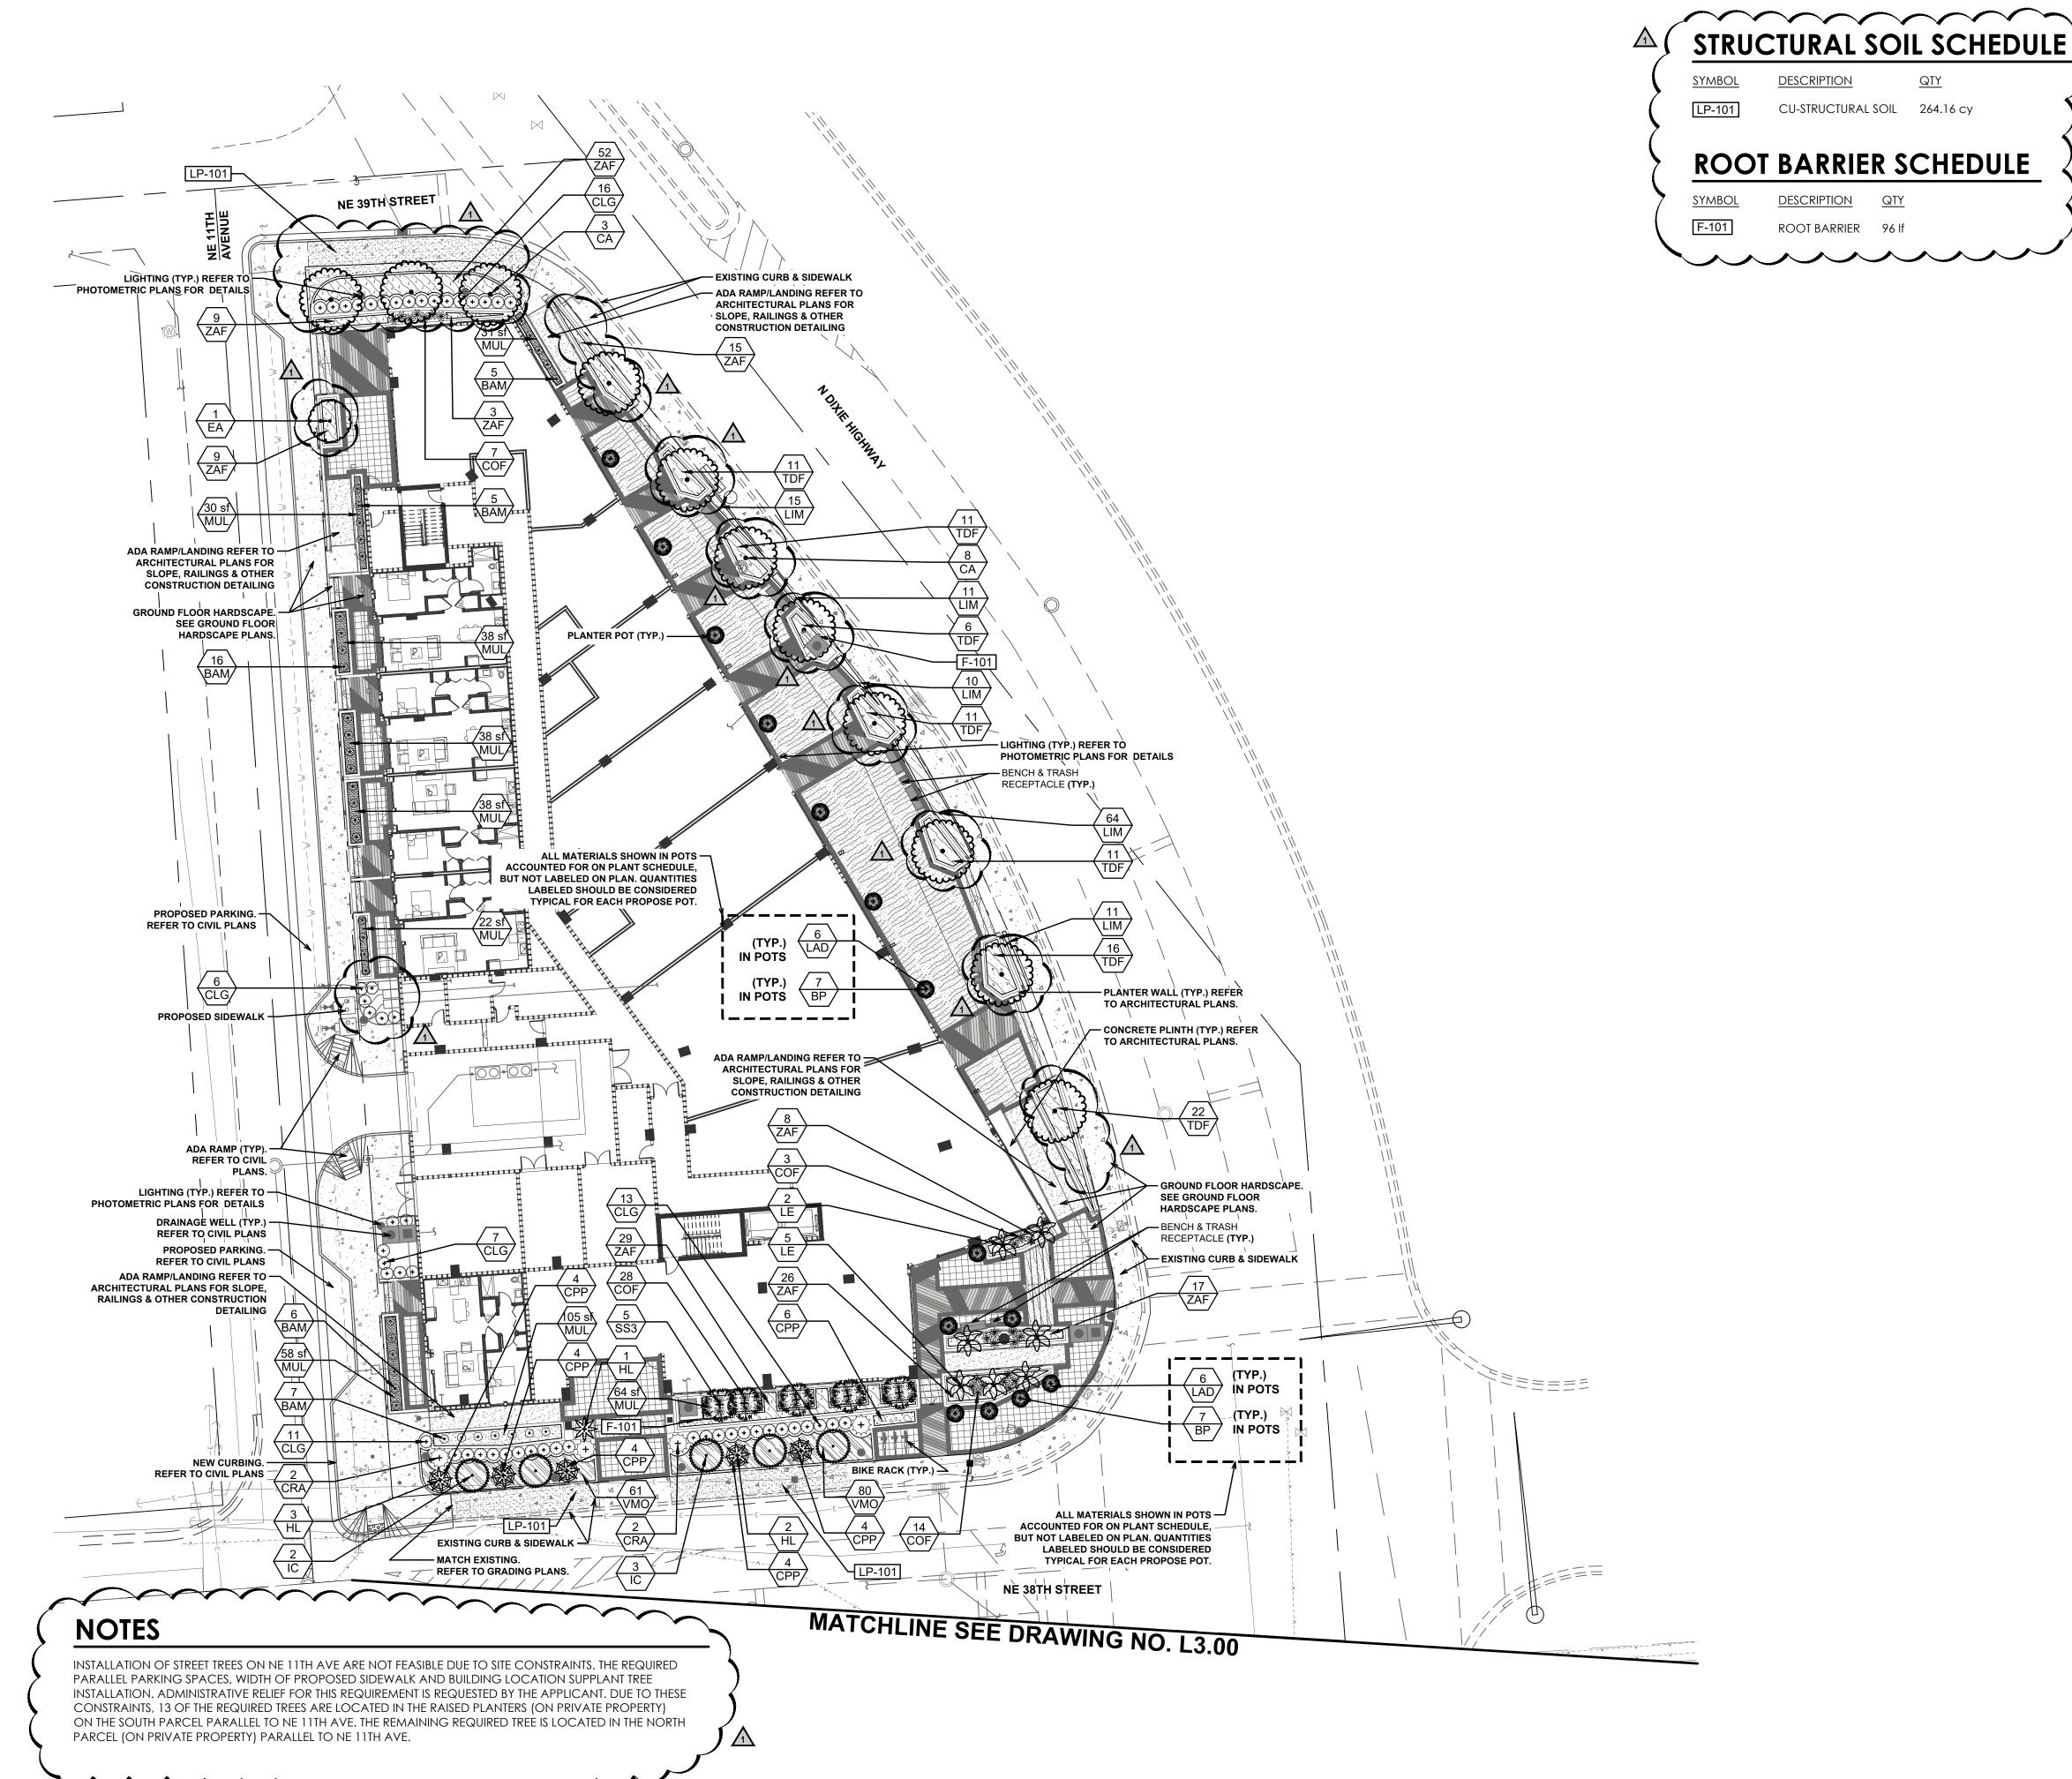ROOT BARRIER SCHEDULE

<u>DESCRIPTION</u> <u>QTY</u>

CODE COMMON NAME

Yesterdsay, Today & Tomorrow

Dahoon Holly

CODE COMMON NAME

Bottle Palm Licuala Palm

SS3 Cabbage Palmetto

Florida Thatch Palm COMMON NAME

CA Autograph Tree White Stopper EΑ Q٧

CODE COMMON NAME <u>SHRUBS</u>

Golden Goddess Hedge Bamboo

Highrise Oak

Pink Pepper Ti Plant

Small Leaf Clusia

CRA Queen Emma Crinum Lily

CODE COMMON NAME CPP Petra Croton

PSN Wild Coffee

VMO Mrs. Schillers Delight Walter`s Viburnum

Dwarf Fakahatchee Grass

Coontie Palm

CODE COMMON NAME

Depressed Shrubverbena

MULCH

LIM Lilyturf

CODE COMMON NAME

MUL

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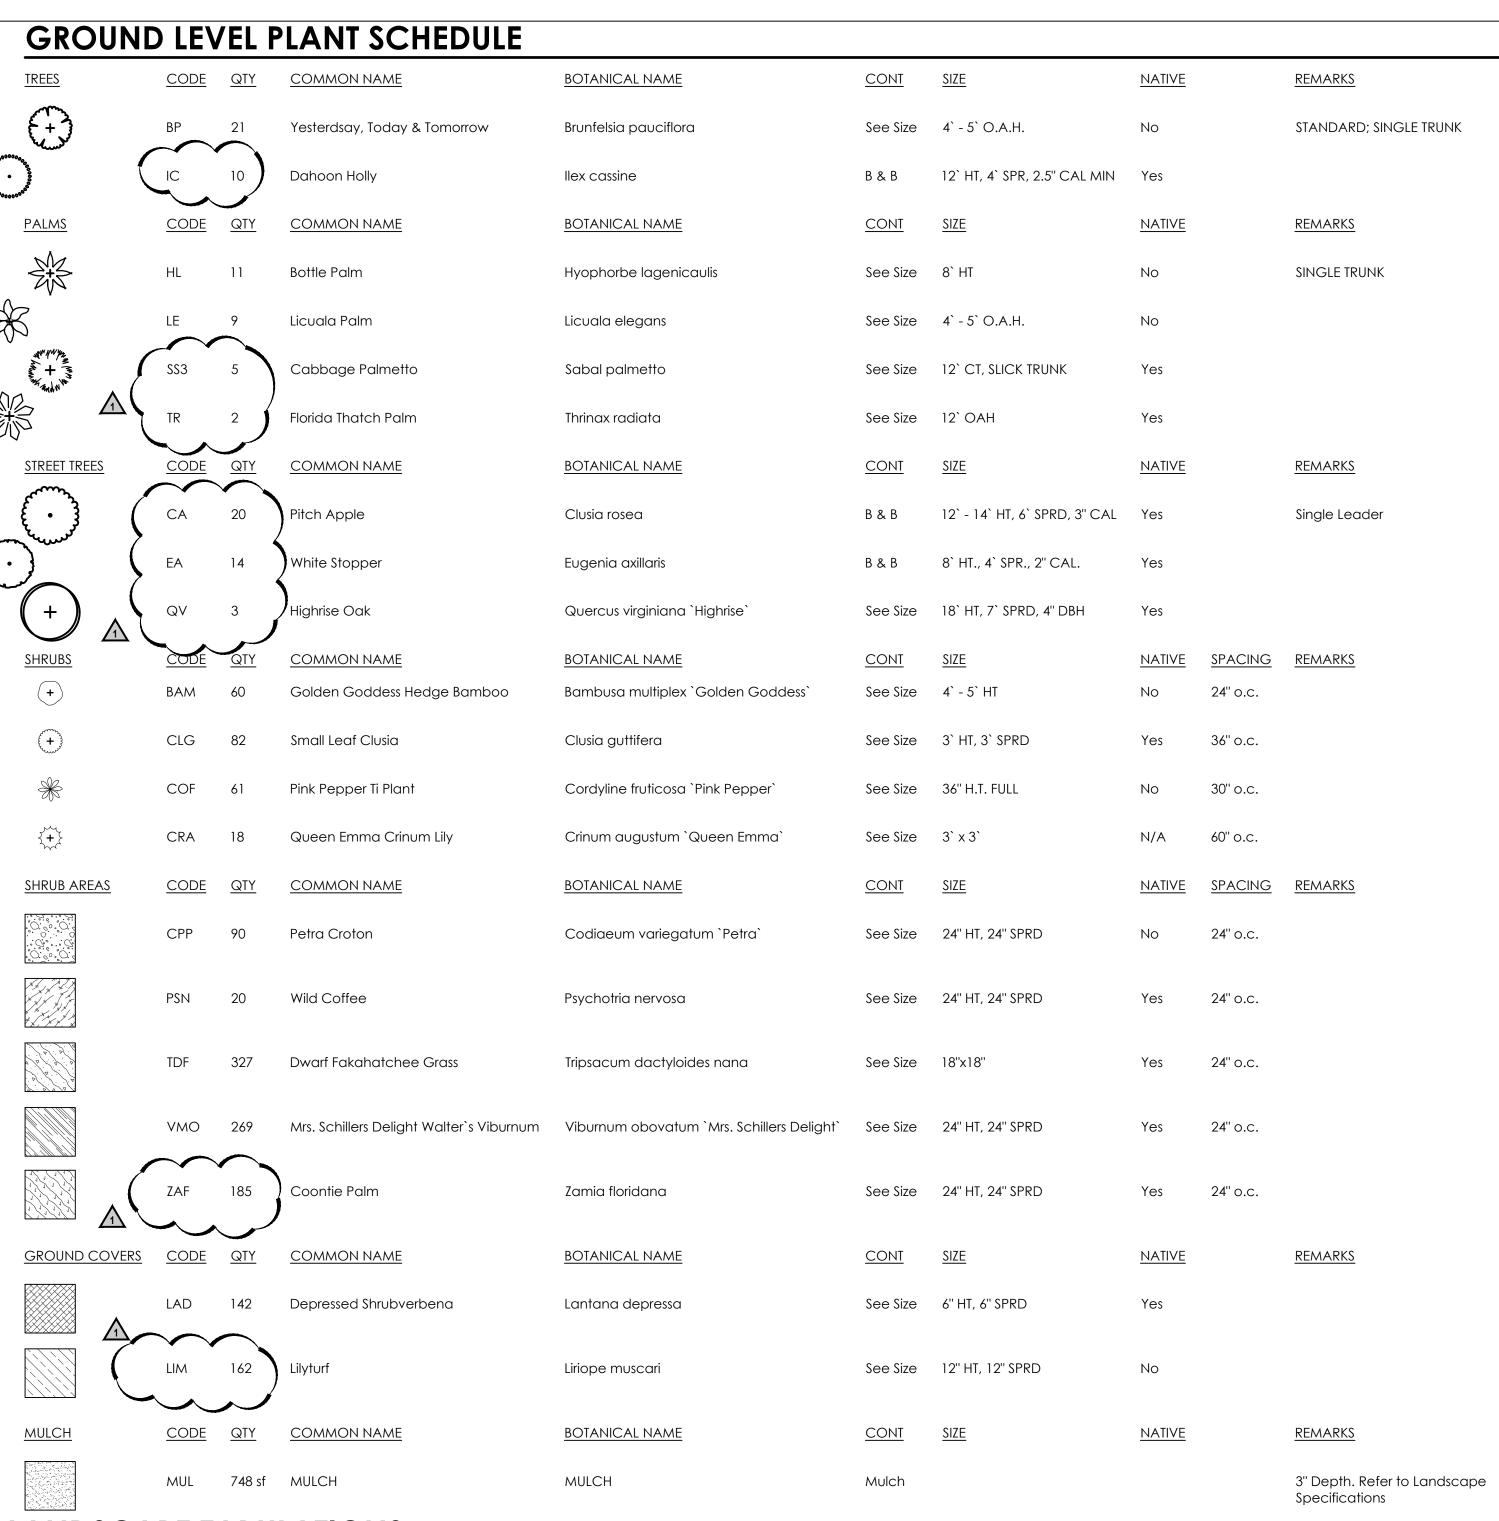
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GROUND FLOOR

7 OF OAKLAND MIXED USE



NATIVE PLANT SPECIES AND MITIGATION CALCULATIONS

| | Code | Quantity | Common | Native Total | Non-Nativ e Total | Drought Tolerance |
|---|--------------|----------|---|--------------|----------------------|----------------------|
| TREES | | | | | | |
| | BP C | 25 | Yesterday, Today & Tomorrow | | 25 | Moderate |
| Λ (| IC | 10 | Dahoon Holly | 10 | | High |
| | QV | 3 | Highrise Oak | 3 |) | High |
| | CA | 20 | Pitch Apple | 20 | | High |
| | EA | 14 | White Stopper | 14 |) | High |
| | | | Silver Buttonwood | 4 | | High |
| | LJ | 4 | Japanese Privet | | 4 | Moderate |
| | AM | 5 | Double Christmas Palm | | 5 | Moderate |
| | HL | 16 | Bottle Palm | | 16 | Moderat |
| | LE | 9 | Licuala Palm | | 9 | Moderate |
| | PE | 2 | Alexander Palm | | 2 | High |
| | TR | 6 | Florida Thatch Palm | 6 | | High |
| | SS/ SS3/ SS4 | 5 | Cabbage Palm | 5 | 1 | High |
| Percent Native | | | ^ ^ | 50% | | |
| SHRUBS | | | | | | |
| | BAM | 60 | Golden Goddess Hedge Bamboo | | 60 | Moderate |
| | CLG | 82 | Clusia | 82 | | High |
| | COF | 84 | Pink Pepper Ti Plant | | 84 | Moderate |
| | CRA | 23 | Queen Emma Crinum Lily | | 23 | Moderate |
| | AFA | 11 | African Lily | | 11 | High |
| | FIM | 65 | Green Island Ficus | | 65 | High |
| | TDF | 327 | Dwarf Fakahatchee Grass | 327 | | High |
| <u> </u> | ZAF | 219 | Coontie | 219 | | High |
| | LAD | 154 | Lantana Depressa | 154 | | High |
| A { | LIM | 189 | Lilyturf | | 189 | Moderate |
| | CPP | 90 | Petra Croton | | 90 | Moderate |
| | PSN | 20 | Wild Coffee | 20 | | High |
| | VMO | 269 | Mrs. Schillers Delight Walter's Viburnum | 269 | | High |
| | TRA | 154 | Asian Jasmine | | 154 | High |
| Percent Native | | | | 62% | | |
| Total Native Tree | 25 | | | 62 | | |
| Total Non-Native | | | | 61 | \ | |
| . J. C. | | | | | | |
| | ubs | | | 1,071 | | |
| Total Native Shru | J. 1.0 G | | | | | |

AMENITY DECK LANDSCAPE INCLUDED IN CALCULATIONS ABOVE.

PROPOSED NORTH BUILDING: 8.76% PROPOSED SOUTH BUILDING: 5.81%

SPECIFICATION, SHEET L3.04 FOR MULCH REQUIREMENTS.

LANDSCAPING AND PERVIOUS CALCULATIONS:

INSTALLATION OF CYPRESS MULCH IS PROHIBITED BY CITY OF OAKLAND PARK. REFER TO MULCH

| | Canopy SF Per Broward County Mitigation Standards | Mitigation (SF) |
|---|--|--------------------|
| | TREES | |
| | N/A | N/A |
| | Category 2 (150 SF) | 1,500 |
| | Category 1 (300 SF) | 900 |
| | Category 1 (300 SF) | 6,000 |
| | Category 3 (100 SF) | 1,400 |
| | Category 2 (150 SF) | 600 |
| | Category 2 (150 SF) | 600 |
| | Category 4 (50 SF) | 250 |
| | Category 4 (50 SF) | 800 |
| | Category 4 (50 SF) | 450 |
| | Category 4 (50 SF) | 100 |
| | Category 4 (50 SF) | 300 |
| | Category 3 (100 SF) | 500 |
| S | · · | ノノ |
| _ | | |

TOTAL MITIGATION (SF)

Proposed Tree Canopy

Proposed Tree Canopy

Removal

Net Difference

500 West Cypress Creek Road Ft. Lauderdale, FL 33309 www.chenmoore.com **REGISTRATION** CRISTOBAL A. BETANCOURT, RLA REGISTRATION NO. 6666941 13,400

7,693

5,707

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LANDSCAPE **SCHEDULE AND CALCULATIONS**

DRAWING NUMBER

| LANDSCAPE | TABULATIONS |
|------------------|--------------------|
| | |

| Section | Code Application | Area/LF/# | Required | Provided | Notes |
|---------------|---|-----------|----------|--------------|-----------------|
| 1.A.3 Plant I | Material | | | | |
| В | Minumum HT for trees shall be 8' for small species, 10' for medium and large species, and 8' CT for palms | N/A | N/A | Acknowledged | |
| С | All trees shall have a minimum 4.5' spread and minumum 1.5" caliper | N/A | N/A | Acknowledged | |
| D | Palms shall be planted in groups of 3 to count as 1 tree, with staggered heights at 10', 12' and 14' CT | 3 = 1 | N/A | Acknowledged | |
| 1.A.8 Offset | s | | | | |
| В | Trees/palms to be planted 5' from underground utilities and catch basins, and 7.5' from fire hydrants | N/A | N/A | Acknowledged | |
| С | Trees/palms to be planted 4' from face of curb along roadways, and 3' from sidewalks | N/A | N/A | Acknowledged | |
| F | Large trees/palms to be planted 10' from building foundations/wall structures | 10' | 10' | 10' | |
| 1.A.13 Stree | t Trees | | | | |
| | 1 street tree shall be required for every 40 linear feet | | | | |
| | NE 39th Street | 63 | 2 | 4 Trees | |
| ٨ | NE 11th Avenue | 557 | 14 | 14 Trees | |
| Α | NE 38th Street | 373 | 9 | 13 Trees | |
| | NE 37th Street | 192 | 5 | 3 Trees | Site Constraint |
| | N Dixie Highway | 536 | 13 | 15 Trees | |

| | 1 tree shall be planted for every 40 linear feet | | | | |
|-------|--|-----|----|----------|----------------|
| | North Perimeter (North Parcel) | 63 | 2 | 4 Trees | |
| | North Perimeter (South Parcel) | 174 | 4 | 8 Trees | |
| | East Perimeter (North Parcel) | 266 | 7 | 8 Trees | |
| A.i | East Perimeter (South Parcel) | 269 | 7 | 7 Trees | |
| | South Perimeter (North Parcel) | 199 | 5 | 5 Trees | |
| | South Perimeter (South Parcel) | 192 | 5 | 3 Trees | Site Constrain |
| | West Perimeter (North Parcel) | 291 | 7 | 1 Tree | Site Constrain |
| | West Perimeter (South Parcel) | 266 | 7 | 13 Trees | |
| | 1 shrub for every 5 feet of wall may be planted in lieu of a hedge | | | | |
| | North Perimeter (North Parcel) | 30 | 6 | 87 | |
| | North Perimeter (South Parcel) | 129 | 26 | 248 | |
| | East Perimeter (North Parcel) | 248 | 50 | 219 | |
| A.iii | East Perimeter (South Parcel) | 259 | 52 | 161 | |
| | South Perimeter (North Parcel) | 195 | 39 | 331 | |
| | South Perimeter (South Parcel) | 179 | 36 | 48 | |
| | West Perimeter (North Parcel) | 264 | 53 | 49 | |
| | West Perimeter (South Parcel) | 264 | 53 | 149 | |

DRC SUBMITTAL. NOT FOR CONSTRUCTION.

- 1.1. WORK PERFORMED SHALL COMPLY WITH THE FOLLOWING:
- THESE GENERAL NOTES, CONSTRUCTION DOCUMENTS AND SPECIFICATIONS.
- ALL APPLICABLE LOCAL, STATE AND FEDERAL CODES, ORDINANCES AND REGULATIONS. 1.2. SOURCE OF BASE INFORMATION PROVIDED BY ZYSCOVICH PLANNING, ARCHITECTURE & INTERIOR DESIGN ON 12/04/2020 AND IS ASSUMED TO BE CORRECT. IF SITE DISCREPANCIES ARE PRESENT, CONTRACTOR SHALL NOTIFY OWNER'S REPRESENTATIVE IMMEDIATELY. IF CONTRACTOR CONTINUES WORK WITHOUT THE PROPER NOTIFICATION, CONTRACTOR DOES SO AT HIS OWN RISK.
- 1.3. THE CONTRACTOR SHALL FURNISH ALL MATERIALS, LABOR, SUPERVISION, AND EQUIPMENT REQUIRED FOR THE WORK AS SHOWN ON THE CONSTRUCTION DOCUMENTS DESCRIBED HEREIN.
- 1.4. CONTRACTOR SHALL BE RESPONSIBLE FOR ANY COORDINATION WITH SUB-CONTRACTORS AS REQUIRED TO COMPLETE THE WORK OF THIS PROJECT.
- 1.5. CONTRACTOR SHALL VERIFY LOCATIONS OF PERTINENT SITE IMPROVEMENTS INSTALLED UNDER OTHER CONTRACTS. IF ANY PART OF THIS PLAN CANNOT BE FOLLOWED DUE TO SITE CONDITIONS, CONTACT OWNER'S REPRESENTATIVE FOR INSTRUCTIONS PRIOR TO COMMENCING WORK.
- 1.6. CONTRACTOR TO NOTIFY "SUNSHINE STATE ONE CALL OF FLORIDA, INC." AT 1-800-432-4770 TWO FULL BUSINESS DAYS PRIOR TO DIGGING FOR UNDERGROUND UTILITY LOCATIONS.
- 1.7. CONTRACTOR IS RESPONSIBLE FOR DETERMINING ALL UTILITY LOCATIONS AND INSTALLING FACILITIES SO AS TO NOT CONFLICT. THE LOCATION OF EXISTING UTILITIES OR SITE FEATURES AS SHOWN ON THE PLANS MAY VARY IN RELATION TO ACTUAL EXISTING CONDITIONS. ANY DIFFERING SITE CONDITIONS FROM THAT WHICH IS REPRESENTED HEREON, WHETHER ABOVE, ON OR BELOW THE SURFACE OF THE GROUND, SHOULD BE BROUGHT TO THE IMMEDIATE ATTENTION OF THE LANDSCAPE ARCHITECT AND THE OWNER IN WRITING. NO CLAIM FOR EXPENSES INCURRED BY THE CONTRACTOR DUE TO DIFFERING SITE CONDITIONS WILL BE ALLOWED IF THE CONTRACTOR FAILS TO PROVIDE THE REQUIRED WRITTEN NOTIFICATION OF SUCH CONDITIONS FOR REVIEW BY THE LANDSCAPE ARCHITECT AND THE OWNER.
- 1.8. CONTRACTOR SHALL NOTIFY ALL APPROPRIATE UTILITY COMPANIES OF PROPOSED START OF WORK IN ACCORDANCE WITH THEIR STANDARD REQUIREMENTS, INCLUDING BUT NOT LIMITED TO, WATER, SANITARY SEWER, POWER, NATURAL GAS, TELEPHONE AND CABLE TV COMPANIES.
- 1.9. IT SHALL BE THE CONTRACTOR'S SOLE RESPONSIBILITY TO TAKE THE NECESSARY PRECAUTIONS TO ENSURE PROPER SAFETY AND WORKMANSHIP WHEN WORKING IN THE VICINITY OF EXISTING UTILITY LINES.
- 1.10. PERFORM EXCAVATION IN THE VICINITY OF UNDERGROUND UTILITIES WITH CARE AND BY HAND, IF NECESSARY. THE CONTRACTOR BEARS FULL RESPONSIBILITY FOR THIS WORK AND DISRUPTION OF DAMAGE TO UTILITIES SHALL BE REPAIRED IMMEDIATELY AND AT NO EXPENSE TO THE OWNER.
- 1.11. THE SUCCESSFUL BIDDER SHALL FURNISH TO THE OWNER A UNIT PRICE BREAKDOWN FOR ALL MATERIALS. THE OWNER MAY, AT ITS DISCRETION, ADD OR DELETE FROM THE MATERIALS UTILIZING THE UNIT PRICE BREAKDOWN SUBMITTED.
- 1.12. IT IS THE RESPONSIBILITY OF THE CONTRACTOR TO ENSURE THAT ALL REQUIRED PERMITS ARE OBTAINED AND ARE IN HAND AT THE JOB SITE PRIOR TO THE COMMENCEMENT OF CONSTRUCTION. CONTRACTOR SHALL ABIDE BY ALL PERMIT CONDITIONS.

2. PRE-CONSTRUCTION RESPONSIBILITY

- 2.1. UPON RECEIPT OF NOTICE OF AWARD, THE CONTRACTOR SHALL ARRANGE A PRE-CONSTRUCTION CONFERENCE TO INCLUDE ALL INVOLVED GOVERNMENTAL AGENCIES, ALL AFFECTED UTILITY OWNERS, THE OWNER, THE LANDSCAPE ARCHITECT, ANY OTHER PERTINENT PARTIES AND HIMSELF
- 2.2. CONTRACTOR SHALL PROVIDE TEMPORARY SANITARY FACILITIES ONSITE. LOCATION TO BE DETERMINED BY THE OWNER, JANITORIAL SERVICES SHALL BE PROVIDED BY CONTRACTOR THROUGHOUT THE DURATION OF PROJECT.
- 2.3. PRIOR TO BEGINNING CONSTRUCTION, THE CONTRACTOR SHALL VERIFY THE SIZE, LOCATION, ELEVATION, AND MATERIAL OF ALL EXISTING UTILITIES WITHIN THE AREA OF CONSTRUCTION.
- 2.4. IF UPON EXCAVATION, AN EXISTING UTILITY IS FOUND TO BE IN CONFLICT WITH THE PROPOSED CONSTRUCTION OR TO BE OF A SIZE OR MATERIAL DIFFERENT FROM THAT SHOWN ON THE PLANS; THE CONTRACTOR SHALL IMMEDIATELY NOTIFY THE LANDSCAPE ARCHITECT.
- 2.5. IT SHALL BE THE CONTRACTOR'S RESPONSIBILITY TO MAKE ARRANGEMENTS FOR THE FIELD LOCATIONS AND FOR ANY TREES PROPOSED FOR RELOCATION. THIS SHALL BE DONE IN A TIMELY MANNER TO MINIMIZE IMPACT ON CONSTRUCTION SCHEDULE. ANY DELAY CAUSED BY THE CONTRACTOR BY THE RELOCATION OF TREES SHALL BE INCIDENTAL TO THE CONTRACT AND NO EXTRA COMPENSATION WILL BE ALLOWED.
- 2.6. CONTRACTOR SHALL VERIFY LIMITS OF CONSTRUCTION AS NOTED ON THE PLANS. ANY WORK PERFORMED OUTSIDE OF THE AGREED UPON LIMITS OF CONSTRUCTION SHALL BE DONE AT THE EXPENSE OF THE CONTRACTOR.

SITE DEMOLITION

- 3.1. ITEMS SHALL REMAIN UNLESS OTHERWISE NOTED ON THE PLAN(S). REMOVE DESIGNATED ITEMS SHOWN ON THE PLAN TO THE FULL DEPTH OF THEIR CONSTRUCTION UNLESS OTHERWISE NOTED.
- 3.2. ALL HARDSCAPE DESIGNATED FOR REMOVAL SHALL BE SAW CUT, LEAVING UNIFORM EDGES TO THE GREATEST EXTENT POSSIBLE. MATERIAL EDGES TO REMAIN SHALL BE SHORED UP AND PROTECTED DURING CONSTRUCTION TO PRESERVE EDGE INTACT. REPAIRS TO DAMAGED EDGES SHALL BE REPAIRED BY CONTRACTOR AT NO ADDITIONAL COST TO THE OWNER.
- 3.3. NO EXISTING MATERIAL SHALL BE USED IN NEW CONSTRUCTION UNLESS NOTED ON THE PLANS OR APPROVED DURING THE SHOP DRAWING APPROVAL PROCESS.
- 3.4. SALVAGE EXISTING MATERIALS AS INDICATED ON THE PLANS. SALVAGED MATERIALS SHALL BE HANDLED WITH CARE AND STORED ON-SITE OR AS DIRECTED BY OWNER. CLEAN ALL DEBRIS AND CONSTRUCTION MATERIAL FROM SALVAGED ITEMS; REUSE AS DIRECTED BY OWNER'S REPRESENTATIVE.
- 3.5. REMOVE DEMOLISHED MATERIALS FROM SITE AND DISPOSE OF AS REQUIRED BY LOCAL, STATE OR FEDERAL LAWS.
- 3.6. CONTRACTOR SHALL PROTECT ADJACENT WATER BODIES, COASTAL DUNE SYSTEMS AND PROPERTIES FROM DAMAGE BY SEDIMENTATION OR OTHER POTENTIAL CONSTRUCTION RELATED
- 3,7. ALL IRRIGATION IN DEMOLITION AREA TO BE CAPPED AND ADJUSTED AS NECESSARY TO ENSURE OVERALL SYSTEM IS NOT AFFECTED.

TREE PRESERVATION

- 4.1. ALL TREES TO BE PRESERVED AS INDICATED ON THE TREE DISPOSITION PLAN SHALL BE PROTECTED BY A TREE PROTECTION BARRICADE, UNLESS OTHERWISE NOTED ON PLAN.
- 4.2. TREE PROTECTION BARRICADES SHALL BE PROVIDED BY LANDSCAPE CONTRACTOR AROUND THE

- DRIP LINE OF EXISTING TREES TO BE PRESERVED IN PLACE, AS SHOWN ON PLAN. PRESERVATION BARRICADES SHALL BE LEFT IN PLACE THROUGHOUT DURING ALL PHASES OF CONSTRUCTION. PRIOR TO ANY CONSTRUCTION A TREE PROTECTION BARRICADE INSPECTION SHALL BE CONDUCTED BY THE LANDSCAPE ARCHITECT, OWNER OR GOVERNING MUNICIPALITY. REFER TO PLANS FOR TREE
- PRESERVATION BARRICADE FENCING DETAIL. 4.4. IF EXCAVATION IN THE VICINITY OF A PROTECTED TREE IS REQUIRED, CONTRACTOR SHALL ROOT PRUNE TREES, UNDER THE SUPERVISION OF A CERTIFIED ARBORIST IN ACCORDANCE TO THE
- FOLLOWING CONDITIONS: ROOT PRUNE TREES A MINIMUM OF EIGHT (8) WEEKS PRIOR TO CONSTRUCTION. PRIOR TO ROOT PRUNING, THOROUGHLY WATER THE ROOT ZONE WITH AT LEAST 2 TO 3 INCHES OF WATER FOR 2 TO 3 DAYS PRIOR TO ROOT PRUNING, SEE BELOW FOR RELOCATION TIMELINE. 1. PROVIDE TEMPORARY IRRIGATION FOR EACH TREE THROUGHOUT THE DURATION OF
 - 2. ROOT PRUNE TREES, SHOWN ON PLAN IN AREAS WHERE ROOTS WILL CONFLICT WITH CONSTRUCTION ACTIVITY. PRUNING OF ROOTS SHOULD BE DONE IN A MANNER TO PRESERVE THE GREATEST AMOUNT OF THE ROOT BASE AS POSSIBLE. BACKFILL TRENCH WITH PLANTING SOIL.
- FERTILIZE WITHIN THE ROOT ZONE (SEE BELOW). ROOT PRUNING SHALL BE ACCOMPLISHED BY DIGGING A TRENCH AROUND THE TREE IN AREAS WHERE PROPOSED SITE WORK WILL BE PERFORMED. TRENCHING SHALL BE AT A MINIMUM OF 24" DEEP. ROOT PRUNE ONLY WITH A MECHANICAL ROOT-PRUNING SAW OR A TRENCHER WITH A MAXIMUM TRENCH WIDTH OF 8".
- ALL EXPOSED ROOTS SHALL BE CUT OFF SMOOTHLY, WITH SHARP INSTRUMENTS. BACKFILL TRENCHES WITH SOIL CONSISTING OF 30% SILICA SAND AND 70% MUCK. WATER THOROUGHLY AFTER ROOT PRUNING, AND ONCE WEEKLY DURING THE ROOT REGENERATION PERIOD, WITH A SOLUBLE FERTILIZER THAT HAS A 20.20.20 ANALYSIS AT MANUFACTURER'S RECOMMENDED RATE.
- THE CONTRACTOR SHALL FIELD STAKE THE LIMIT OF ROOT PRUNING. LIMITS OF ROOT PRUNING SHALL BE APPROVED BY THE LANDSCAPE ARCHITECT PRIOR TO ANY EXCAVATION. DO NOT ROOT PRUNE FOR IRRIGATION OR ELECTRICAL LINES WITHIN DRIP LINES OF EXISTING TREES. COORDINATE ALL TRENCHING REQUIRED FOR UTILITY WORK WITH THE LANDSCAPE PLANS.

PLANTING SOIL

5.1. ALL TREES SHALL BE PLANTED WITH A MINIMUM OF 12" TOPSOIL AROUND AND BENEATH THE

ROOT PRUNING SHALL OCCUR IN ACCORDANCE WITH TREE RELOCATION NOTES AS NOTED ON

- 5.2. ALL TREES SHALL BE PLANTED WITH A MINIMUM OF 6" TOPSOIL AROUND AND BENEATH THE ROOTBALL
- 5.3. MINIMUM TOPSOIL SHALL BE 2" FOR SODDED GRASS AREAS.
- 5.4. PLANTING SOIL MIX SHALL BE A WEED FREE MIX AS FOLLOWS:
- DICOT TREES & SHRUBS: 50% SAND, 40% MUCK & 10% PEAT 5.4.2. MONOCOT PALMS: 70% SAND & 30% MUCK
- 5.4.3. TURF: 80% SAND, 10% PEAT & 10% MUCK

6. LANDSCAPE PLANTING

CONSTRUCTION.

- THIS PLAN HAS BEEN DESIGNED TO MEET OR EXCEED ALL APPLICABLE CODES.
- THE PLANTING PLAN SHALL BE INSTALLED IN COMPLIANCE WITH ALL EXISTING CODES AND APPLICABLE DEED RESTRICTIONS.
- 6.3. PLANT MATERIAL: ALL PLANT MATERIAL SHALL BE FLORIDA #1 OR BETTER AS ESTABLISHED BY "GRADES
- AND STANDARDS FOR NURSERY PLANTS" OF THE STATE OF FLORIDA, DEPARTMENT OF AGRICULTURE. ALL PLANT MATERIAL SHALL BE TRUE TO THE BOTANICAL NAME, GENUS, SPECIES AND/OR HYBRID DESIGNATION
- ALL TREES, SHRUBS AND GROUNDCOVERS SHALL BE OF THE SIZES (HEIGHT & SPREAD) AS SPECIFIED IN THE PLANT LIST. CONTAINER SIZE IS FOR REFERENCE PURPOSES ONLY. ALL PLANT MATERIAL SHALL MEET OR EXCEED THE MINIMUM SIZES AT INSTALLATION, AS SPECIFIED IN THE PLANT LIST.
- QUANTITIES LISTED ON THE PLANT LIST ARE FOR ESTIMATING PURPOSES. CONTRACTOR SHALL VERIFY ALL QUANTITIES. MULCH, TOPSOIL, FERTILIZER, ETC. SHALL BE INCLUDED IN THE UNIT COST OF THE
- WHERE THERE IS A DISCREPANCY EITHER IN QUANTITIES, PLANT NAMES, SIZES OR SPECIFICATIONS BETWEEN THE PLAN OR PLANT LIST, THE PLAN TAKES PRECEDENCE.
- ALL SUBSTITUTIONS AND CHANGES SHALL BE APPROVED IN WRITING PRIOR TO INSTALLATION. ANY DISCREPANCIES BETWEEN PLANS, SITE AND SPECIFICATIONS SHALL BE BROUGHT TO THE IMMEDIATE ATTENTION OF THE LANDSCAPE ARCHITECT, THE OWNER AND/OR GOVERNING MUNICIPALITY.
- 6.9. CONTRACTOR SHALL BE RESPONSIBLE FOR PROVIDING FINAL GRADING OF ALL ASSOCIATED PLANTING AREAS.
- 6.10. AFTER FINAL GRADE, LANDSCAPE AREAS ARE TO BE RAKED TO A DEPTH OF 6". ALL ROCK AND FOREIGN INORGANIC MATERIALS SHALL BE REMOVED AND DISPOSED OF PROPERLY OFF-SITE.
- 6.11. ALL PLANTING HOLES TO BE HAND DUG EXCEPT WHERE MACHINE DUG HOLES WILL NOT ADVERSELY AFFECT EXISTING TREES DAMAGE LITHTIES OR OTHER IMPROVEMENTS
- 6.12. ALL PLANTING BEDS IN OPEN AREAS AND AROUND BUILDING FOUNDATIONS SHALL BE EXCAVATED TO A DEPTH OF TWENTY-FOUR INCHES (24") AND BACK FILLED WITH SOIL MIX AS SPECIFIED IN SECTION 5.00. PLANTING BED SHALL BE FREE FROM ROCK, CONSTRUCTION DEBRIS OR OTHER EXTRANEOUS MATERIAL
- 6.13. ALL PLANTING BEDS IN MEDIANS, HARDSCAPE AREAS OR AREAS ENCOMPASSED BY IMPERVIOUS MATERIAL SHALL BE EXCAVATED TO A DEPTH OF THIRTY-SIX INCHES (36") OR UNTIL NATIVE SOILS ENCOUNTERED TO ENSURE DRAINAGE. BACK FILL WITH SOIL MIX AS SPECIFIED IN SECTION 5.00. PLANTING BED SHALL BE FREE FROM ROCK, CONSTRUCTION DEBRIS OR OTHER EXTRANEOUS MATERIAL
- 6.14. EXCAVATE PLANTING PITS TO A DEPTH SO THAT THE TRUNK FLARE AND FIRST ORDER LATERAL ROOT(S) WILL BE PLANTED AT FINISH GRADE OR SLIGHTLY HIGHER. ADVENTITIOUS ROOTS ARE NOT CONSIDERED FIRST ORDER ROOTS.
- 6.15. BURLAP, SYNTHETIC STRING, CORDS AND/OR LIFTING ROPES SHALL BE REMOVED FROM THE ROOTBALLS BEFORE ANY TREES ARE PLANTED. THE TOP 1/3RD OF BURLAP MUST BE REMOVED FROM HE TOP OF THE ROOTBALLS. THE TOP 1/3RD OF WIRE BASKETS SHALL BE COMPLETELY REMOVED AND THE BOTTOM 2/3RDS SHALL BE CUT BEFORE THE TREES ARE INSTALLED.
- 6.16. NO PLUNGING OF ANY TREE OR PALM WILL BE ACCEPTED.
- NO PLANT MATERIAL WILL BE ACCEPTED SHOWING EVIDENCE OF CABLE, CHAIN MARKS, EQUIPMENT SCARS, OR OTHERWISE DAMAGED. 6.18. PLANT MATERIAL WILL NOT BE ACCEPTED WHEN THE BALL OF EARTH SURROUNDING ITS ROOTS HAS
- BEEN CRACKED, BROKEN OR OTHERWISE DAMAGED. 6.19. ALL TREES SPECIFIED AS FIELD GROWN OR B&B TREES SHALL BE ROOT-PRUNED AT THE NURSERY A MINIMUM OF (8) WEEKS PRIOR TO PLANTING.
- 6.20. ALL PLANT MATERIAL PLANTED WITHIN THE SIGHT DISTANCE TRIANGLE AREAS SHALL BE MAINTAINED TO PROVIDE UNOBSTRUCTED CROSS-VISIBILITY AT A HORIZONTAL LEVEL BETWEEN 30 INCHES AND 8
- FEET ABOVE ADJACENT STREET GRADE. 6.21. NO CANOPY TREES SHALL BE PLANTED WITHIN 12 FEET OF A LIGHT POLE. NO PALM SPECIES SHALL BE PLANTED WITHIN 6 FEET OF A LIGHT POLE.
- 6.22. GROUND COVER PLANTINGS SHALL PROVIDE NOT LESS THAN 50 PERCENT COVERAGE IMMEDIATELY UPON PLANTING AND 100 PERCENT COVERAGE WITHIN 6 MONTHS AFTER PLANTING.
- 6.23. TREES AND PALMS SHALL BE MAINTAINED TO ALLOW FOR CLEAR PASSAGE 8' IN ALL PEDESTRIAN 6.24. ALL LANDSCAPE MATERIAL SHALL BE SETBACK A MINIMUM OF 10' FROM ANY FIRE HYDRANT. 6.25. CONTRACTOR SHALL REMOVE ALL NURSERY STAKES, CONDUIT, FLAGGING AND NURSERY TAPE
- PRIOR TO STAKING. CONTRACTOR SHALL STAKE & GUY ALL TREES AND PALMS AT TIME OF PLANTING AS PER THE APPROPRIATE DETAIL. CONTRACTOR IS RESPONSIBLE FOR THE MAINTENANCE AND/OR REPAIR OF ALL STAKING AND GUYING DURING WARRANTY PERIOD AND REMOVAL & DISPOSAL OF STAKING
- 6.27. TREES THAT CANNOT STAND WITHOUT THE SUPPORT OF STAKES AND/OR GUYS SHALL BE REJECTED.
- ALL AREAS NOT USED FOR BUILDINGS, VEHICULAR USE AREAS, WALKS OR PLANTING BEDS SHALL BE GRASSED. GRASSING SHALL EXTEND TO ANY ABUTTING STREET PAVEMENT EDGE AND TO THE MEAN WATERLINE OF ANY ABUTTING CANAL, LAKE OR WATERWAY. REFER TO PLANTING SCHEDULE FOR ESTIMATED QUANTITY AND SPECIES. MULCH & FERTILIZER
- ALL PLANTING BEDS AND WATER BASINS FOR TREES SHALL BE COVERED WITH A 3" MINIMUM DEPTH OF SHREDDED FLORI-MULCH, MELALEUCA OR EUCALYPTUS MULCH GRADE 'B' OR BETTER, UNLESS OTHERWISE SPECIFIED.
- 8.2. INDIVIDUAL TREES PLANTED IN LAWN AREAS SHALL BE MULCHED WITH A MINIMUM 3' DIAMETER MULCH RING.
- MULCH SHALL NOT BE INSTALLED WITHIN 3" OF TREE TUNKS. 8.4. FERTILIZER MIX AS FOLLOWS:

AFTER ESTABLISHMENT/WARRANTY PERIOD.

- 8.4.1. DICOT TREES & SHRUBS: NPK 18-4-2, SLOW RELEASE W/ MICRONUTRIENTS MONOCOT PALMS: NPK 8-2-12, SLOW RELEASE W/ MICRONUTRIENTS
- TURF: NPK 16-4-8, SLOW RELEASE W/ MICRONUTRIENTS
- 8.4.3. 9. WATERING
- 9.1. ALL LANDSCAPED AREAS WILL BE IRRIGATED BY AN UNDERGROUND, AUTOMATIC, RUST-FREE IRRIGATION SYSTEM PROVIDING 100% COVERAGE AND 50% SPRAY OVERLAP. THE SYSTEM SHALL BE MAINTAINED IN GOOD WORKING ORDER AND DESIGNED TO MINIMIZE WATER ON IMPERVIOUS SERVICES AND NOT OVERSPRAY WALKWAYS. A RAIN SENSOR DEVICE SHALL BE INSTALLED TO

- OVERRIDE THE IRRIGATION CYCLE OF THE SYSTEM WHEN ADEQUATE RAINFALL HAS OCCURRED. 9.2. ALL PLANT MATERIAL SHALL BE WATERED IN AT TIME OF PLANTING IN ACCORDANCE WITH STANDARD NURSERY PRACTICES. IN ADDITION, CONTRACTOR WILL CONTINUE THE WATERING OF PLANT MATERIAL UNTIL SUBSTANTIAL COMPLETION AND THE LANDSCAPE IS TURNED OVER TO THE OWNER.
- 10. PROJECT CLOSEOU
- 10.1. DURING CONSTRUCTION, THE PROJECT SITE AND ALL ADJACENT AREAS SHALL BE MAINTAINED IN A NEAT AND CLEAN MANNER. UPON FINAL CLEAN UP, THE PROJECT SITE SHALL BE LEFT CLEAR OF ALL SURPLUS MATERIAL OR TRASH. THE PAVED AREAS SHALL BE SWEPT BROOM CLEAN.
- 10.2. THE CONTRACTOR SHALL RESTORE, REPLACE OR AS DIRECTED BY THE LANDSCAPE ARCHITECT, ANY PUBLIC OR PRIVATE PROPERTY DAMAGED BY THE WORK OF THE CONTRACTOR, HIS EQUIPMENT, EMPLOYEES OR THOSE OF HIS SUB-CONTRACTORS. THIS WORK SHALL BE RESTORED TO A CONDITION EQUAL TO OR BETTER THAN THAT OF THE EXISTING ADJACENT AREAS. THE RESTORATION WORK SHALL BE AT THE CONTRACTOR'S EXPENSE. SUITABLE MATERIALS AND METHODS SHALL BE USED FOR SUCH RESTORATION.
- 10.3. WHERE MATERIAL OR DEBRIS HAS WASHED OR FLOWED INTO OR BEEN PLACED IN WATER COURSES, DITCHES, DRAINS, CATCH BASINS, OR ELSEWHERE AS A RESULT OF THE CONTRACTOR'S OPERATIONS, SUCH MATERIAL OR DEBRIS SHALL BE REMOVED AND SATISFACTORILY DISPOSED OF DURING PROGRESS OF THE WORK. THESE AREAS SHALL BE KEPT IN A CLEAN AND NEAT CONDITION.
- 10.4. THE CONTRACTOR SHALL MAINTAIN ACCURATE AND COMPLETE RECORDS OF WORK ITEMS COMPLETED.
- 10.5. UPON COMPLETION OF CONSTRUCTION, THE CONTRACTOR SHALL SUBMIT TO THE LANDSCAPE ARCHITECT OF RECORD COMPLETE SETS OF "AS-BUILT" CONSTRUCTION DRAWINGS. THESE DRAWINGS SHALL BE MARKED TO SHOW "AS-BUILT" CONSTRUCTION CHANGES AND DIMENSIONED LOCATIONS AND ELEVATIONS OF ALL IMPROVEMENTS INCLUDING PRODUCT/EQUIPMENT AS SPECIFIED OR REVISED DURING THE SHOP DRAWING SUBMITTAL PROCESS. AS-BUILT DRAWINGS SHALL BE SIGNED AND SEALED BY A FLORIDA REGISTERED LAND SURVEYOR. 11. GUARANTEE
- 11.1. ALL NEW PLANT MATERIAL SHALL BE GUARANTEED FOR 1 YEAR FROM TIME OF FINAL ACCEPTANCE OF PROJECT. ANY PLANT MATERIAL NOT IN A HEALTHY GROWING CONDITION WILL BE REPLACED IN KIND BY THE CONTRACTOR AT NO ADDITIONAL COST TO THE OWNER WITHIN 10 DAYS OF NOTIFICATION.
- 11.2. FOR ALL REPLACEMENT PLANT MATERIAL, THE WARRANTY PERIOD SHALL BE EXTENDED AN ADDITIONAL 90 DAYS BEYOND THE ORIGINAL WARRANTY PERIOD, REPLACEMENT MATERIAL SHALL BE REPLACED IN KIND AS IT RELATES TO SPECIES, QUANTITY AND SIZE.
- 11.3. ALL TREES THAT LEAN OR ARE BLOWN OVER, CAUSED BY WINDS LESS THAN 74 MPH AS DETERMINED BY THE NATIONAL HURRICANE CENTER. WILL BE RE-SET AND BRACED BY THE CONTRACTOR AT NO ADDITIONAL COST TO THE OWNER.



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REGISTRATION

CRISTOBAL A. BETANCOURT, RLA REGISTRATION NO. 6666941 DATE: <u>5/6/2021</u>



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CLIENT

OAKLAND PARK DIXIE, LLC

PROJECT INFORMATION

SKY BUILDING

PROJECT NUMBER

CLIENT PROJECT NUMBER

20-487.001

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REVISIONS

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⚠ DRC COMMENTS

DATE OF ISSUE 03.18.2021


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DRAWING TITLE

GROUND LEVEL LANDSCAPE **SPECIFICATIONS**



PLANTING AREA.

PEDESTRIAN PATHWAY. REFER TO PLAN.

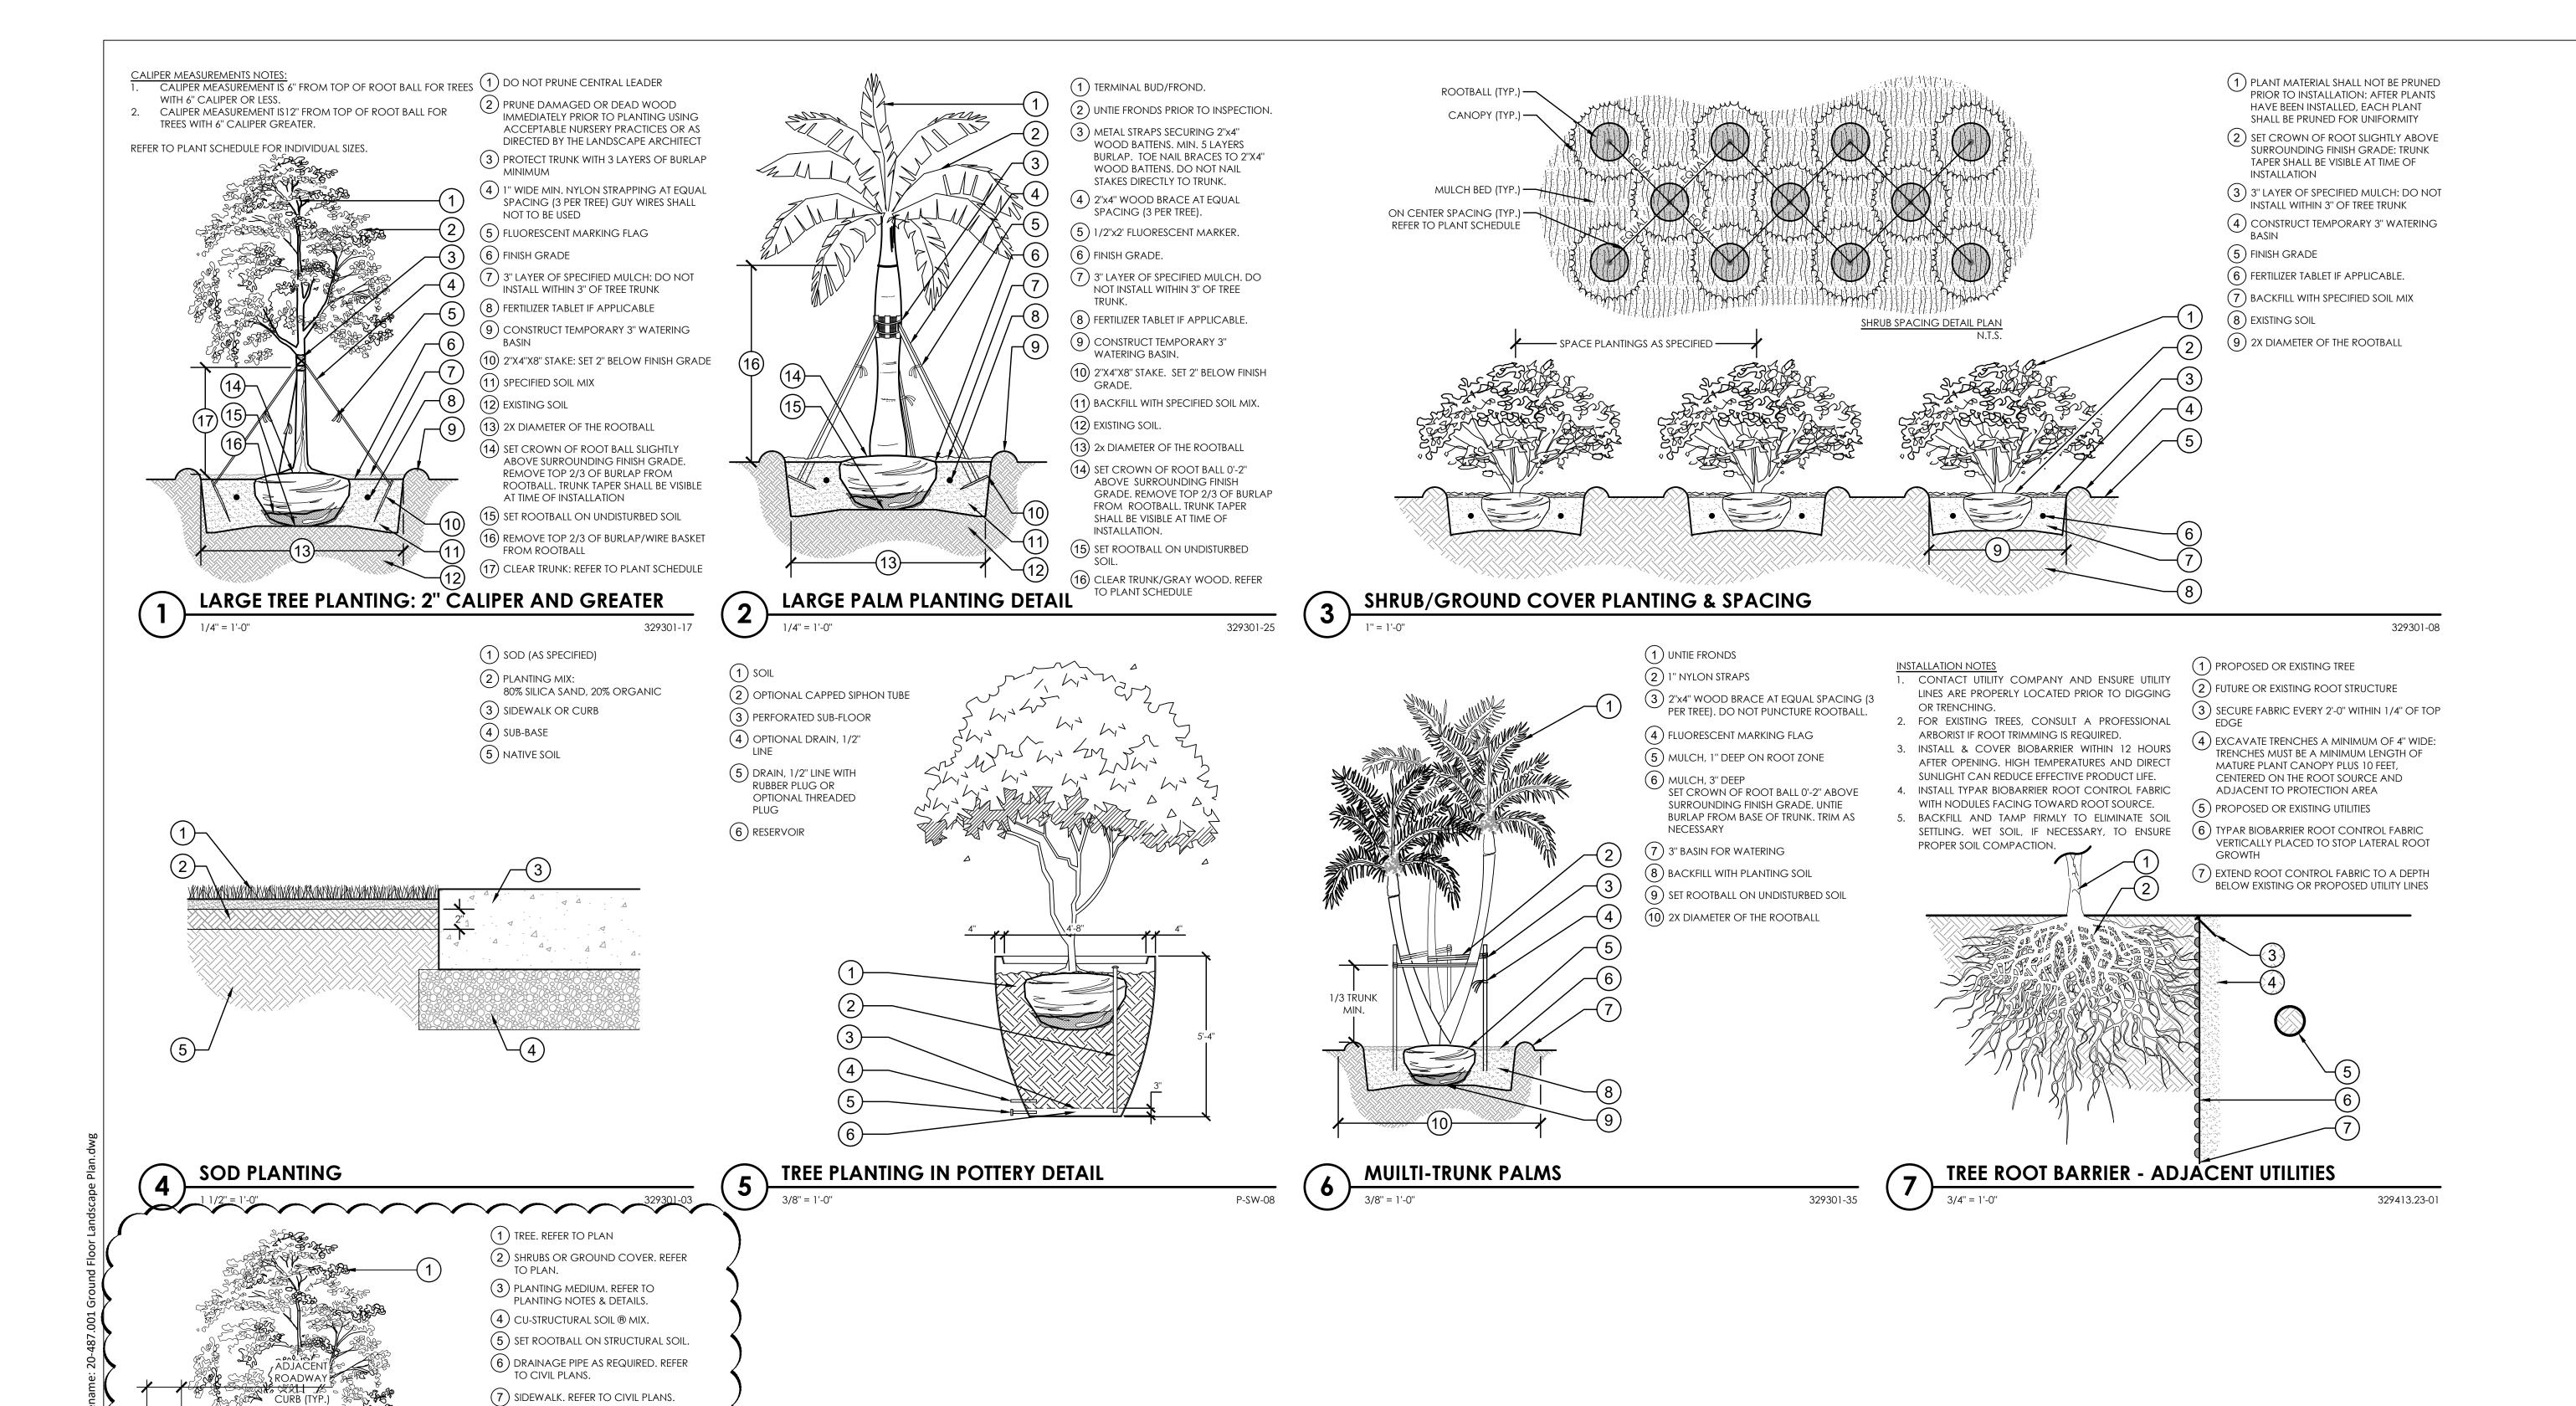STRUCTURAL SOIL BELOW SIDEWALK DETAIL



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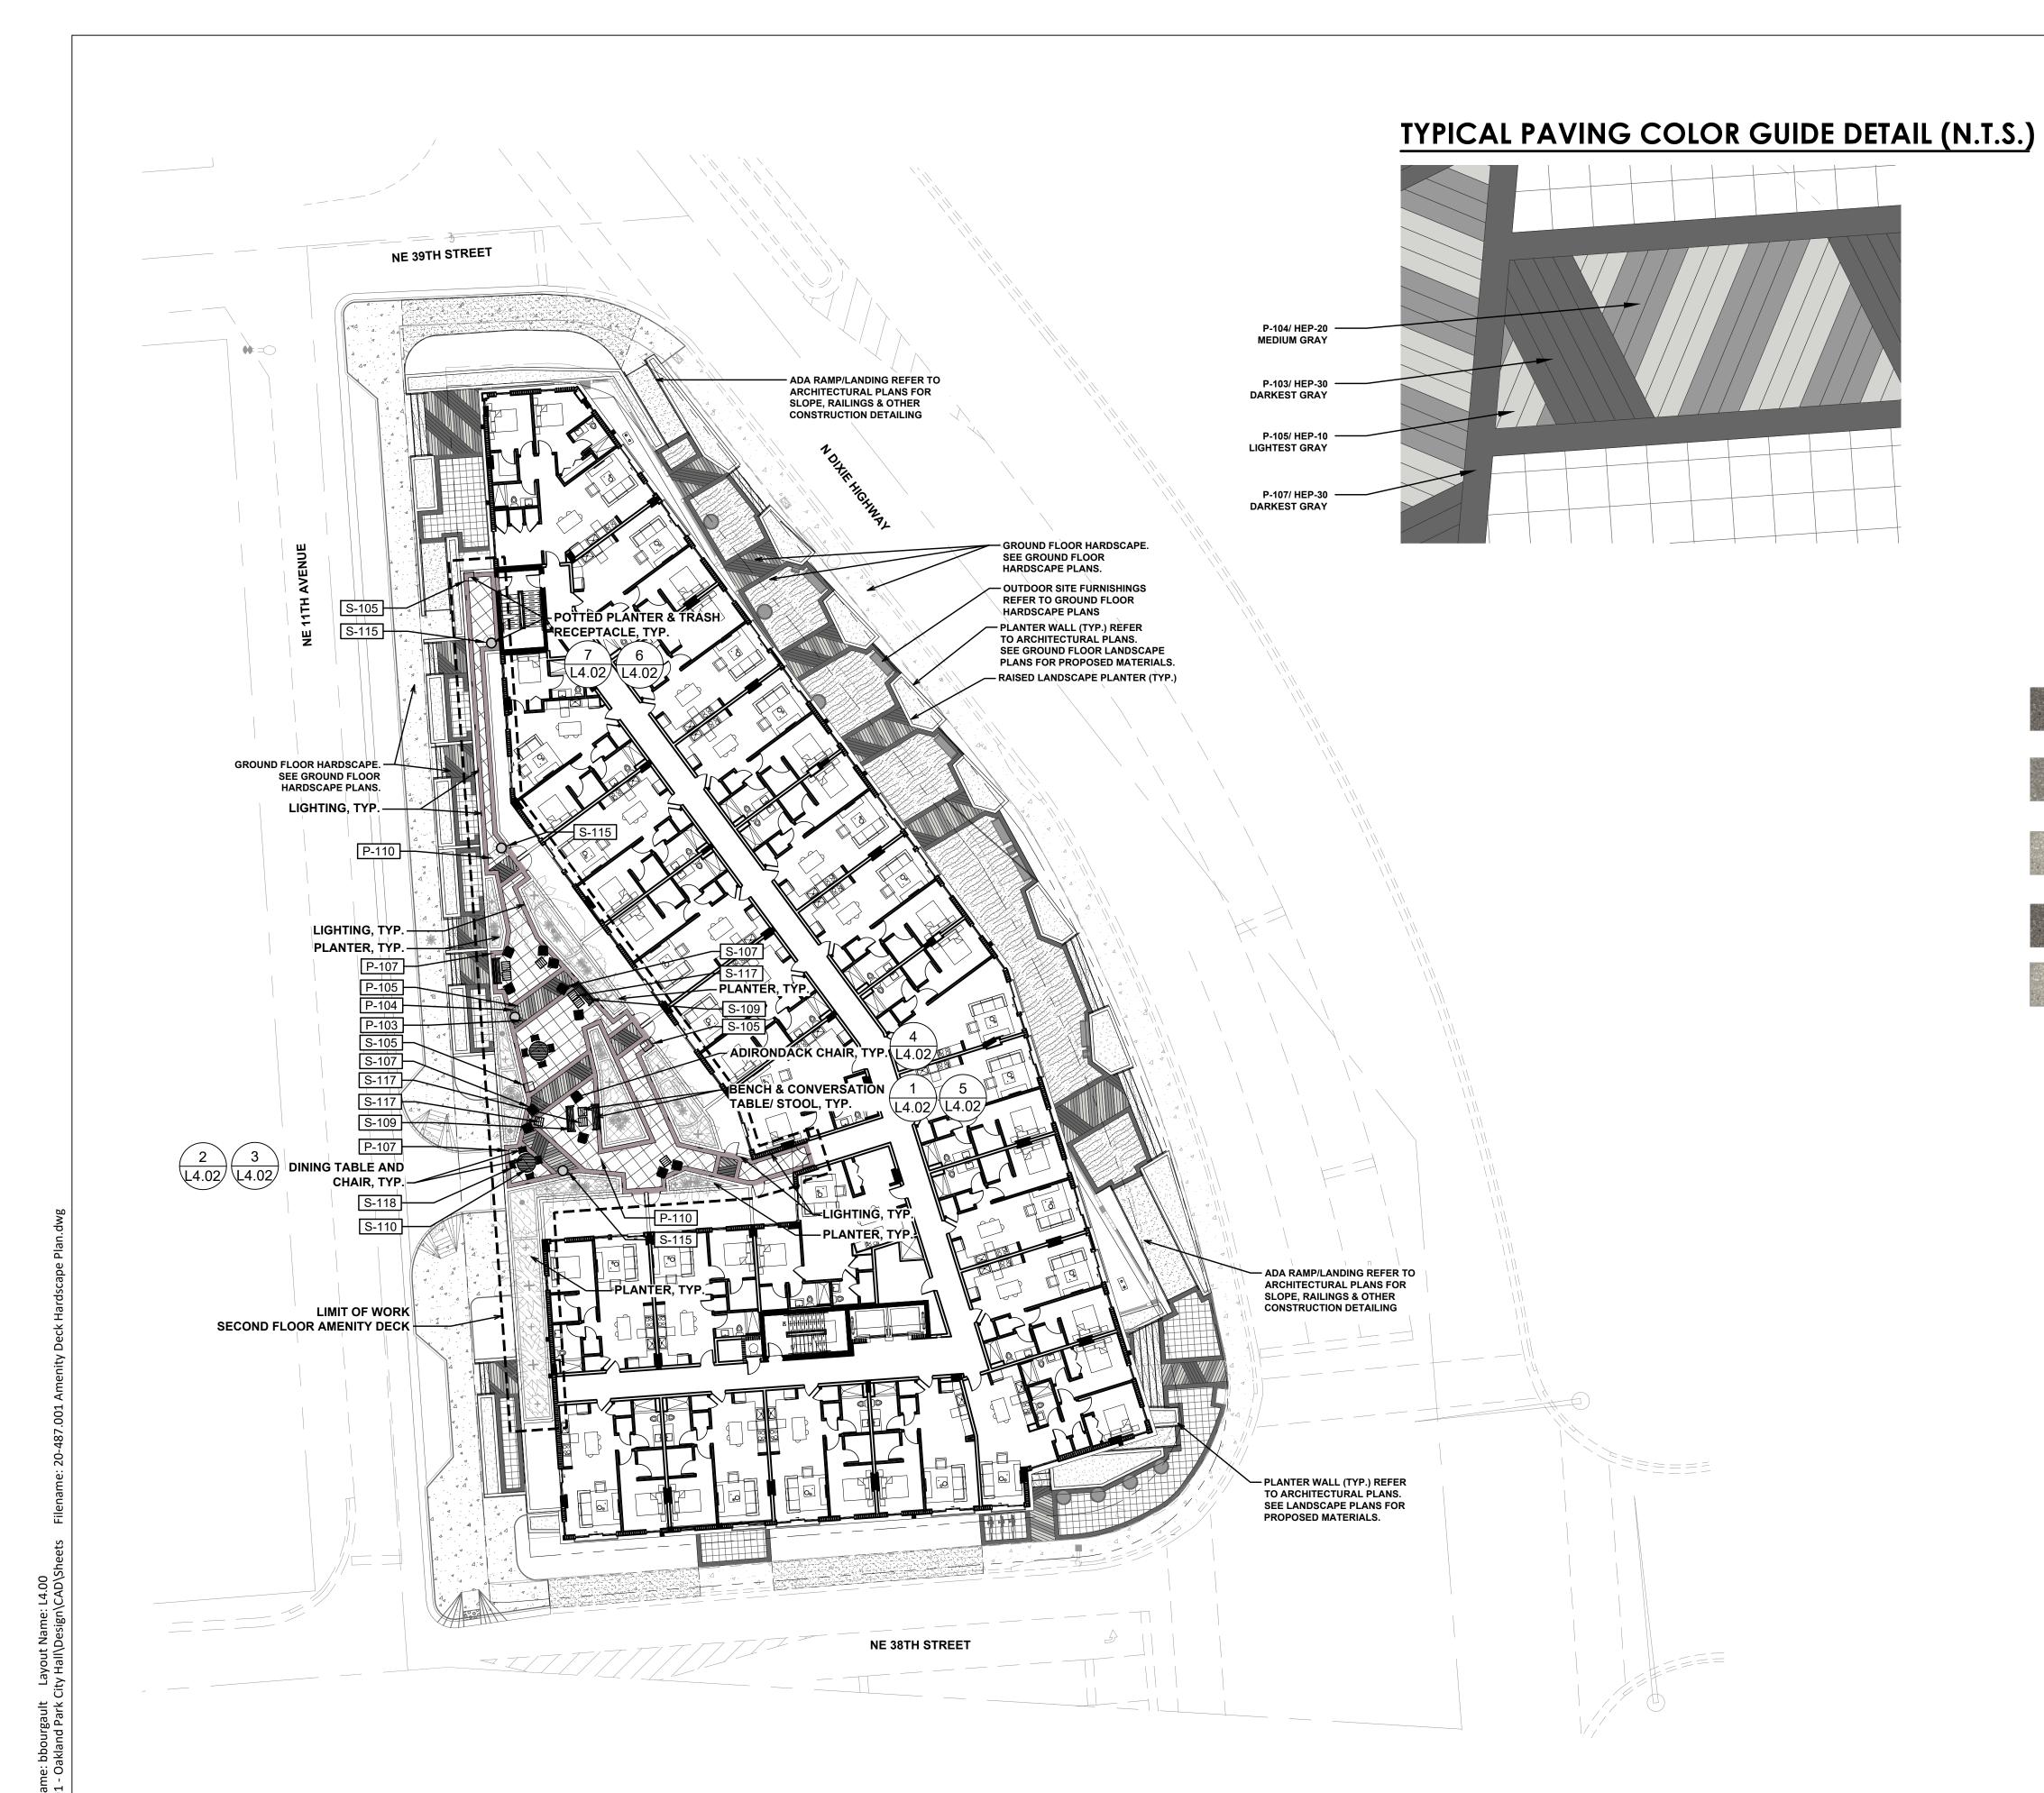
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EH

GROUND LEVEL LANDSCAPE NOTES AND DETAILS





ELEVATION OUTDOOR LOUNGE CHAIR

PLANK OUTDOOR ADIRONDACK CHAIR

ELEVATION OUTDOOR BENCH

CANYON OUTDOOR STOOL/ CONVERSATION TABLE

ELEVATION OUTDOOR DINING TABLE

OUTDOOR FIBERGLASS POT


TRASH RECEPTACLE

AMENITY DECK HARDSCAPE SCHEDULE

| | PAVING | |
|---------------|--|------------|
| SYMBOL | DESCRIPTION | <u>QTY</u> |
| P-103 | 4"X4"X2" ECO PREMIER PEDESTRIAN PAVERS COLOR: HEP-30 MANUFACTURER: WAUSAU TILE PATTERN: STACKED BOND | 127 sf |
| P-104 | 4"X4"X2" ECO PREMIER PEDESTRIAN PAVERS COLOR: HEP-20 MANUFACTURER: WAUSAU TILE PATTERN: STACKED BOND | 88 sf |
| P-105 | 4"X4"X2" ECO PREMIER PEDESTRIAN PAVERS COLOR: HEP-10 MANUFACTURER: WAUSAU TILE PATTERN: STACKED BOND | 71 sf |
| P-107 | 12"X12"X2" ECO PREMIER PEDESTRIAN PAVER COLOR: HEP-30 MANUFACTURER:WAUSAU TILE | 1,012 s |
| P-110 | 24"X24"X2" ECO PREMIER PEDESTRIAN PAVERS COLOR: HEP-10 MANUFACTURER: WAUSAU TILE PATTERN: STACKED | 1,170 s |
| <u>symbol</u> | SITE FURNISHINGS DESCRIPTION | <u>QTY</u> |
| S-105 | ANOVA 45 GALLON TRASH RECEPTACLE ELV45R FRAME: POWDER COATED METAL. COLOR: TBD SIDES: RECYCLED PLASTIC. COLOR: TBD | 3 |
| S-107 | ANOVA PLANK ADIRONDACK CHAIR PLK60R FRAME: POWDER COATED METAL. COLOR: TBD. SEATING AND BACKING SLATS: RECYCLED PLASTIC. COLOR: TBD | 12 |
| S-109 | ANOVA ELEVATION 6' RECYCLED PLASTIC BENCH ELV80R FRAME: POWDER COATED METAL. COLOR: TBD SEATING SLATSS: RECYCLED PLASTIC. COLOR: TBD | 4 |
| S-110 | ANOVA ELEVATION 52" ROUND TABLE ELV52R FRAME: POWDER COATED METAL. COLOR: TBD TABLE TOP:RECYCLED PLASTIC. COLOR: TBD | 2 |
| S-115 | 64" FIBERGLASS POT MANUFACTURER: OLD TOWN FIBERGLASS MODEL: BALBOA FINISH: GLOSS COLOR: TBD | 4 |
| S-117 | ANOVA 2` SQUARE STOOL/ CONVERSATION TABLE CAN18824R 2` SQUARE GABION STYLE STOOL/ CONVERSATION TABLE 5.5 CU FT INTERNAL VOLUME FRAME: TEXTURED ALUMINUM CAGE AND STAINLESS STEEL MESH PANELS. COLOR: TBD. TOP:RECYCLED PLASTIC LUMBER. COLOR: TBD. | 9 |
| S 118 | ANIOWA FLEWATION LOUNICE CHAIR FLV99R | 0 |

ANOVA ELEVATION LOUNGE CHAIR ELV82R

FRAME: POWDER COATED METAL. COLOR: TBD SEATING AND BACK SLATS:RECYCLED PLASTIC. COLOR: TBD.

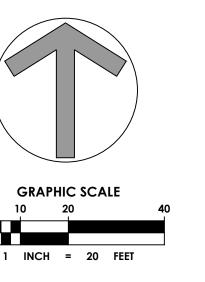

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DRAWING TITLE

AMENITY DECK HARDSCAPE PLAN

L4.00





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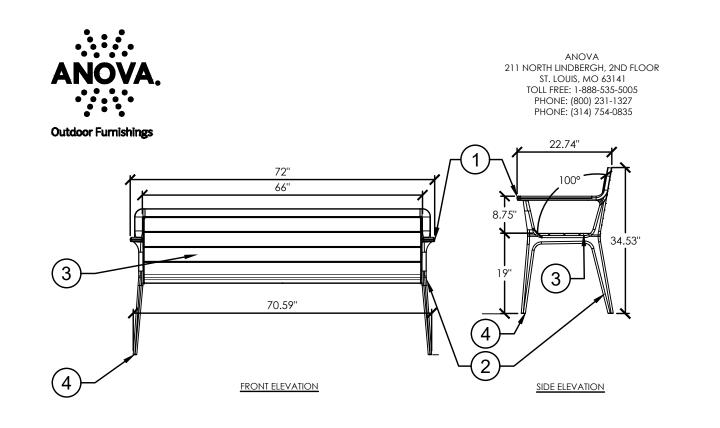
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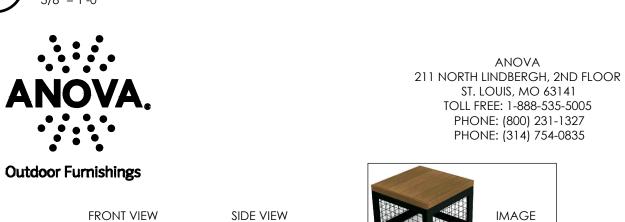
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AMENITY DECK HARDSCAPE PLAN




- 1) ELEVATION 6' RECYCLED PLASTIC BENCH
- (2) POWDER COATED METAL FRAME, REFER TO PLAN FOR COLOR.
- (3) RECYCLED PLASTIC SLATS, REFER TO PLAN FOR COLOR.
- (4) MOVEABLE FURNITURE, NO SURFACE MOUNT

ANOVA ELEVATION 6' BENCH





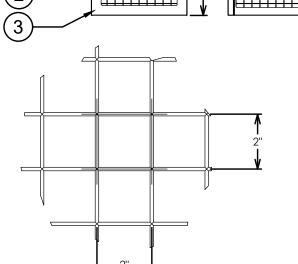

(1) PLANTER WALL WITH SMOOTH STUCCO FINISH.

GRADING PLANS, BY OTHERS.

(10) FINISH GRADE.

FOR LOCATION.

(2) SIDEWALK, PAVERS OR SURFACING. REFER TO PLANS. SLOPE PER

(4) SEPARATION MEMBRANE PER ARCHITECTURAL PLANS AND DETAILS.

(7) UNDERGROUND DRIP IRRIGATION. REFER TO IRRIGATION PLANS

(9) PLANTER DRAINAGE INLET. REFER TO MEP PLANS FOR NUMBER OF REQUIRED INCLETS, SIZING AND CONNECTION INTO DRAINAGE

(12) POST-TENSION CONCRETE SLAB. REFER TO STRUCTURAL PLANS.

PLANTER WALL WITH DRAINAGE DETAIL

(3) SLOPE TOP OF WALL 1% TOWARD PLANTER FOR DRAINAGE

(5) DRAINAGE MEDIUM BY ROOFLITE OR APPROVED EQUAL.

(6) PLANTING MEDIUM. REFER TO PLANTER SOIL DETAIL.

(8) DRAINAGE INLET COVER. REFER TO MEP PLANS.

(11) MULCH, REFER TO LANDSCAPE PLANS.

- (1) ANOVA CANYON STOOL/ CONVERSATION 2) STAINLESS STEEL MESH, REFER TO PLAN FOR COLOR
- 3 POWDERCOATED ALUMINUM FRAME, REFER TO PLAN FOR COLOR
- RECYCLED PLASTIC SEAT/ TABLE PLANKS, REFER TO PLAN FOR COLOR

MESH PATTERN CLOSE-UP (N.T.S.) ANOVA CANYON STOOL/ CONVERSATION TABLE 129343.53-45

ANOVA ELEVATION 45 GALLON TRASH RECEPTACLE 129323-32

FRONT ELEVATION

(2) POWDERCOATED STEEL SIDING, REFER TO PLAN FOR COLOR

(3) RECYCLED PLASTIC PLANKS, REFER TO PLAN FOR COLOR

(4) SURFACE MOUNT, PER MANUFACTURER'S SPECIFICATIONS

1 ELEVATION 45 GALLON TRASH RECEPTACLE

(5) DOOR SWING

211 NORTH LINDBERGH, 2ND FLOOR

TOLL FREE: 1-888-535-5005

PHONE: (800) 231-1327

PHONE: (314) 754-0835

Outdoor Furnishings

SIDE ELEVATION

(3) RECYCLED PLASTIC SLATS, REFER TO PLAN FOR COLOR

4 POWDER COATED STEEL FRAME, REFER TO PLAN FOR COLOR

ANOVA ELEVATION 52" ROUND TABLE


(2) MOVEABLE TABLE, NO SURFACE MOUNT

1 ELEVATION 52" ROUND TABLE


5 OPTIONAL UMBRELLA HOLE


ANOVA

Outdoor Furnishings

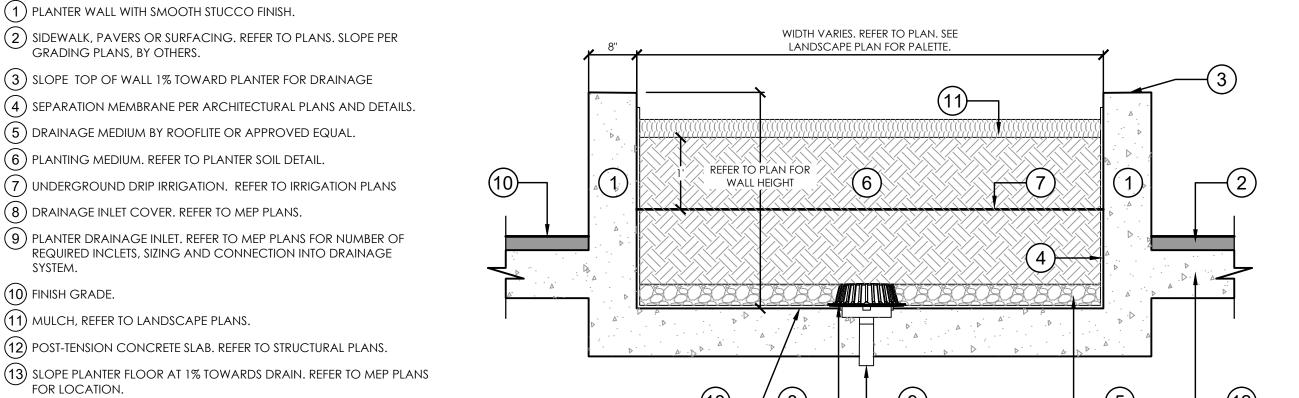

STRUCTURAL ENGINEER SHALL PROVIDE SIGNED & SEALED SHOP DRAWINGS FOR REINFORCEMENT REQUIRED FOR PLANTER WALLS. SHOP DRAWINGS SHALL BE SIGNED AND SEALED BY A REGISTERED ENGINEERING IN THE STATE OF FLORIDA DEPICTING THE WIND DESIGN CRITERIA PER FLORIDA BUILDING CODE, CURRENT EDITION.

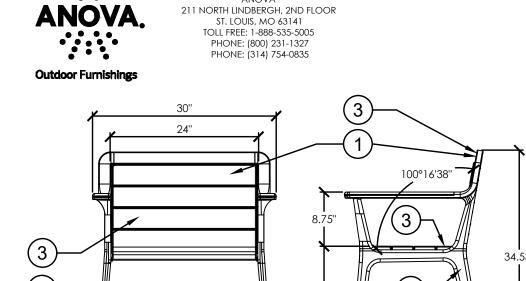

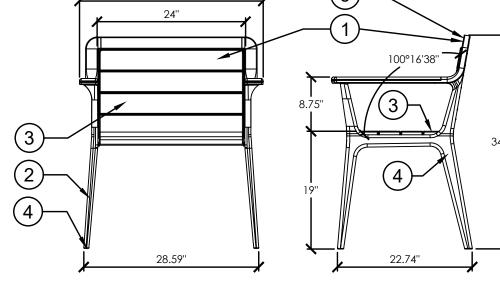

1 ELEVATION LOUNGE CHAIR

GLOSS

DRAINAGE HOLES

OPTIONS:

TOP VIEW

211 NORTH LINDBERGH, 2ND FLOOR

ST. LOUIS, MO 63141 TOLL FREE: 1-888-535-5005

PHONE: (800) 231-1327

PHONE: (314) 754-0835

44.46"

TOP VIEW

129324933#3-01#

- (2) POWDERCOATED METAL FRAME, REFER TO PLAN FOR COLOR
- (3) RECYCLED PLASTIC SLATS, REFER TO PLAN FOR COLOR

FRONT ELEVATION

(4) MOVEABLE CHAIR; NO SURFACE MOUNT

ANOVA ELEVATION LOUNGE CHAIR


Old Town

SIDE ELEVATION


OLD TOWN FIBERGLASS, INC. 767 NORTH HARITON STREET ORANGE, CA 92959 PHO. (714) 633-3732 FAX. (714) 633-3917 www.oldtownfiberglass.com

fiberglass


129343.13-56

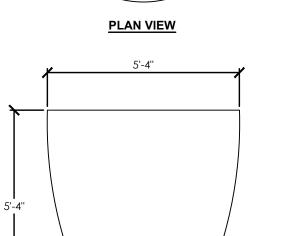

ELEVATION

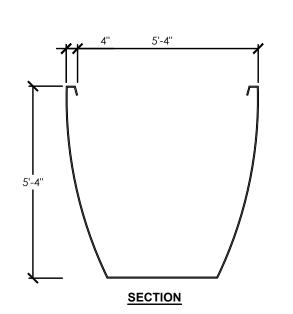

OLDTOWN FIBERGLASS 64" URN (BALBOA)

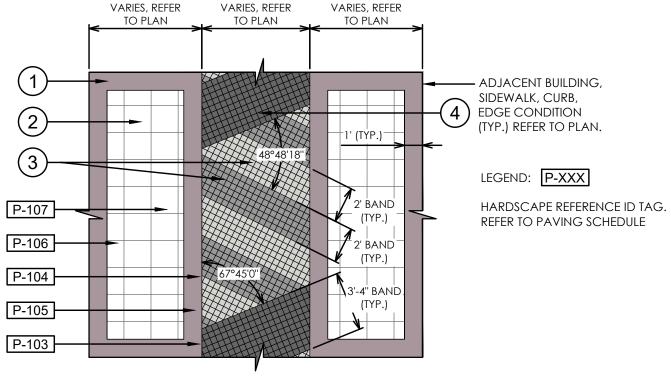

- (1) 12" X 12" PAVER BANDING. REFER TO SCHEDULE.
- 2) 18" X 18" PAVING FIELD. STACKED BOND PATTERN. ALIGN WITH PAVER BANDING. REFER TO SCHEDULE.
- 3) 4" X 4", 6 ROW PAVERING BANDING. STACKED BOND PATTERN. REFER TO SCHEDULE. (4) 4" X 4", 10 ROW PAVERING BANDING. STACKED
- BOND PATTERN. REFER TO SCHEDULE. (5) PAVER AS NOTED ON PLAN.
- (6) PAVING JOINT PER MANUFACTURER'S RECOMMENDATIONS.

P-SW-07

- (7) MORTAR BED
- (8) concrete slab/sub-floor by others. (9) sand bed per manufacturer's RECOMMENDATIONS
- (10) COMPACTED SUB-BASE PER MANUFACTURER'S RECOMMENDATIONS

Outdoor Furnishings

Side View

1) PLANK ADIRONDACK CHAIR

(2) POLYETHYLENE FRAME, REFER TO PLAN FOR COLOR

(6) MOVEABLE FURNITURE, NO SURFACE MOUNT

PEDESTRIAN PAVER

2" (51MM) PEDESTRIAN PAVER

(3) POLYETHYLENE ARMREST, REFER TO PLAN FOR COLOR

(4) RECYCLED PLASTIC PLANK SEATING SLATS, REFER TO PLAN FOR COLOR

ANOVA PLANK ADIRONDACK CHAIR

(5) RECYCLED PLASTIC PLANK BACK SLATS, REFER TO PLAN FOR COLOR

ANOVA 211 NORTH LINDBERGH, 2ND FLOOR ST. LOUIS, MO 63141 TOLL FREE: 1-888-535-5005 PHONE: (800) 231-1327

Front View

FINISH ELEV. —

___-

FINISH ELEV. — BY OTHERS.

BY OTHERS.

PAVER INSTALLATION ON CONCRETE SLAB

PAVER INSTALLATION ON COMPACTED SUB-BASE

TYPICAL SECTION

TYPICAL SECTION

PHONE: (314) 754-0835

Rear View

129343.13-57

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REGISTRATION

CRISTOBAL A. BETANCOURT, RLA REGISTRATION NO. 6666941 DATE: <u>5/6/2021</u>

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DRAWING TITLE

AMENITY DECK HARDSCAPE DETAILS

DRAWING NUMBER



P-OPCH-01

MANUFACTURER'S

STRUCTURAL PLANS


MANUFACTURER'S


PER ARCHITECTURAL/

STRUCTURAL PLANS

RECOMMENDATIONS



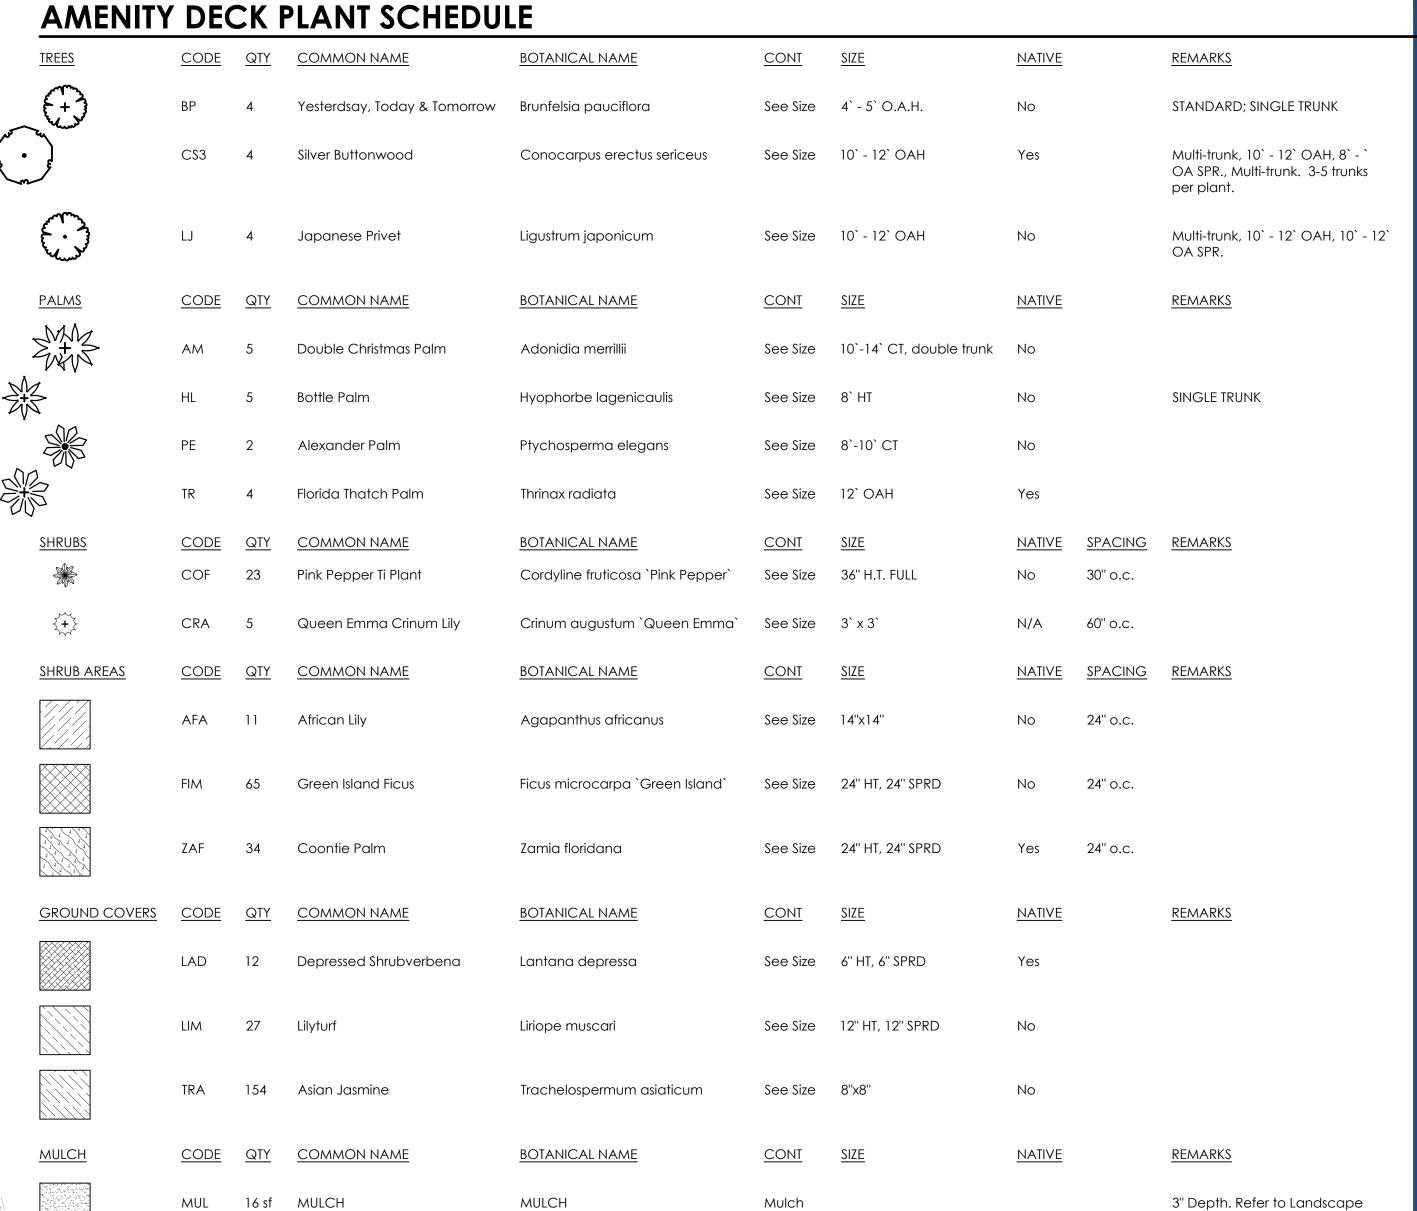

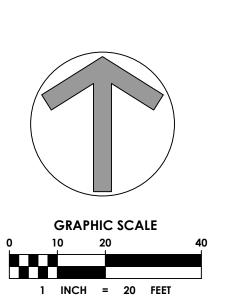

GM2
chen moore and associates

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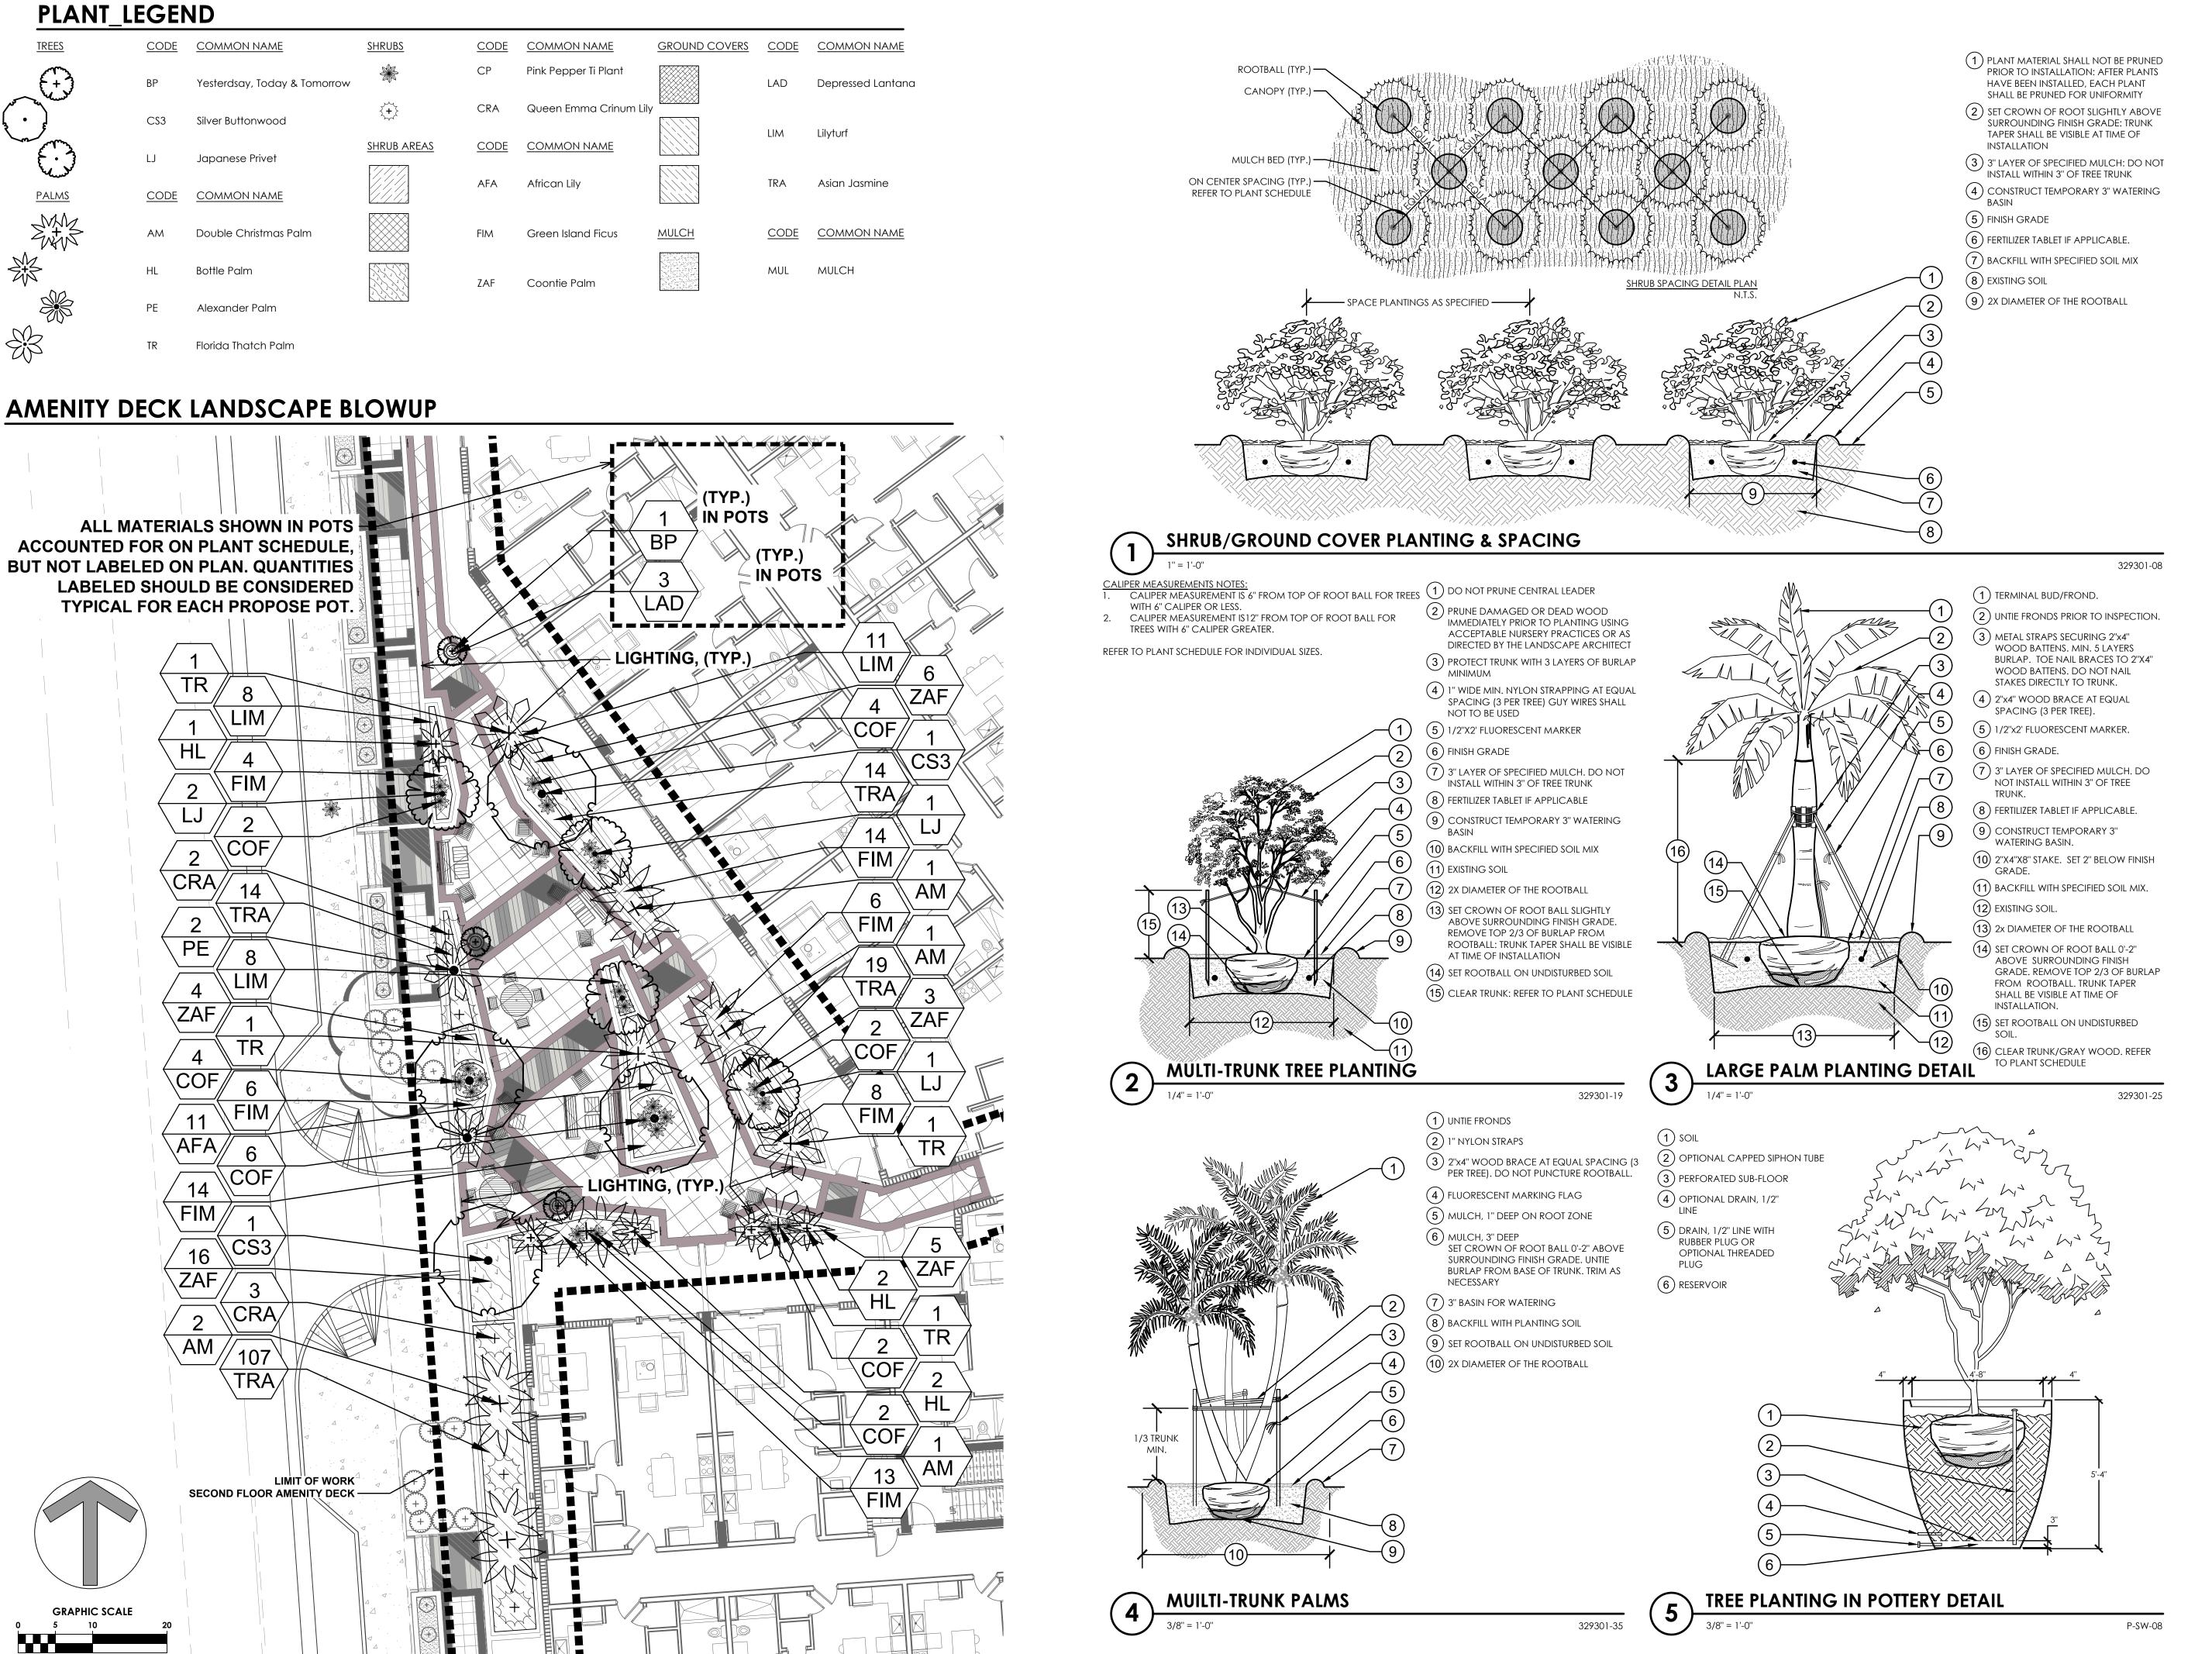
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AMENITY DECK LANDSCAPE PLAN

DRAWING NUMBER

Specifications



1 INCH = 10 FEET

cma

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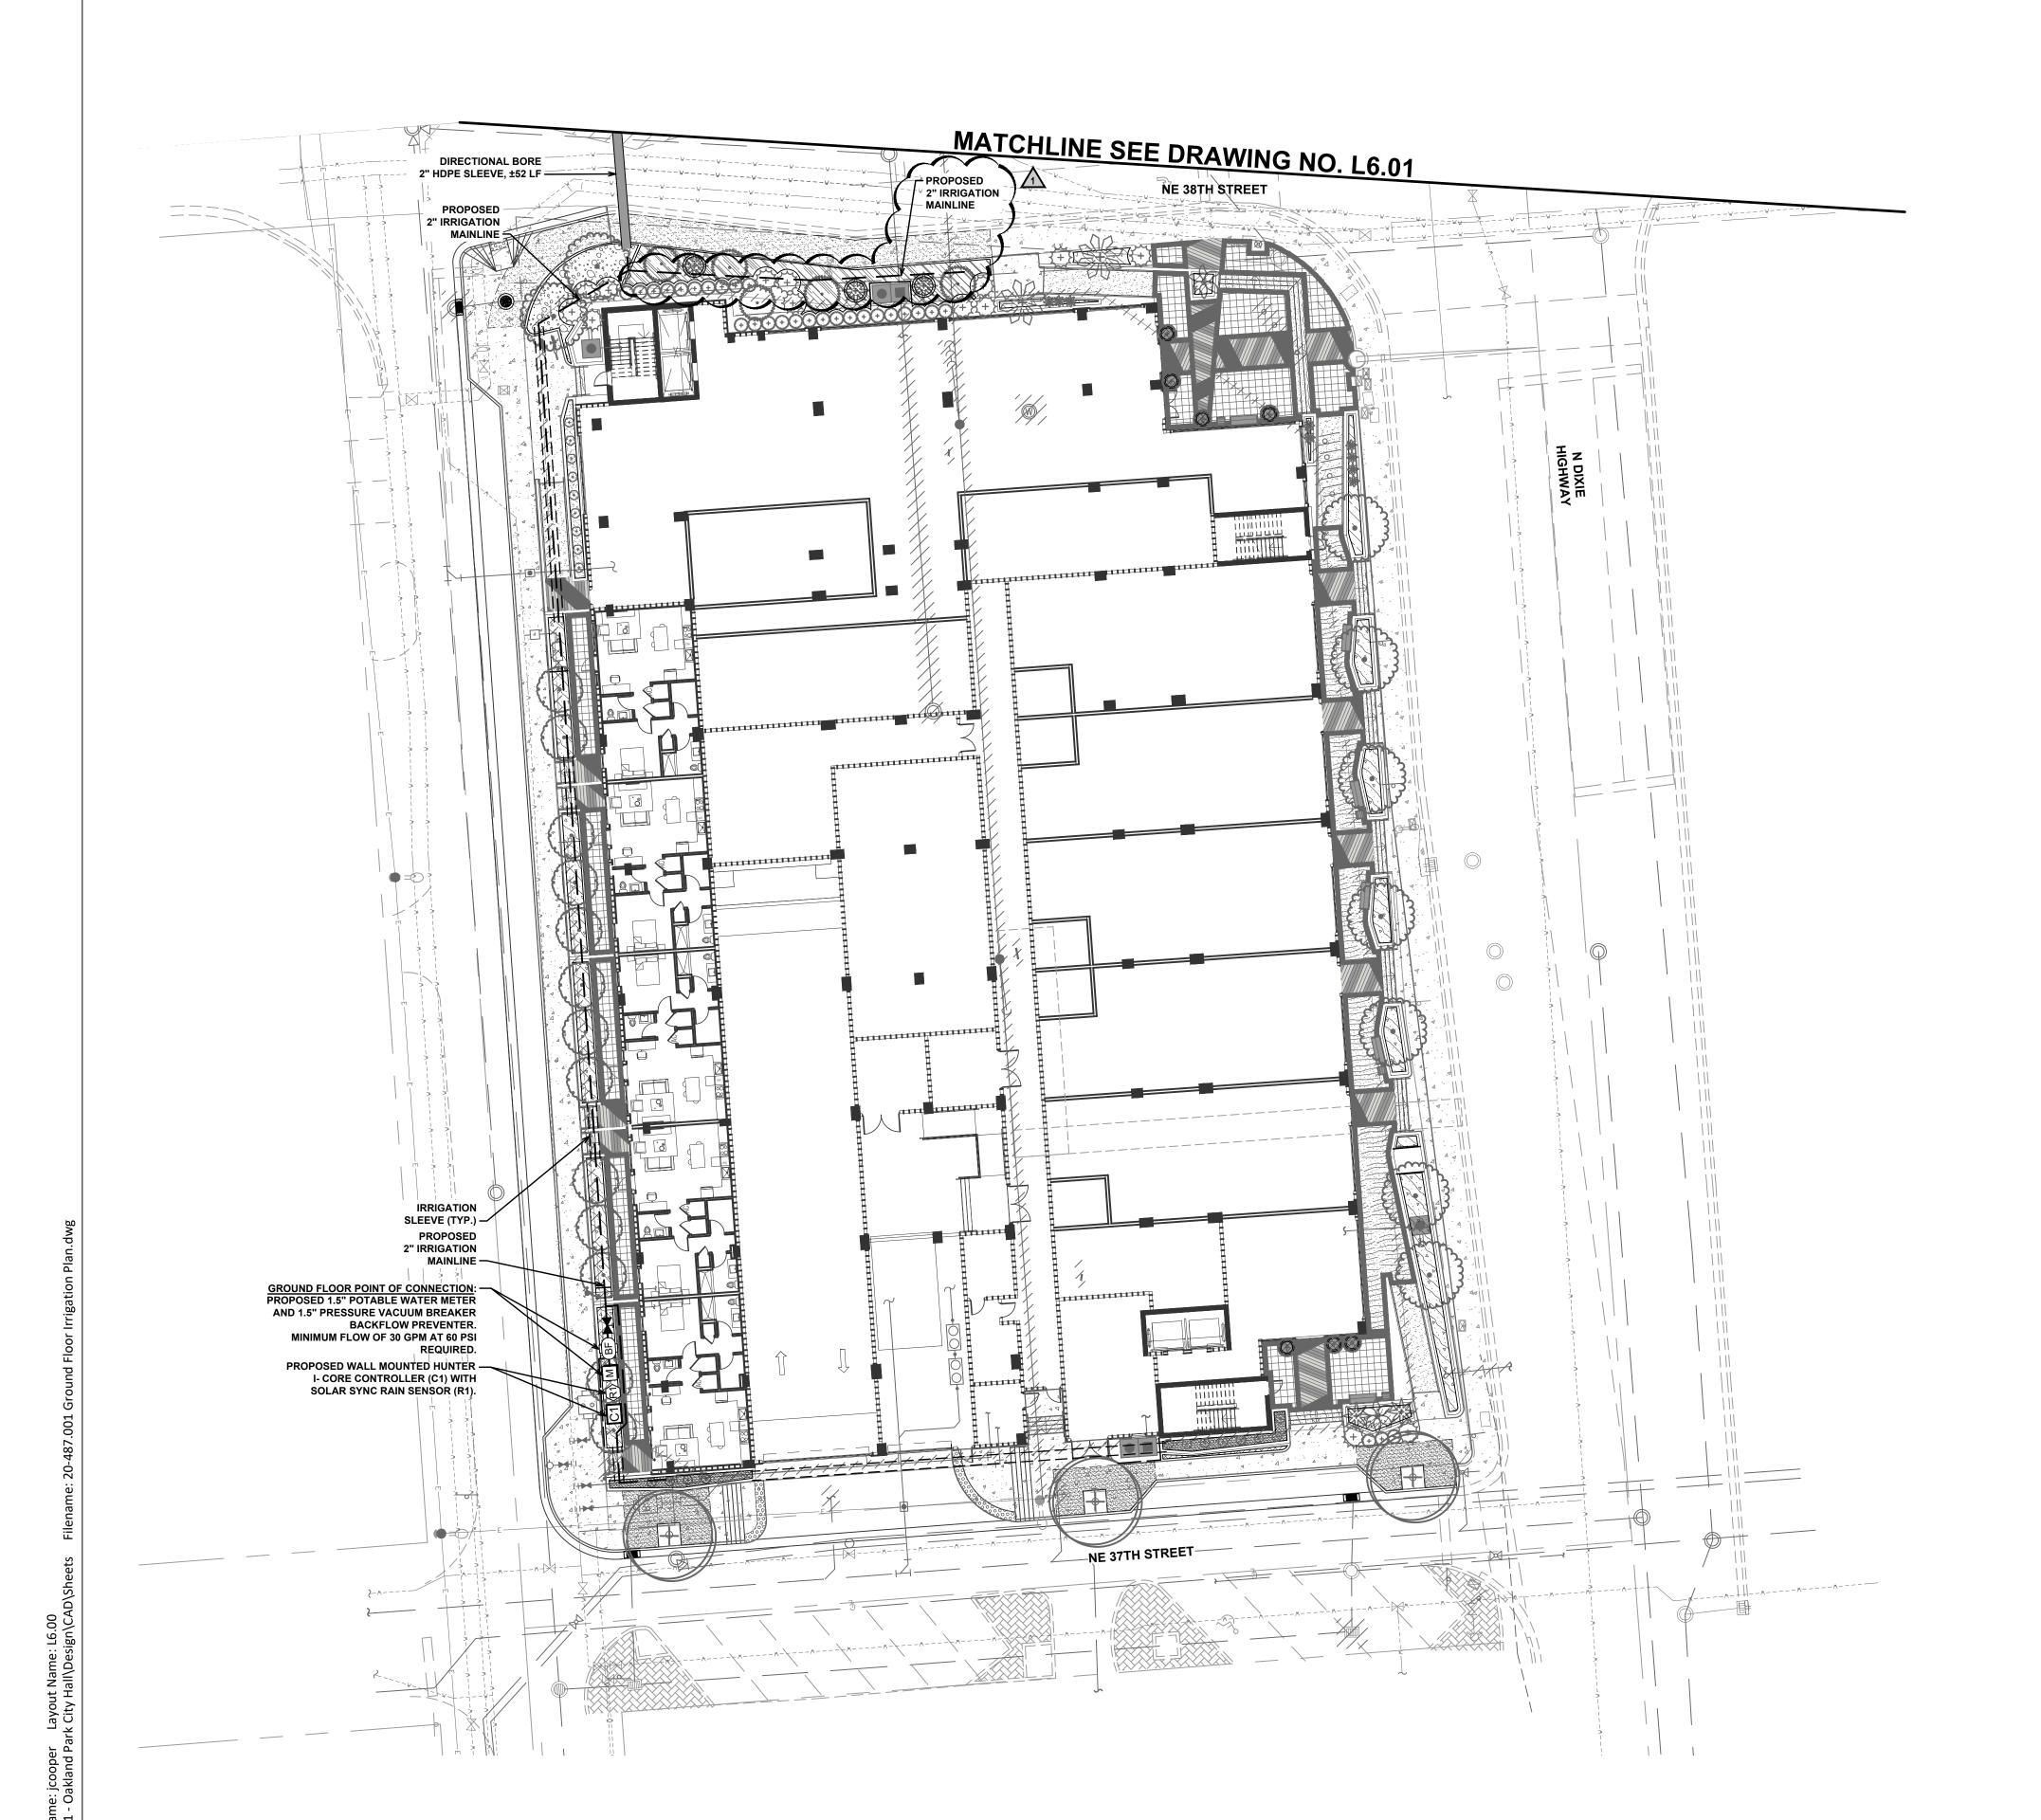
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AMENITY DECK LANDSCAPE DETAILS

DRAWING NUMBER

DRC SUBMITTAL. NOT FOR CONSTRUCTION.

L5.



GROUND LEVEL IRRIGATION LEGEND

Leemco LMV-11BB Gate Valve

SYMBOL

MANUFACTURER/MODEL

C1

Hunter IC-0600-SS Controller

Hunter Solar-Sync Rain/Freeze Sensor

Water Meter 1-1/2"

Irrigation Mainline: PVC Class 200 SDR 21
Pipe Sleeve: HDPE PE4710 DR 11

Pipe Sleeve: PVC Schedule 40

Valve Callout
Valve Number
Valve Flow
Valve Size

NOTE:

ALL LANDSCAPED AREAS WILL BE IRRIGATED WITH AN UNDERGROUND IRRIGATION SYSTEM, DESIGNED TO PROVIDE A MINIMUM COVERAGE AREA OF 100% WITH A 50% OVERLAP. FULL IRRIGATION PLANS WILL BE PROVIDED WITH CONSTRUCTION DOCUMENTS/ BUILDING PERMIT PLANS.

GMa

chen moore and associate500 West Cypress Creek Road
Suite 630

Ft. Lauderdale, FL 33309

954.730.0707

www.chenmoore.com

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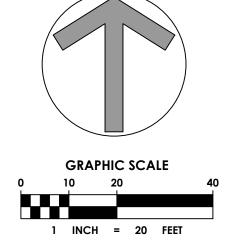
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DRAWING TITLE

GROUND LEVEL IRRIGATION PLAN

L6.00





GROUND LEVEL IRRIGATION LEGEND

MANUFACTURER/MODEL

Leemco LMV-11BB Gate Valve

C1 Hunter IC-0600-SS Controller

Hunter Solar-Sync Rain/Freeze Sensor

Water Meter 1-1/2"

Valve Callout
Valve Number
Valve Flow
Valve Size

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REGISTRATION NO. 6666941
DATE: 5/6/2021



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CLIENT

OAKLAND PARK DIXIE, LLC

PROJECT INFORMATION

SKY BUILDING

PROJECT NUMBER

20-487.001

CLIENT PROJECT NUMBER

VERIFY SCALES

0 ► 1"

IF NOT ONE INCH ON THIS SHEET,

ADJUST SCALES ACCORDINGLY

REVISIONS

⚠ DRC COMMENTS

DATE OF ISSUE 03.18.2021

DESIGNED BY

DRAWN BY

CHECKED BY


DRAWING TITLE


GROUND LEVEL IRRIGATION PLAN


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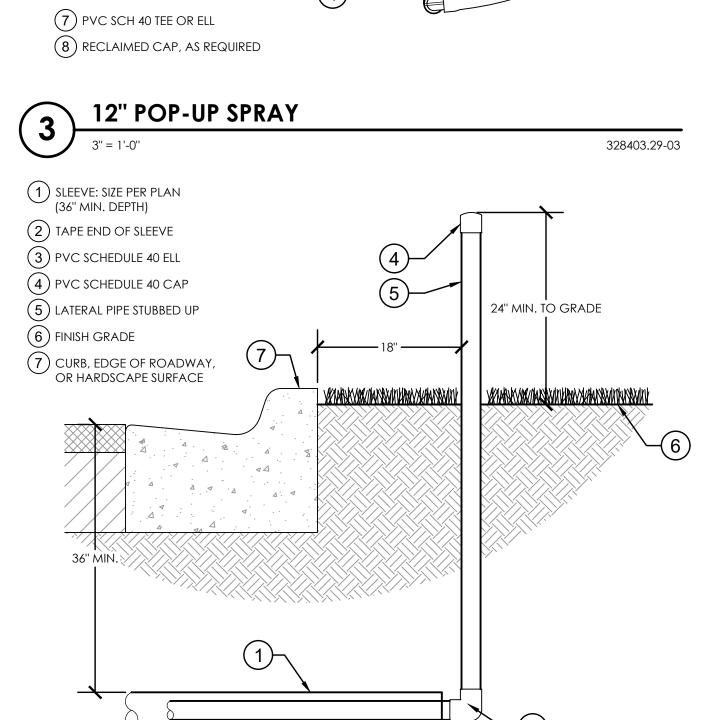
DRC SUBMITTAL. NOT FOR CONSTRUCTION.


1 INCH = 20 FEET



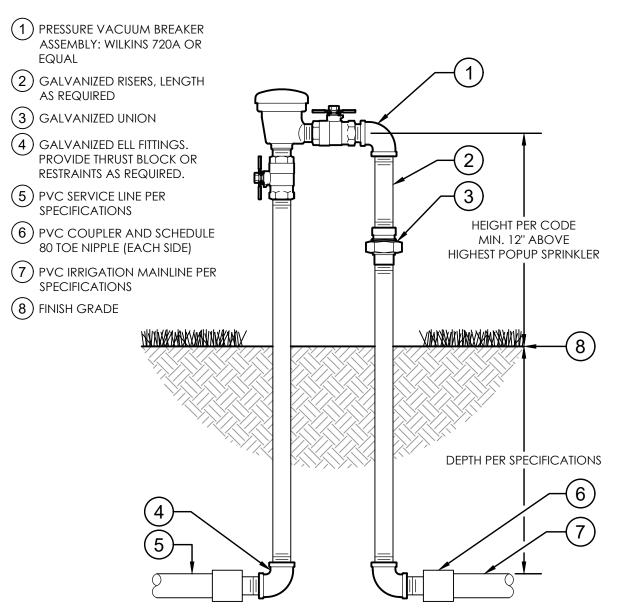


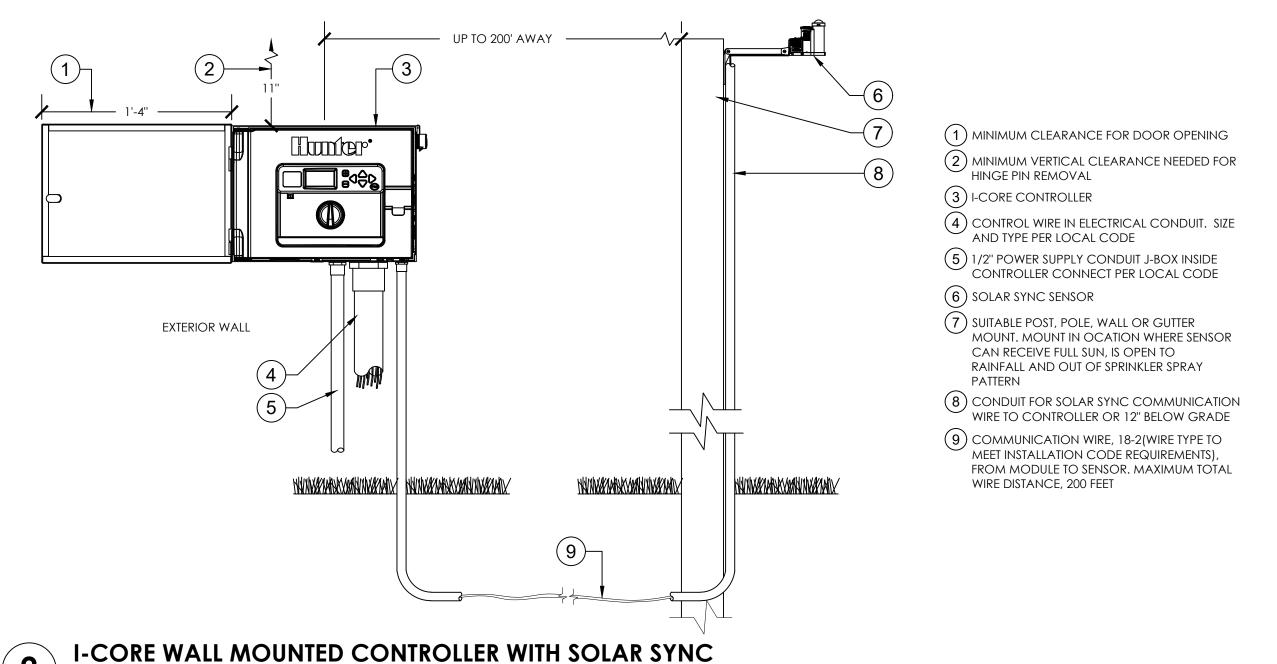

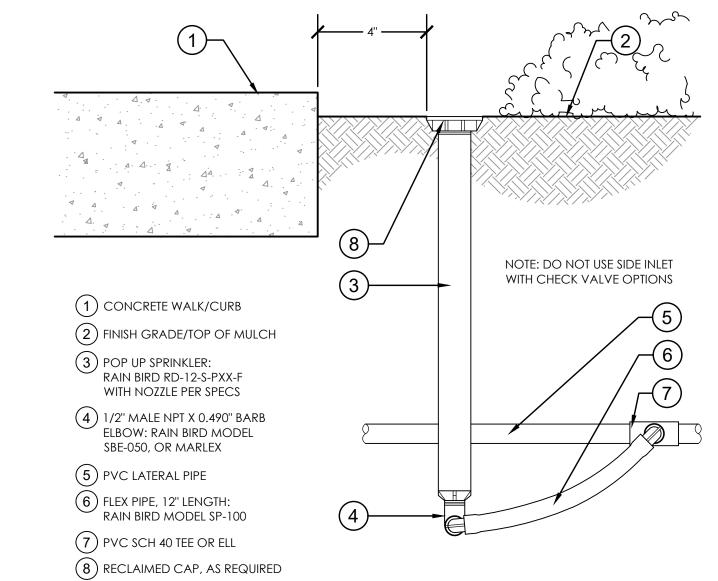

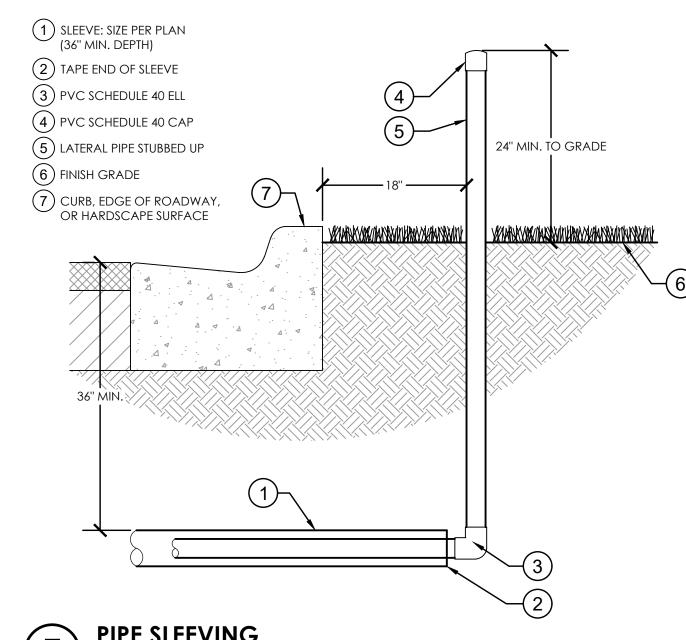



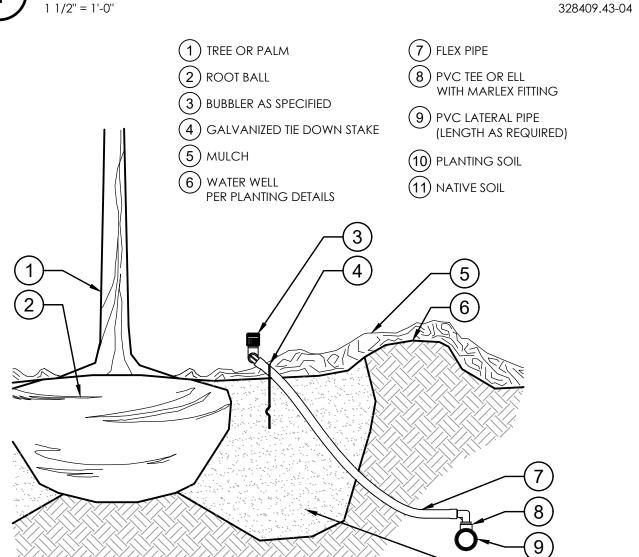

328403.53-06

328409.76-34

2 WATERPROOF CONNECTION (1 OF 2) (7) PVC SCH 40 ELL (3) ZONE ID TAG (8) PVC SCH 40 TEE (4) REMOTE CONTROL VALVE (9) PVC MAINLINE PIPE WITH PRESSURE REGULATOR SET 2" ABOVE FINISH GRADE IN MULCH AREAS

(6) PVC SCH 80 NIPPLE

PRESSURE REGULATING REMOTE CONTROL VALVE

1 1/2" = 1'-0"

(1) 30-INCH LINEAR LENGTH OF WIRE, (5) STANDARD VALVE BOX (10) PVC SCH 40 ADAPTER (11) 1/2" WIRE CLOTH GOPHER SCREEN WRAP ALL SIDES (12) BRICK (1 OF 4) (13) 6-INCH MINIMUM DEPTH 3/4" WASHED GRAVEL

(2) VALVE BOX (3) WIRE SCREEN CLOTH (4) BRICK (1 OF 4)

(1) FINISH GRADE

(6) ADS, SIZE AS REQUIRED (7) LEEMCO LMV-BB SERIES (OR EQUAL) BELL x BELL SELF-RESTRAINED, RESILIENT WEDGE GATE VALVE

(5) 6" DEPTH OF 3/4" MINUS GRAVEL


328409.13-30

TREE BUBBLER

ZONE CONTROL WIRE IN SCH 40 CONDUIT (SIZE AS REQUIRED)

(1) FINISH GRADE (2) NATIVE SOIL BACKFILL COMPACT TO 95% (3) IRRIGATION MAIN (AS SPECIFIED)

5) 100% COARSE SAND BEDDING, WATER JET & MECHANICALLY COMPACT TO 90% OPTIMUM DENSITY. ALLOW 48 HOURS TO SETTLE, AND BACKFILL AND COMPACT WITH NATIVE SOIL

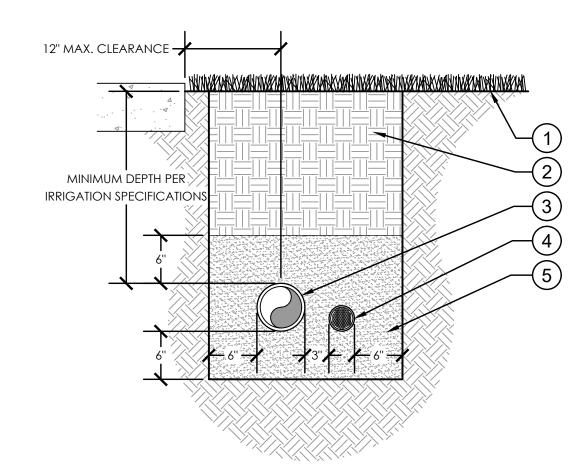

MAINLINE AND LATERAL TRENCH

GENERAL NOTES

- 1. ALL PLANTED AREAS WILL RECEIVE AN AUTOMATIC IRRIGATION SYSTEM, PROVIDING 100% COVERAGE WITH "HEAD TO HEAD" OR 50% OVERLAP, WITH THE OPTION TO SWITCH TO MANUAL OPERATION IN EMERGENCY SITUATIONS.
- 2. THE IRRIGATION SYSTEM WILL BE CAPABLE OF DISTRIBUTING 1-1/2" OF WATER PER WEEK DURING A MAXIMUM EIGHT (8) HOUR WATERING CYCLE.
- 3. THE IRRIGATION SYSTEM IS DESIGNED TO AVOID OVER SPRAY INTO PUBLIC AND PEDESTRIAN AREAS.
- 4. CONTRACTOR TO VERIFY LOCATION OF ALL EXISTING UTILITIES.
- 5. IT SHALL BE THE CONTRACTOR'S SOLE RESPONSIBILITY TO TAKE THE NECESSARY PRECAUTIONS TO ENSURE PROPER SAFETY AND WORKMANSHIP WHEN WORKING IN THE VICINITY OF EXISTING UTILITY LINES.
- 6. CONTRACTOR SHALL BE RESPONSIBLE TO COORDINATE WITH FPL ON ANY WORK IN THE VICINITY OF OVERHEAD OR UNDERGROUND POWER LINES.
- 7. CONTRACTOR SHALL VERIFY PROPER CLEARANCE BELOW EXISTING OVERHEAD POWER LINES PRIOR TO WORKING WITHIN THE VICINITY THE POWER LINES.
- 8. MAINLINE LOCATION, WHERE SHOWN, IS FOR GRAPHIC CLARITY PURPOSES ONLY. INSTALL AT THE BACK OF CURB, FRONT OF WALK, BACK OF WALK, OR ADJACENT TO OTHER HARDSCAPES TO FACILITATE FUTURE LOCATION AND TO PROTECT FROM DAMAGE. ENSURE MAINLINE IS INSTALLED ACCORDING TO THE IRRIGATION SPECIFICATIONS AND DETAILS.
- 9. IF IT IS NECESSARY TO HAVE PIPING UNDER HARDSCAPE ITEMS, SUCH AS ROADS, WALKS AND PATIOS, THE PIPES MUST BE SLEEVED WITH THE SLEEVE DIAMETER BEING AT LEAST TWICE THE SIZE OF THE PIPE IT IS CARRYING.
- 10. ANY MAJOR DESIGN CHANGES SHALL BE BROUGHT TO THE ATTENTION OF THE LANDSCAPE ARCHITECT OF RECORD PRIOR TO CONSTRUCTION; CONTRACTOR PROCEEDS WITH CHANGES AT OWN RISK.
- 11. NO SUBSTITUTIONS SHALL BE PERMITTED, EXCEPT WITH WRITTEN APPROVAL FROM THE LANDSCAPE ARCHITECT OF RECORD.

GROUND LEVEL IRRIGATION SCHEDULE

| SYMBOL | MANUFACTURER/MODEL/DESCRIPTION | QTY |
|------------|--|------------|
| | Leemco LMV-11BB Gate Valve 2" x 2" LMV-BB Series Mainline Gate Valve. Valve size same as pipe size. | 1 |
| C1 | Hunter IC-0600-SS Controller Modular Controller, 6 stations, Outdoor Model, Stainless Steel Cabinet. No Module Required. Commercial Use. | 1 |
| ₹ 1 | Hunter Solar-Sync Rain/Freeze Sensor Solar, rain/freeze sensor with outdoor interface. Includes 10 year lithium battery and rubber module cover, and gutter mount bracket. Wired. | 1 |
| M | Water Meter 1-1/2" 1.5" Potable Water Meter | 1 |
| | Irrigation Mainline: PVC Class 200 SDR 21 | 470.6 l.f. |
| | Pipe Sleeve: HDPE PE4710 DR 11 | 50.4 l.f. |
| ====== | Pipe Sleeve: PVC Schedule 40 Typical pipe sleeve for irrigation pipe. Pipe sleeve size shall allow for irrigation piping and their related couplings to easily slide through sleeving material. Extend sleeves 18-inches beyond edges of paving or construction. | 257.0 l.f. |
| | Valve Callout Valve Number | |
| | Valve Flow | |
| #"• | Valve Size | |
| | | |

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⚠ DRC COMMENTS

DRAWN BY

CHECKED BY

GROUND LEVEL

IRRIGATION NOTES AND DETAILS

DRAWING NUMBER

500 West Cypress Creek Road

Suite 630

Ft. Lauderdale, FL 33309

954.730.0707 www.chenmoore.com

CRISTOBAL A. BETANCOURT, RLA REGISTRATION NO. 6666941 DATE: <u>5/6/2021</u>

REGISTRATION

STATE

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1. GENERAL

- 1.1. THE SYSTEM HAS BEEN DESIGNED TO CONFORM WITH THE REQUIREMENTS OF ALL APPLICABLE CODES. SHOULD ANY CONFLICT EXIST, THE REQUIREMENTS OF THE CODES SHALL PREVAIL. IT IS THE RESPONSIBILITY OF THE OWNER/INSTALLATION CONTRACTOR TO INSURE THE ENTIRE SYSTEM IS INSTALLED ACCORDING TO ALL APPLICABLE LAWS, RULES, REGULATIONS AND CONVENTIONS. IRRIGATION CONTRACTOR IS RESPONSIBLE FOR OBTAINING ALL REQUIRED PERMITS ACCORDING TO FEDERAL, STATE AND LOCAL LAWS.
- 1.2. CONTRACTOR TO VERIFY LOCATION OF ALL EXISTING UTILITIES.
- 1.3. IT SHALL BE THE CONTRACTOR'S SOLE RESPONSIBILITY TO TAKE THE NECESSARY PRECAUTIONS TO ENSURE PROPER SAFETY AND WORKMANSHIP WHEN WORKING IN THE VICINITY OF EXISTING UTILITY LINES.
- 1.4. CONTRACTOR SHALL BE RESPONSIBLE TO COORDINATE AND VERIFY PROPER CLEARANCE WITH FPL ON ANY WORK IN THE VICINITY OF OVERHEAD OR UNDERGROUND POWER LINES.
- 1.5. THE CONTRACTOR MUST SUBMIT FOR APPROVAL, PRIOR TO INSTALLATION, COPIES OF THE MANUFACTURER'S CUT SHEETS/SPECIFICATIONS FOR ALL COMPONENTS TO BE USED IN THE IRRIGATION SYSTEM.
- 1.6. THE IRRIGATION CONTRACTOR SHALL BE CERTIFIED AS A CERTIFIED IRRIGATION CONTRACTOR BY THE IRRIGATION ASSOCIATION. THE CERTIFICATION SHALL BE CURRENT AND IN GOOD STANDING.

2. SCOPE OF WORK

- 2.1. THE WORK SPECIFIED IN THIS SECTION CONSISTS OF FURNISHING ALL COMPONENTS NECESSARY FOR THE INSTALLATION, TESTING, AND DELIVERY OF A COMPLETE, FULLY FUNCTIONAL AUTOMATIC LANDSCAPE IRRIGATION SYSTEM THAT COMPLETELY COMPLIES WITH THE 100% IRRIGATION PLANS, SPECIFICATIONS, NOTES, DETAILS AND ALL APPLICABLE LAWS, REGULATIONS, CODES AND ORDINANCES. THIS WORK SHALL INCLUDE, BUT NOT BE LIMITED TO, THE PROVIDING OF ALL REQUIRED MATERIAL (PIPE, VALVES, FITTINGS, CONTROLLERS, WIRE, PRIMER, GLUE, ETC.), LAYOUT, PROTECTION OF THE PUBLIC, EXCAVATION, ASSEMBLY, INSTALLATION, BACK FILLING, COMPACTING, REPAIR OF ROAD SURFACES, CONTROLLER AND LOW VOLTAGE FEEDS TO VALVES, CLEANUP, MAINTENANCE, GUARANTEE AND AS-BUILT PLANS.
- 2.2. ALL IRRIGATED AREAS SHALL PROVIDE 100% HEAD-TO-HEAD COVERAGE FROM A FULLY AUTOMATIC IRRIGATION SYSTEM WITH A RAIN SENSOR AS SHOWN. THE RAIN SENSOR SHALL BE INSTALLED TO PREVENT ITS ACTIVATION BY ADJACENT HEADS. ALL WATERING PROCEDURES SHALL CONFORM TO LOCAL CODES, AS WELL AS THIS PROJECT'S REGIONAL WATER MANAGEMENT DISTRICT RESTRICTIONS AND REGULATIONS. ZONES ARE PRIORITIZED FIRST BY PUBLIC SAFETY AND THEN BY HYDRAULIC CONCERNS. THIS SEQUENCING WILL BE A MANDATORY PUNCH LIST ITEM. THESE PLANS HAVE BEEN DESIGNED TO SATISFY/EXCEED THE FLORIDA BUILDING CODE (FBC) APPENDIX F AND THE FLORIDA IRRIGATION SOCIETY STANDARDS AND SPECIFICATIONS FOR TURF AND LANDSCAPE IRRIGATION SYSTEMS, FOURTH EDITION.
- 2.3. CONTRACTOR SHALL VERIFY THE LOCATION OF ALL UNDERGROUND UTILITIES 72 HOURS PRIOR TO COMMENCEMENT OF WORK.
- 2.4. IT IS THE RESPONSIBILITY OF THE IRRIGATION CONTRACTOR TO FAMILIARIZE THEMSELVES WITH ALL GRADE DIFFERENCES, LOCATION OF WALLS, RETAINING WALLS, STRUCTURES AND UTILITIES. DO NOT WILLFULLY INSTALL THE SPRINKLER SYSTEM AS SHOWN ON THE DRAWINGS WHEN IT IS OBVIOUS IN THE FIELD THAT UNKNOWN OBSTRUCTION, GRADE DIFFERENCES OR DIFFERENCES IN THE AREA DIMENSIONS EXIST THAT MIGHT NOT HAVE BEEN CONSIDERED IN THE DESIGN. SUCH OBSTRUCTIONS, OR DIFFERENCES, SHOULD BE BROUGHT TO THE ATTENTION OF THE OWNER' AUTHORIZED REPRESENTATIVE. IN THE EVENT THIS NOTIFICATION IS NOT PERFORMED, THE IRRIGATION CONTRACTOR SHALL ASSUME FULL RESPONSIBILITY FOR ANY REVISIONS NECESSARY.
- 2.5. IRRIGATION CONTRACTOR SHALL REPAIR OR REPLACE ALL EXISTING SITE ITEMS DAMAGED BY THEIR WORK. IRRIGATION CONTRACTOR SHALL COORDINATE THEIR WORK WITH OTHER CONTRACTORS FOR THE LOCATION AND INSTALLATION OF PIPE SLEEVES AND LATERALS THROUGH WALLS, UNDER ROADWAYS AND PAVING, ETC.
- 2.6. THE CONTRACTOR SHALL TAKE IMMEDIATE STEPS TO REPAIR, REPLACE, OR RESTORE ALL SERVICES TO ANY UTILITIES WHICH ARE DISRUPTED DUE TO THEIR OPERATIONS. ALL COSTS INVOLVED IN DISRUPTION OF SERVICE AND REPAIRS DUE TO NEGLIGENCE ON THE PART OF THE CONTRACTOR SHALL BE THE CONTRACTOR'S RESPONSIBILITY.

3. <u>SUBMITTALS</u>

- 3.1. THE CONTRACTOR SHALL PROVIDE FOR APPROVAL PRIOR TO INSTALLATION, MANUFACTURER'S PRODUCT DESCRIPTION SHEETS/SPECIFICATIONS FOR ALL MAJOR COMPONENTS OF THE IRRIGATION SYSTEM. MODEL NUMBERS SHALL BE HIGHLIGHTED OR CIRCLED.
- 3.2. NO SUBSTITUTIONS OR DEVIATIONS FROM THE SPECIFIED BRANDS, MODELS, OR SIZES SHALL BE PERMITTED, EXCEPT WITH WRITTEN APPROVAL FROM THE LANDSCAPE ARCHITECT OF RECORD.
- 3.3. ANY MAJOR DESIGN CHANGES SHALL BE BROUGHT TO THE ATTENTION OF THE LANDSCAPE ARCHITECT OF RECORD PRIOR TO CONSTRUCTION; CONTRACTOR PROCEEDS WITH CHANGES AT OWN RISK. DESIGN CHANGES, SUBSTITUTIONS, OR DEVIATIONS NOT APPROVED BY THE LANDSCAPE ARCHITECT OF RECORD WILL RESULT IN REJECTION AND REPLACEMENT OF MATERIALS AT NO ADDITIONAL COST TO THE OWNER.
- 4. POST CONSTRUCTION DOCUMENTATION
- 4.1. DOCUMENTATION:
- 4.1.1. PROVIDE THE MANUFACTURERS' RECOMMENDED OPERATING INSTRUCTIONS FOR ALL MAJOR COMPONENTS INCORPORATED INTO THE IRRIGATION SYSTEM.
- .1.2. PROVIDE SYSTEM OPERATION MANUALS, MAINTENANCE SCHEDULES, RECOMMENDED SCHEDULE OF OPERATION INCLUDED AVERAGE APPLICATION RATES WITH SEASONAL ADJUSTMENTS FOR EACH ZONE.
- 4.1.3. PROVIDE ALL REQUIRED TESTING AND INSPECTION CERTIFICATES TO THE OWNER OR OWNER'S REPRESENTATIVE
- 4.2. AS-BUILT DRAWINGS: PROVIDE RECORD DRAWINGS AND PLANS SHOWING ALL CHANGES IN THE DESIGN TO INDICATE THE ACTUAL INSTALLATION AND LOCATION OF ALL EQUIPMENT AND MATERIALS. THE FOLLOWING SPECIFIC ITEMS MUST BE INCLUDED:
- 4.2.1. LOCATION AND SIZE OF MAINLINE PIPING, LATERAL PIPING, AND PIPE SLEEVING.
- 4.2.2. ISOLATION VALVES
- 4.2.3. REMOTE CONTROL VALVE LOCATIONS, SIZES, NUMBER, AND AREA OF COVERAGE SHOWN USING DIFFERENT COLORS.
- 4.2.4. SPLICE BOXES AND LOW VOLTAGE WIRING PATH.
- 4.2.5. CONTROLLER AND RAIN SHUTOFF DEVICES.

OR PROFESSIONAL ENGINEER.

- 4.2.6. POINT OF CONNECTION INCLUDING THE TYPE OF WATER SOURCE, SIZE, FLOW RATE, AND OPERATING PRESSURE.
- 4.2.7. DATE AND SCALE.
- 4.2.8. CONTRACTOR'S NAME, ADDRESS, AND TELEPHONE NUMBER.
 4.2.9. THE AS-BUILT DRAWINGS SHALL BE SIGNED BY A FLORIDA REGISTERED LANDSCAPE ARCHITECT

4.3. CONTRACTOR SHALL FURNISH FIVE EXTRA UNITS OF EACH TYPE OF POPUP SPRAY AND EMITTER THAT MATCH PRODUCTS INSTALLED AND THAT ARE PACKAGED WITH PROTECTIVE COVERING FOR STORAGE AND IDENTIFIED WITH LABELS DESCRIBING CONTENTS. INCLUDE TOOLS TO SERVICE THESE PRODUCTS.

5. FINAL ACCEPTANCE

- 5.1. FINAL ACCEPTANCE OF THE IRRIGATION SYSTEM WILL BE GIVEN AFTER THE FOLLOWING DOCUMENTS AND CONDITIONS HAVE BEEN COMPLETED AND APPROVED. FINAL PAYMENT WILL NOT BE RELEASED UNTIL THESE CONDITIONS ARE SATISFIED.
- 5.1.1. FINAL WALK-THRU AND CORRECTION OF ALL PUNCH LIST ITEMS.
- 5.1.2. COMPLETION AND ACCEPTANCE OF AS-BUILT RECORD DRAWINGS.5.1.3. TURNOVER OF ALL REQUIRED PARTS AND TOOLS AS OUTLINED IN THE PROJECT SPECIFICATIONS.
- 6. GUARANTEE
- 6.1. FULLY WARRANT THE LANDSCAPE IRRIGATION SYSTEM FOR A PERIOD OF ONE (1) YEAR AFTER THE WRITTEN FINAL ACCEPTANCE.
- 6.2. DURING THE WARRANTY PERIOD, ENFORCE MANUFACTURER'S AND SUPPLIER'S WARRANTIES.

 MALFUNCTIONS, DEFICIENCIES, BREAKS, DAMAGES, DISREPAIR OR OTHER DISORDERS DUE TO

 MATERIALS, WORKMANSHIP, OR INSTALLATION BY THE CONTRACTOR AND HIS SUPPLIERS SHALL BE
 IMMEDIATELY AND PROPERLY CORRECTED.
- 6.3. REPAIR DAMAGES PROMPTLY WHICH ARE CAUSED BY SYSTEM MALFUNCTION.

7 POINT OF CONNECTION (P.O.C.)

- 7.1. THE POC FOR THE GROUND LEVEL IS A PROPOSED 1.5" POTABLE WATER METER WITH A 1.5" PRESSURE VACUUM BREAKER BACKFLOW PREVENTER, UTILIZING AN EXISTING MUNICIPAL POTABLE WATER MAIN. THE POC SHALL BE CAPABLE OF SUPPLYING A MINIMUM OF 30 GPM AT 60 PSI. CONTRACTOR SHALL VERIFY THESE MINIMUM CONDITIONS CAN BE MET PRIOR TO BEGINNING IRRIGATION SYSTEM INSTALLATION.
- 7.2. THE POC FOR THE AMENITY DECK IS A 1" RPZ BACKFLOW PREVENTER INSTALLED IN THE MEP/FIRE RISER ROOM ON THE 2ND FLOOR OF THE BUILDING BY THE BUILDING PLUMBING CONTRACTOR. THE POC SHALL BE CAPABLE OF SUPPLYING A MINIMUM OF 20 GPM AT 60 PSI.
- 7.3. IF THE CONDITIONS CAN NOT BE MET, THE CONTRACTOR MUST NOTIFY THE DESIGNER PRIOR TO PROCEEDING WITH THE WORK. IF THE CONTRACTOR DOES NOT DO SO, THE CONTRACTOR PROCEEDS AT THEIR OWN RISK AND BECOMES RESPONSIBLE FOR ANY FUTURE WORK REQUIRED TO MAKE THE SYSTEM PERFORM AS REQUIRED.

8 PIPING

- 8.1. MAINLINE PIPE: PVC CLASS 200 SDR 21, NON-GASKETED, SOLVENT WELD, WITH SCHEDULE 40 PVC
- 8.2. LATERAL PIPE: PVC CLASS 200 SDR 21, NON-GASKETED, SOLVENT WELD, WITH SCHEDULE 40 PVC
- 8.3. THREADED PIPE: PVC SCHEDULE 80.
- 8.4. PIPE LOCATIONS SHOWN ON THE PLAN ARE SCHEMATIC AND SHALL BE ADJUSTED IN THE FIELD.
 WHEN LAYING OUT MAINLINES PLACE A MAXIMUM OF 12" AWAY FROM EITHER THE BACK OF CURB,
 FRONT OF WALK, BACK OF WALK, OR OTHER HARDSCAPE TO ALLOW FOR EASE IN LOCATING AND
 PROTECTION FROM PHYSICAL DAMAGE. INSTALL ALL LATERAL PIPE NEAR EDGES OF PAVEMENT OR
 AGAINST BUILDINGS WHENEVER POSSIBLE TO ALLOW SPACE FOR PLANT ROOT BALLS. ALWAYS
 INSTALL PIPING INSIDE PROJECT PROPERTY BOUNDARY.
- .5. PIPES SHALL ALWAYS BE PLACED IN PLANTING BEDS. IF IT IS NECESSARY TO HAVE PIPING UNDER HARDSCAPES, SUCH AS ROADS, WALKS, AND PATIOS, THE PIPES MUST BE SLEEVED USING SCH 40 PVC WITH THE SLEEVE DIAMETER BEING TWICE THE SIZE OF THE PIPE IT IS CARRYING WITH A MINIMUM SLEEVE SIZE OF 2".
- 8.6. PIPE SIZES SHALL CONFORM TO THOSE SHOWN ON THE DRAWINGS. NO SUBSTITUTIONS OF SMALLER PIPE SIZES SHALL BE PERMITTED, BUT SUBSTITUTIONS OF LARGER SIZES MAY BE APPROVED. ALL DAMAGED AND REJECTED PIPE SHALL BE REMOVED FROM THE SITE AT THE TIME OF SAID REJECTION.
- 8.7. CONTRACTOR TO ENSURE ALL MAINLINE PIPING IS PROPERLY RESTRAINED USING MECHANICAL JOINT FITTINGS, RESTRAINING COLLARS, THREADED RODS, THRUST BLOCKS, ETC., AS AND WHERE REQUIRED. CONTRACTOR SHALL REFER TO PIPE MANUFACTURER'S RECOMMENDED INSTALLATION PRACTICES FOR FURTHER DIRECTION.
- 8.8. PVC PIPE JOINT COMPOUND AND PRIMER: SLOW-DRYING, HEAVY DUTY CEMENT AND TINTED

 (PURPLE) PRIMER THAT IS COMPATIBLE WITH THE CEMENT. THE PVC CEMENT SHALL BE WELD-ON 2711
- GREY AND THE PRIMER SHALL BE WELD-ON P70 PURPLE PRIMER, OR APPROVED EQUALS.

 8.9. MAIN LINE PIPE DEPTH MEASURED TO THE TOP OF PIPE SHALL BE 18" MINIMUM, 36" MINIMUM AT VEHICULAR CROSSINGS.
- 8.10. LATERAL LINE DEPTHS MEASURED TO TOP OF PIPE SHALL BE 12" MINIMUM, 30" MINIMUM AT VEHICULAR CROSSINGS.

9. EXPOSED AND HANGING PIPING

- 9.1. EXPOSED MAINLINE PIPE: STEEL SCHEDULE 40, HOT-DIPPED GALVANIZED, WITH SCHEDULE 40 MALLEABLE IRON FITTINGS.
- 9.2. EXPOSED LATERAL PIPE: PVC SCHEDULE 40, SOLVENT WELD, WITH SCHEDULE 40 PVC FITTINGS.
- 9.3. EXPOSED THREADED PIPE: STEEL SCHEDULE 80, HOT-DIPPED GALVANIZED.
- 9.4. PIPE LOCATIONS SHOWN ON THE PLAN ARE SCHEMATIC AND SHALL BE ADJUSTED IN THE FIELD.

 WHEN LAYING OUT EXPOSED MAINLINES AND LATERALS PLACE A MAXIMUM OF 12" AWAY FROM

 THE EDGE OF STRUCTURAL SUPPORTS TO ALLOW FOR EASE IN LOCATING AND PROTECTION FROM

 PHYSICAL DAMAGE. INSTALL ALL LATERAL PIPE WITHIN PLANTERS NEAR EDGES PLANTER WALLS OR

 STRUCTURAL SUPPORTS WHENEVER POSSIBLE TO ALLOW SPACE FOR PLANT ROOT BALLS.
- 5. WHERE NECESSARY, EXPOSED MAINLINE AND LATERAL PIPING SHALL BE HUNG AND SECURED UTILIZING CLEVIS TYPE PIPE HANGERS AND SUPPORTS. ALL EXPOSED PIPING SHALL BE MECHANICALLY RESTRAINED.
- 9.8. CONTRACTOR TO ENSURE ALL MAINLINE PIPING IS PROPERLY RESTRAINED USING MECHANICAL JOINT FITTINGS, RESTRAINING COLLARS, THREADED RODS, THRUST BLOCKS, ETC., AS AND WHERE REQUIRED. CONTRACTOR SHALL REFER TO PIPE MANUFACTURER'S RECOMMENDED INSTALLATION PRACTICES FOR FURTHER DIRECTION.
- 9.9. ALL SLAB AND WALL PENETRATIONS SHALL BE WATERPROOFED PER THE ARCHITECTURAL DRAWINGS AND SPECIFICATIONS. WATERPROOFED PENETRATIONS BETWEEN PLANTER WALLS ARE PREFERRED OVER WATERPROOFED SLAB PENETRATIONS.
- 9.10. PIPE SIZES SHALL CONFORM TO THOSE SHOWN ON THE DRAWINGS. NO SUBSTITUTIONS OF SMALLER PIPE SIZES SHALL BE PERMITTED, BUT SUBSTITUTIONS OF LARGER SIZES MAY BE APPROVED. ALL DAMAGED AND REJECTED PIPE SHALL BE REMOVED FROM THE SITE AT THE TIME OF SAID REJECTION.
- .11. MAIN LINE PIPE DEPTH MEASURED TO THE TOP OF PIPE SHALL BE 18" MINIMUM, 36" MINIMUM AT VEHICULAR CROSSINGS.

) LAYOUT

- 10.1. LAY OUT IRRIGATION SYSTEM MAINLINES AND LATERAL LINES. MAKE THE NECESSARY ADJUSTMENTS AS REQUIRED TO TAKE INTO ACCOUNT ALL SITE OBSTRUCTIONS AND LIMITATIONS PRIOR TO EXCAVATING TRENCHES.
- 10.2. STAKE ALL SPRINKLER HEAD LOCATIONS. ADJUST LOCATION AND MAKE THE NECESSARY MODIFICATIONS TO NOZZLE TYPES, ETC. REQUIRED TO INSURE 100% HEAD TO HEAD COVERAGE. REFER TO THE EDGE OF PAVEMENT DETAIL ON THE IRRIGATION DETAIL SHEET.
- 10.3. SPRAY HEADS SHALL BE INSTALLED 4" FROM SIDEWALKS OR CURBED ROADWAYS AND 12" FROM UNCURBED ROADWAYS AND BUILDING FOUNDATIONS. ROTORS SHALL BE INSTALLED 4" FROM SIDEWALKS OR CURBED ROADWAYS, 12" FROM BUILDING FOUNDATIONS, AND 36" FROM UNCURBED ROADWAYS.
- 10.4. SHRUB HEADS SHALL BE INSTALLED ON 3/4" SCH 40 PVC RISERS. THE RISERS SHALL BE SET AT A MINIMUM OF 18" OFF SIDEWALKS, ROADWAY CURBING, BUILDING FOUNDATIONS, AND/OR ANY OTHER HARDSCAPED AREAS. SHRUB HEADS SHALL BE INSTALLED TO A STANDARD HEIGHT OF 4" BELOW MAINTAINED HEIGHT OF PLANTS AND SHALL BE INSTALLED WITHIN PLANTED MASSES TO BE LESS VISIBLE AND OFFER PROTECTION. PAINT ALL SHRUB RISERS WITH FLAT BLACK OR FOREST GREEN PAINT, UNLESS IRRIGATION SYSTEM WILL BE INSTALLED FROM A REUSE WATER SYSTEM WITH PURPLE PVC RISERS.
- 10.5. LOCATE VALVES PRIOR TO EXCAVATION. INSURE THAT THEIR LOCATION PROVIDES FOR EASY ACCESS AND THAT THERE IS NO INTERFERENCE WITH PHYSICAL STRUCTURES, PLANTS, TREES, POLES, ETC. VALVE BOXES MUST BE PLACED A MINIMUM OF 12" AND A MAXIMUM OF 15" FROM THE EDGE OF PAVEMENT, CURBS, ETC., AND THE TOP OF THE BOX MUST BE 2" ABOVE FINISH GRADE. NO VALVE BOXES SHALL BE INSTALLED IN TURF AREAS WITHOUT APPROVAL BY THE IRRIGATION DESIGNER; ONLY IN SHRUB BEDS. NEVER INSTALL VALVE BOXES WITHIN A SPORTS FIELD OR DESIGNATED PLAY AREA.

8. ELECTRICAL POWER SUPPLY

- 8.1. ELECTRICAL SUPPLY FOR PUMP AND CONTROLLER SHALL TO BE PROVIDED BY THE IRRIGATION CONTRACTOR. CONTRACTOR TO COORDINATE WITH LOCAL UTILITIES FOR THE INSTALLATION OF AND CONNECTION TO AVAILABLE SITE POWER SUPPLY FOR REQUIRED ELECTRICAL COMPONENTS AS SET FORTH IN THE 100% IRRIGATION PLANS.
- 8.2. ALL ELECTRICAL INSTALLATION TO COMPLY WITH THE NATIONAL ELECTRICAL CODE AND ANY AND ALL OTHER APPLICABLE ELECTRICAL CODES, LAWS AND REGULATIONS. A LICENSED ELECTRICIAN SHALL PERFORM ALL ELECTRICAL HOOK-UPS. POWER FOR THE CONTROLLER SHALL BE 120 VOLT, 20 AMP.

9. CONTROL WIRING

- 9.1. IRRIGATION CONTROL WIRE SHALL BE THERMOPLASTIC SOLID COPPER, SINGLE CONDUCTOR, LOW VOLTAGE IRRIGATION CONTROLLER WIRE SUITABLE FOR DIRECT BURIAL AND CONTINUOUS OPERATION AT RATED VOLTAGES.
- 9.2. ALL CONTROL WIRING SHALL BE PLACED IN PVC SCHEDULE 40 GRAY ELECTRICAL CONDUIT. AT TURNS IN DIRECTION UTILIZE JUNCTION BOXES. WHERE NECESSARY, EXPOSED CONTROL WIRE CONDUIT SHALL BE HUNG AND SECURED UTILIZING PIPE HANGERS AND SUPPORTS.
- 9.3. TAPE AND BUNDLE CONTROL WIRES EVERY 10' AND RUN ADJACENT TO THE MAINLINE. AT ALL TURNS IN DIRECTION MAKE A 2' COIL OF WIRE. AT ALL VALVE BOXES COIL WIRE AROUND A 3/4" PIECE OF PVC PIPE TO MAKE A COIL USING 30 LINEAR INCHES OF WIRE. MAKE ELECTRICAL CONNECTIONS WITH 3M-DBY, DBR CONNECTORS.
- 9.4. NUMBER ALL WIRES USING AN ELECTRICAL BOOK OF NUMBERS ACCORDING TO THE PLANS. NUMBER WIRES IN ALL VALVE BOXES, JUNCTION BOXES AND AT THE CONTROLLER.
- 9.5. WIRE SIZED, NUMBERED AND COLORED AS FOLLOWS:
 - #14 WHITE FOR COMMON
 - #14 SPARE BLACK COMMON
 - #14 RED FOR HOT WIRES
 #14 SPARE YELLOW HOT WIRE

10. CONTROLLER GROUNDING

10.1. CONTRACTOR TO UTILIZE 4"X8'X5/8" COPPER GROUNDING PLATES, 5/8"X10" COPPER CLAD GROUNDING RODS, 'ONE STRIKE' CAD WELLS AT ALL CONNECTION POINTS, #6 BARE COPPER WIRE, AND EARTH CONTACT MATERIAL. INSTALL THESE AND OTHER REQUIRED COMPONENTS AS OUTLINED IN THE DETAIL. CONTRACTOR TO VERIFY THAT THE EARTH TO GROUND RESISTANCE DOES NOT EXCEED 10 OHMS. CONTRACTOR SHALL PROVIDE A WRITTEN CERTIFICATION ON A LICENSED ELECTRICAL CONTRACTORS LETTER HEAD SHOWING THE DATE OF THE TEST, CONTROLLER LOCATION, AND TEST RESULTS. EACH CONTROLLER SHALL BE SO GROUNDED AND TESTED.

11. <u>VALVES</u>

- 11.1. SEQUENCE ALL VALVES SO THAT THE FARTHEST VALVE FROM THE P.O.C. OPERATES FIRST AND THE CLOSEST TO THE P.O.C. OPERATES LAST. THE CLOSEST VALVE TO THE P.O.C. SHOULD BE THE LAST VALVE IN THE PROGRAMMED SEQUENCE.
- 11.2. ADJUST THE FLOW CONTROL ON EACH RCV TO ENSURE SHUT OFF IN 10 SECONDS AFTER DEACTIVATION BY THE IRRIGATION CONTROLLER.
- 11.3. USING 3" HIGH NUMBER STENCILS, PAINT THE VALVE NUMBER IN WHITE ON THE LID OF EACH VALVE
- 11.4. WHERE NECESSARY, EXPOSED VALVES SHALL BE HUNG AND SECURED UTILIZING PIPE HANGERS AND SUPPORTS.

12. <u>EQUIPMENT</u>

- 12.1. BUBBLERS SHALL BE INSTALLED USING SCH 80 NIPPLES AND SHALL BE PLACED AT THE BASE OF TREES FOR LOW LEVEL WATERING.
- 12.2. ALL POP-UP HEADS AND SHRUB RISERS SHALL BE PRESSURE COMPENSATING. ALL POP-UP HEADS SHALL BE MOUNTED ON FLEX-TYPE SWING JOINTS.
- 12.3. ALL SPRINKLER EQUIPMENT NOT OTHERWISE DETAILED OR SPECIFIED SHALL BE INSTALLED AS PER MANUFACTURER'S RECOMMENDATIONS AND SPECIFICATIONS, AND IN ACCORDANCE WITH LOCAL AND STATE LAWS.

13. TRENCHING

- 13.1. EXCAVATE STRAIGHT AND VERTICAL TRENCHES WITH SMOOTH, FLAT OR SLOPING BOTTOMS. TRENCH WIDTH AND DEPTH SHOULD BE SUFFICIENT TO ALLOW FOR THE PROPER VERTICAL AND HORIZONTAL SEPARATION BETWEEN PIPING AS SHOWN IN THE PIPE INSTALLATION DETAIL ON THE DETAIL SHEET.
- 13.2. PROTECT EXISTING LANDSCAPED AREAS. REMOVE AND REPLANT ANY DAMAGED PLANT MATERIAL UPON JOB COMPLETION. THE REPLACEMENT MATERIAL SHALL BE THE SAME GENUS, SPECIES, AND SIZE OF THE MATERIAL IT IS REPLACING. THE FINAL DETERMINATION AS TO WHAT NEEDS TO BE REPLACED AND THE ACCEPTABILITY OF THE REPLACEMENT MATERIAL SHALL BE SOLELY DETERMINED BY THE OWNER OR OWNER'S REPRESENTATIVE.

14. INSTALLATION

- 14.1. CUT ALL PIPE SQUARE AND DEBURR. CLEAN PIPE AND FITTINGS OF FOREIGN MATERIAL, THEN APPLY A SMALL AMOUNT OF PRIMER WHILE ENSURING THAT ANY EXCESS IS WIPED OFF IMMEDIATELY.

 PRIMER SHOULD NOT PUDDLE OR DRIP FROM PIPE OR FITTINGS. NEXT APPLY A THIN COAT OF PVC

 CEMENT. FIRST APPLY A THIN LAYER TO THE PIPE, THEN A THIN LAYER INSIDE THE FITTING, AND FINALLY ANOTHER VERY THIN LAYER ON THE PIPE. INSERT THE PIPE INTO THE FITTING. INSURE THAT THE PIPE IS INSERTED TO THE BOTTOM OF THE FITTING, THEN TURN THE PIPE A 1/4 TURN AND HOLD FOR 10 SECONDS. MAKE SURE THAT THE PIPE DOESN'T RECEDE FROM THE FITTING. IF THE PIPE ISN'T AT THE BOTTOM OF THE FITTING UPON COMPLETION, THE GLUE JOINT IS UNACCEPTABLE AND MUST BE DISCARDED.
- 14.2. PIPES MUST CURE A MINIMUM OF 30 MINUTES PRIOR TO HANDLING AND PLACING INTO TRENCHES. A LONGER CURING TIME MAY BE REQUIRED; REFER TO THE MANUFACTURER'S SPECIFICATIONS. THE PIPE MUST CURE A MINIMUM OF 24 HOURS PRIOR TO FILLING WITH WATER.

15. BACKFILLING

- 15.1. THE BACKFILL 6" BELOW AND 6" ABOVE ALL PIPING SHALL BE CLEAN SAND. ALL OTHER TRCNCH BACKFILL CAN BE NATIVE MATERIAL BUT SHALL NOT CONTAIN ANYTHING LARGER THAN 2" IN DIAMETER.
- 15.2. CONTRACTOR SHALL BACKFILL ALL PIPING, BOTH MAINLINE AND LATERALS, PRIOR TO PERFORMING ANY PRESSURE TESTS. THE PIPE SHALL BE BACKFILLED WITH THE EXCEPTION OF 2' ON EACH SIDE OF EVERY JOINT (BELL FITTINGS, 90'S, TEES, 45'S, ETC.). THESE JOINTS SHALL NOT BE BACKFILLED UNTIL ALL PIPING HAS SATISFACTORILY PASSED ITS APPROPRIATE PRESSURE TEST AS OUTLINED BELOW.

16. <u>TESTING & FLUSHING</u>

16.1. LEAKAGE TESTING

- 16.1.1. REMOVE ALL REMOTE CONTROL VALVES AND CAP USING A THREADED CAP. FILL MAINLINE WITH WATER AND PRESSURIZE THE SYSTEM TO 125 PSI. MONITOR THE SYSTEM PRESSURE AT TWO GAUGE LOCATIONS; THE GAUGE LOCATIONS MUST BE AT OPPOSITE ENDS OF THE MAINLINE. WITH THE SAME RESPECTIVE PRESSURES, MONITOR THE GAUGES FOR TWO HOURS.
- 16.1.2. PVC SOLVENT-WELD PIPE CONNECTIONS SHALL HAVE NO LEAKAGE. GASKETED PIPING SHALL LOSE NO MORE WATER THAN ALLOWED PER THE FLORIDA STATE BUILDING CODE, VOLUME II PLUMBING, PART VI, APPENDIX 'F'. REFER TO THIS SECTION FOR THE FORMULA TO BE USED TO CALCULATE THE MAXIMUM ALLOWABLE WATER LOSS DURING THE TESTING TIME.
- 16.1.3. REPAIR ALL LEAKS AND RETEST MAINLINE PIPING UNTIL THE TEST IS SUCCESSFUL.

16.1.4. LATERAL PIPE MUST BE FILLED AND VISUALLY CHECKED FOR LEAKS. ANY LEAKS DETECTED MUST BE REPAIRED. NO PRESSURE TEST OF THE LATERAL LINES IS REQUIRED.

16.2. FLUSHING:

- 16.2.1. PRIOR TO THE PLACEMENT OF HEADS, FLUSH ALL LINES FOR A MINIMUM OF 10 MINUTES OR UNTIL LINES ARE COMPLETELY CLEAN OF DEBRIS, WHICHEVER IS LONGER.
- 16.2.2. USE SCREENS IN HEADS AND ADJUST HEADS FOR PROPER COVERAGE AVOIDING EXCESS WATER ON WALLS, WALKS AND PAVING.

16.3. OPERATIONAL TESTING:

- 16.3.1. UPON COMPLETION OF BACKFILLING, FINISH GRADING AND CONTOURING, TEST THE ENTIRE SYSTEM FOR PROPER OPERATION, INCLUDING ELECTRICALLY ACTUATING THE REMOTE CONTROL VALVES. RUN EACH ZONE UNTIL WATER BEGINS TO PUDDLE OR RUN OFF. THIS WILL ALLOW DETERMINATION OF THE NUMBER OF IRRIGATION START TIMES NECESSARY TO MEET THE WEEKLY EVAPOTRANSPIRATION REQUIREMENTS OF THE PLANTING MATERIAL IN EACH ZONE. IN SANDY SOILS NO PUDDLING WILL OCCUR. IN THESE CASES, CALCULATE THE REQUIRED RUN TIMES.
- 16.3.2. ONCE THE MAINLINE AND LATERAL LINES HAVE PASSED THEIR RESPECTIVE TESTS AND THE SYSTEM IS COMPLETELY OPERATIONAL, A COVERAGE TEST AND DEMONSTRATION OF THE SYSTEM IS REQUIRED. THE IRRIGATION CONTRACTOR MUST DEMONSTRATE TO THE OWNER OR HIS/HER REPRESENTATIVE THAT PROPER COVERAGE IS OBTAINED AND THAT THE SYSTEM WORKS AUTOMATICALLY FROM THE CONTROLLER. THIS DEMONSTRATION REQUIRES THAT EACH ZONE BE TURNED ON IN THE PROPER SEQUENCE AS SHOWN ON THE PLANS FROM THE CONTROLLER. EACH ZONE WILL BE INSPECTED FOR PROPER COVERAGE AND FUNCTION. THE DETERMINATION OF PROPER COVERAGE AND FUNCTION WILL BE SOLELY DETERMINED BY THE OWNER OR OWNER'S REPRESENTATIVE.

cma

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REGISTRATION

CRISTOBAL A. BETANCOURT, RLA
REGISTRATION NO. **6666941**DATE: 5/6/2021



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CLIENT

OAKLAND PARK DIXIE, LLC

PROJECT INFORMATION

SKY BUILDING

PROJECT NUMBER

20-487.001

CLIENT PROJECT NUMBER

REVISIONS

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⚠ DRC COMMENTS

DATE OF ISSUE 03.18.2021

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JC CHECKED BY

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GROUND LEVEL IRRIGATION SPECIFICATIONS

L6.0

as pipe size. NE 39TH STREET mount bracket. Wired. Point of Connection 1" — — Irrigation Mainline: PVC Class 200 SDR 21 Pipe Sleeve: PVC Schedule 40 Valve Callout ---- Valve Number # • Valve Flow — Valve Size WITH SOLAR SYNC RAIN SENSOR (R2). AMENITY DECK POINT OF CONNECTION: BUILDING PLUMBING CONTRACTOR TO INSTALL 1" RPZ BACKFLOW PREVENTER IN THE MEP / FIRE RISER ROOM ON THE 2ND FLOOR OF THE BUILDING. BUILDING PLUMBING CONTRACTOR TO RUN A 1" WATER SUPPLY LINE FROM THE BACKFLOW PREVENTER TO THE AMENITY DECK AND STUBBED-UP INTO THE LANDSCAPE PLANTER FOR CONNECTION BY THE IRRIGATION CONTRACTOR. MINIMUM FLOW OF 20 GPM AT 60 PSI REQUIRED. PROPOSED 1.5" IRRIGATION MAINLINE - IRRIGATION SLEEVES ON AMENITY DECK TO BE INSTALLED WITHIN THE INTERSTITIAL SPACE BELOW THE AMENITY DECK. SHOULD THERE NOT BE AN INTERSTITIAL SPACE BELOW THE AMENITY DECK, THESE SLEEVES WILL NEED TO BE INSTALLED BY THE BUILDING PLUMBING CONTRACTOR AND STUBBED-UP INTO EACH PLANTER FOR CONNECTION BY THE NE 38TH STREET

AMENITY DECK IRRIGATION SCHEDULE

MANUFACTURER/MODEL/DESCRIPTION Leemco LMV-11BB Gate Valve 2" x 2" LMV-BB Series Mainline Gate Valve. Valve size same Hunter IC-0600-SS Controller

Modular Controller, 6 stations, Outdoor Model, Stainless Steel Cabinet. No Module Required. Commercial Use.

Hunter Solar-Sync Rain/Freeze Sensor Solar, rain/freeze sensor with outdoor interface. Includes 10 year lithium battery and rubber module cover, and gutter

Point of Connection to Water Supply Line Stubbed-Up in the Landscape by the Building Plumbing Contractor

62.1 l.f. Typical pipe sleeve for irrigation pipe. Pipe sleeve size shall allow for irrigation piping and their related couplings to easily slide through sleeving material. Extend sleeves 18-inches beyond edges of paving or construction.

NOTE:

11.0 l.f.

1 INCH = 20 FEET

ALL LANDSCAPED AREAS WILL BE IRRIGATED WITH AN UNDERGROUND IRRIGATION SYSTEM, DESIGNED TO PROVIDE A MINIMUM COVERAGE AREA OF 100% WITH A 50% OVERLAP. FULL IRRIGATION PLANS WILL BE PROVIDED WITH CONSTRUCTION DOCUMENTS/ BUILDING PERMIT PLANS.



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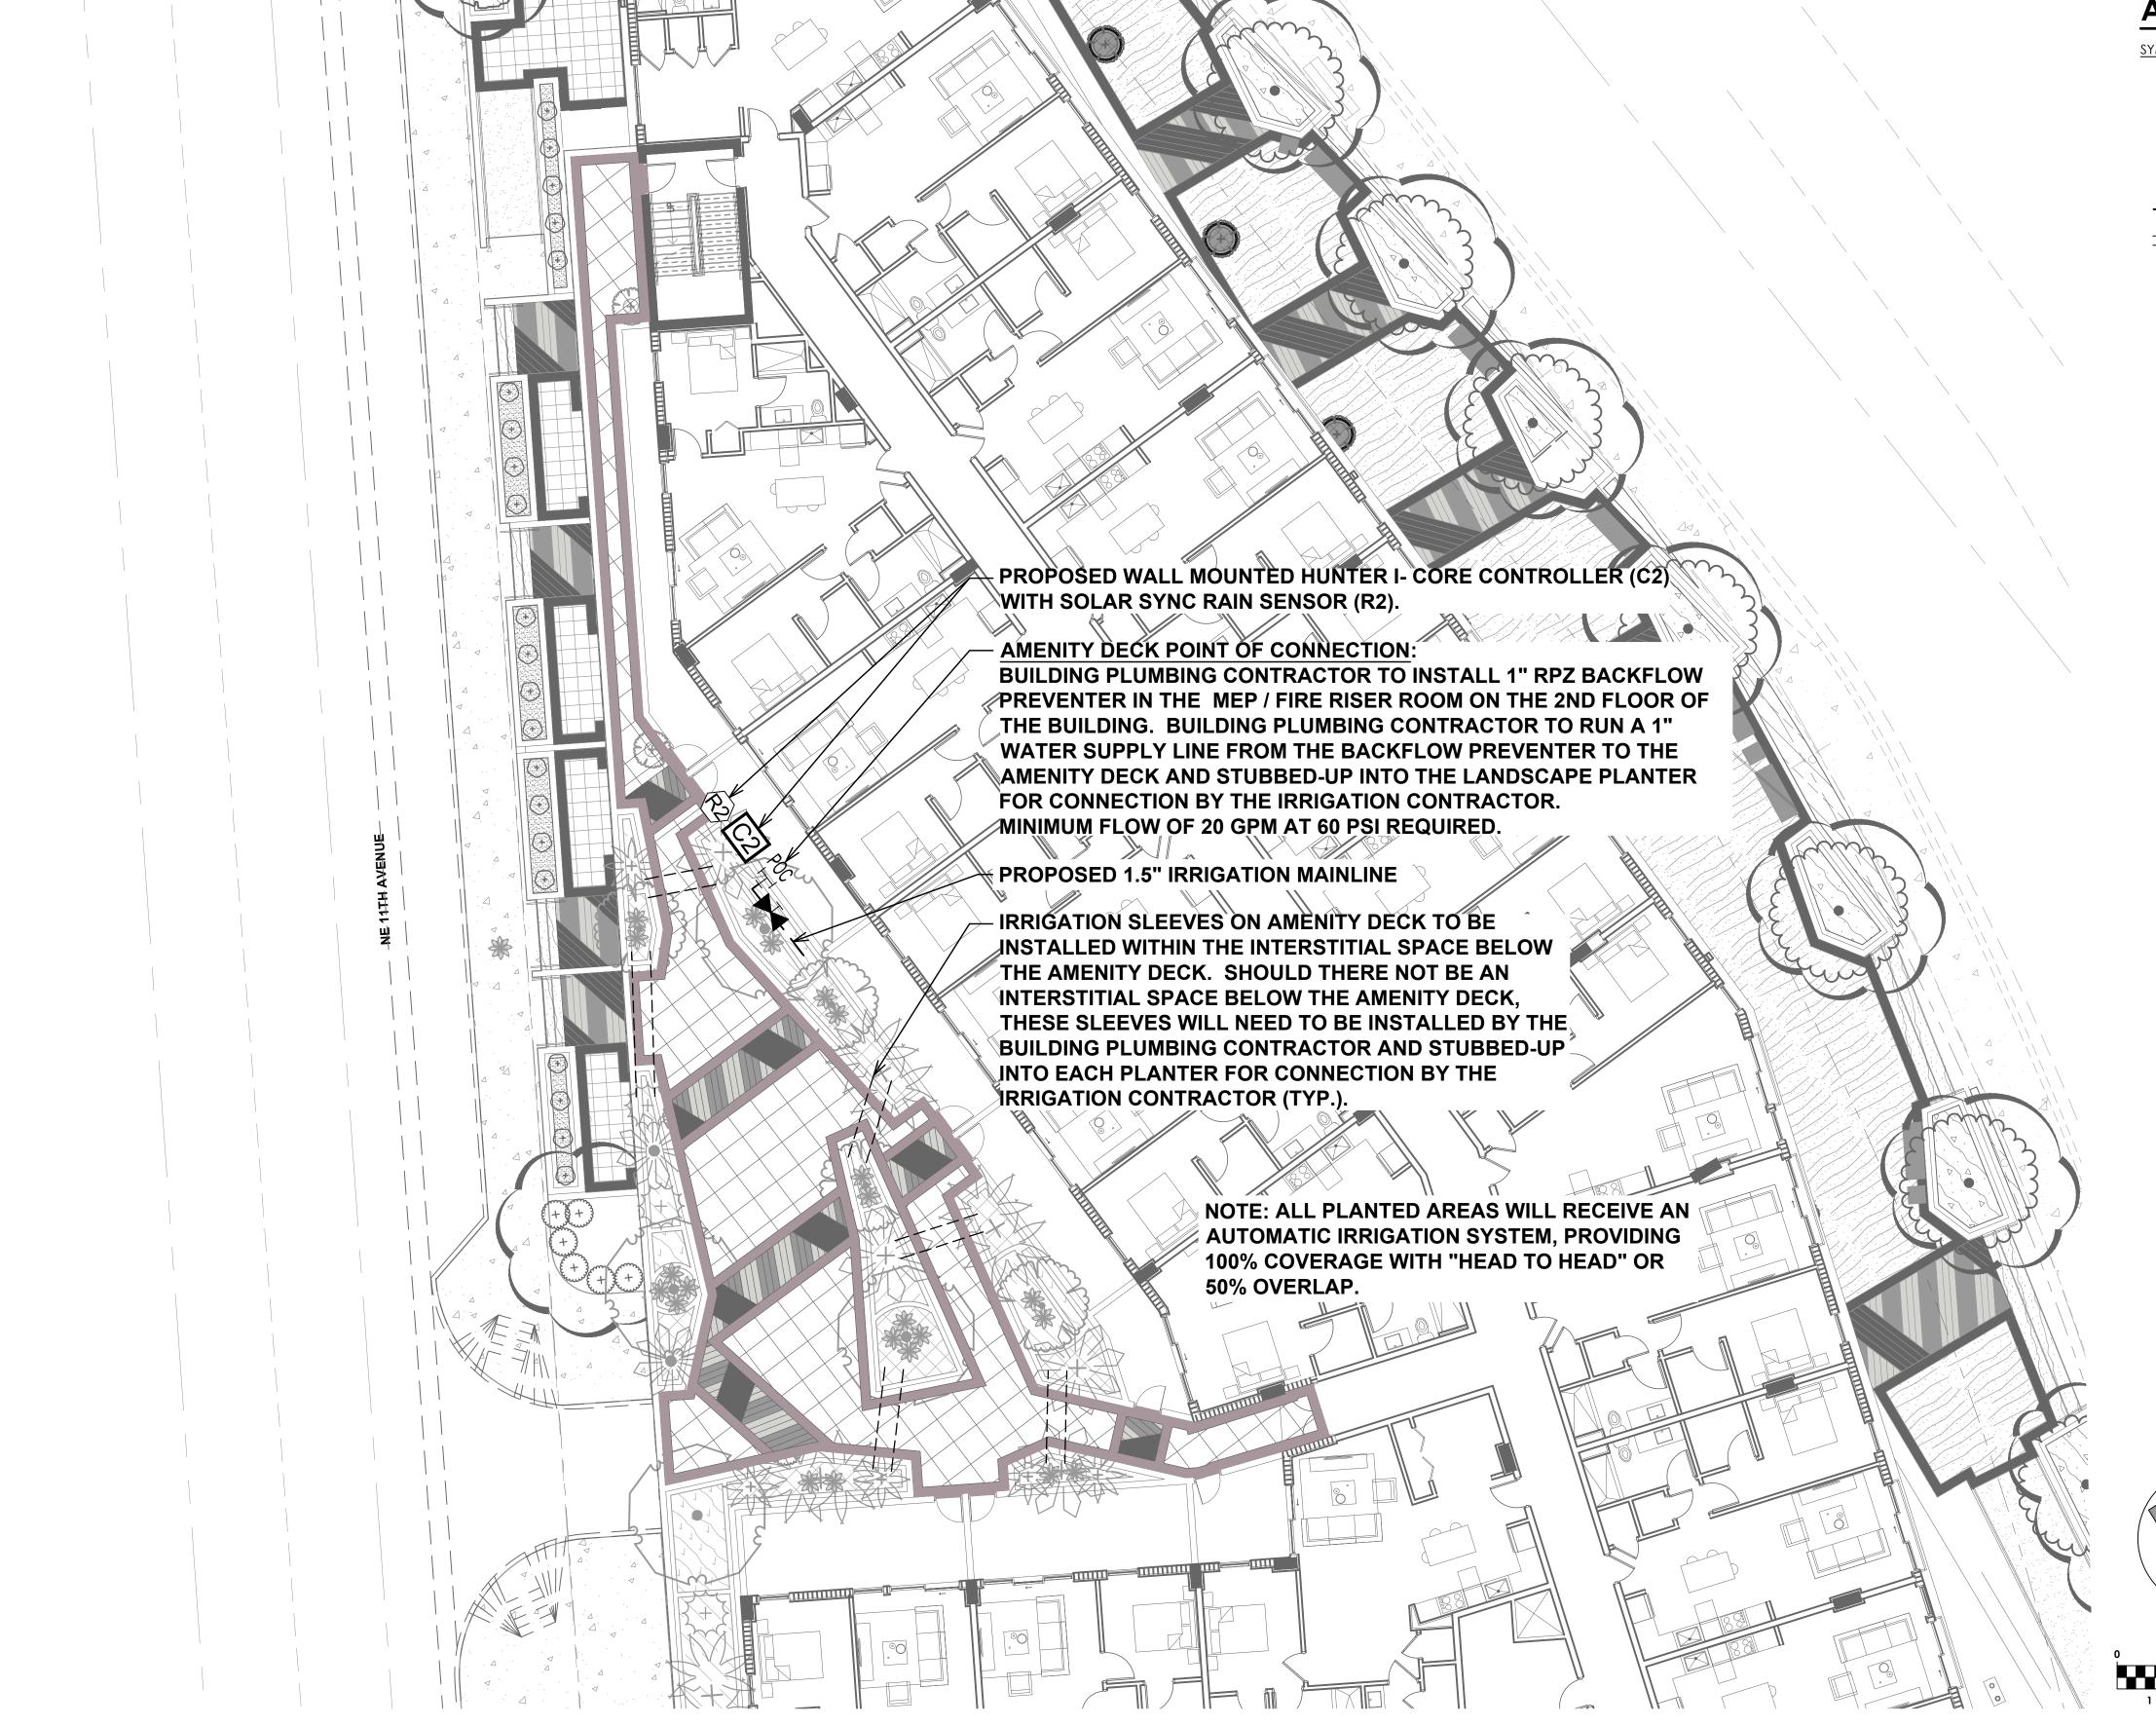
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AMENITY DECK IRRIGATION PLAN



AMENITY DECK IRRIGATION LEGEND

SYMBOL MANUFACTURER/MODEL

Leemco LMV-11BB Gate Valve

Hunter IC-0600-SS Controller

Hunter Solar-Sync Rain/Freeze Sensor

Point of Connection 1"

_____ Irrigation Mainline: PVC Class 200 SDR 21

_____ Pipe Sleeve: PVC Schedule 40

Valve Callout
Valve Number
Valve Flow
Valve Size

NOTE:

ALL LANDSCAPED AREAS WILL BE IRRIGATED WITH AN UNDERGROUND IRRIGATION SYSTEM, DESIGNED TO PROVIDE A MINIMUM COVERAGE AREA OF 100% WITH A 50% OVERLAP. FULL IRRIGATION PLANS WILL BE PROVIDED WITH CONSTRUCTION DOCUMENTS/BUILDING PERMIT PLANS.

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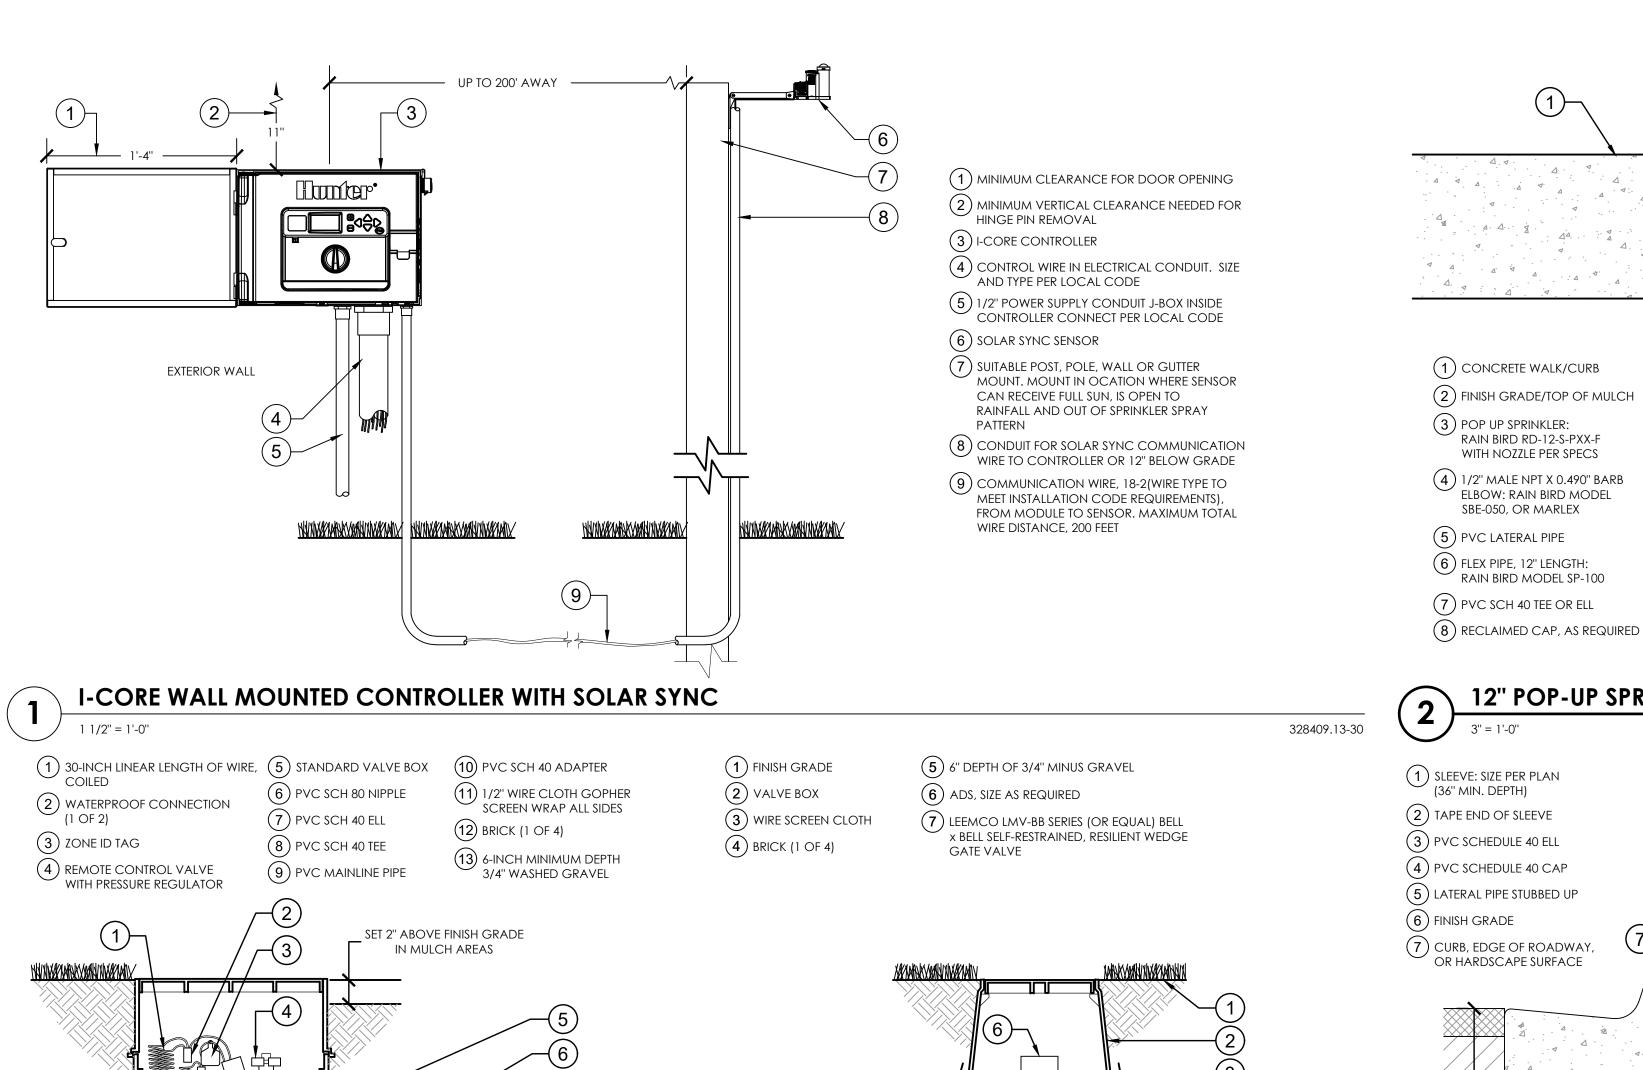
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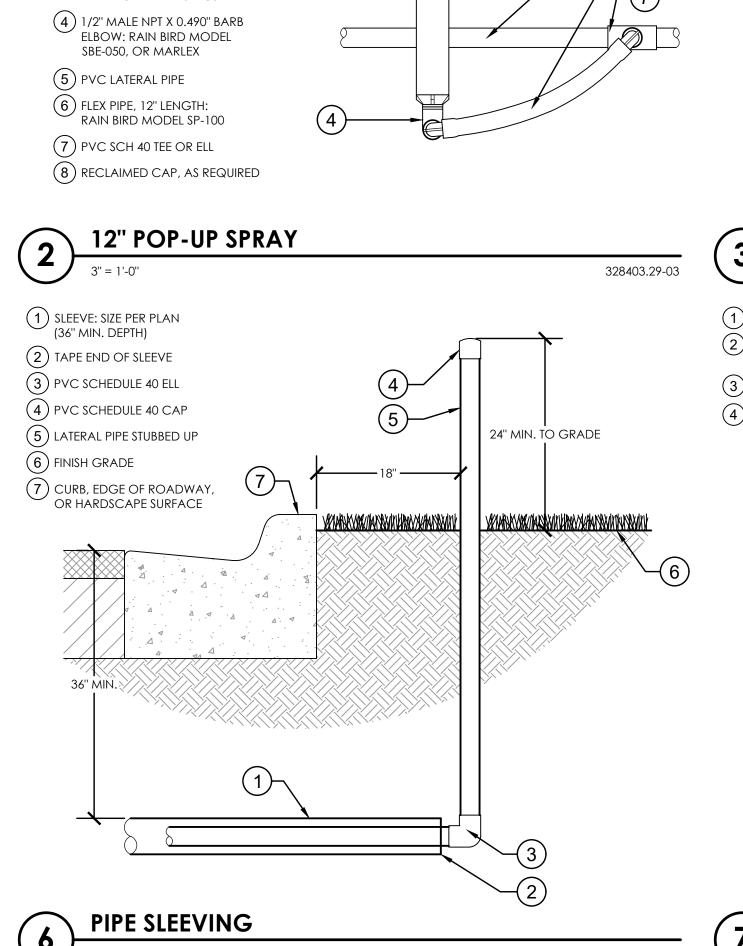
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AMENITY DECK IRRIGATION PLAN

L7.0





NOTE: DO NOT USE SIDE INLET

WITH CHECK VALVE OPTIONS

1) TREE OR PALM 7 FLEX PIPE (8) PVC TEE OR ELL (2) ROOT BALL WITH MARLEX FITTING (3) BUBBLER AS SPECIFIED 9 PVC LATERAL PIPE (4) GALVANIZED TIE DOWN STAKE (LENGTH AS REQUIRED) (5) MULCH (10) PLANTING SOIL 6 WATER WELL (11) NATIVE SOIL PER PLANTING DETAILS TREE BUBBLER

(1) FINISH GRADE (5) 100% COARSE SAND BEDDING, WATER JET & MECHANICALLY (2) NATIVE SOIL BACKFILL COMPACT TO 90% OPTIMUM COMPACT TO 95% DENSITY. ALLOW 48 HOURS TO SETTLE, AND BACKFILL AND (3) IRRIGATION MAIN (AS SPECIFIED)

(4) ZONE CONTROL WIRE IN SCH 40 CONDUIT (SIZE AS REQUIRED)

12" MAX. CLEARANCE 🚽 MINIMUM DEPTH PER IRRIGATION SPECIFICATION

COMPACT WITH NATIVE SOIL.

MAINLINE AND LATERAL TRENCH

328409.76-34

328403.53-06

GENERAL NOTES

328409.76-32

- 1. ALL PLANTED AREAS WILL RECEIVE AN AUTOMATIC IRRIGATION SYSTEM, PROVIDING 100% COVERAGE WITH "HEAD TO HEAD" OR 50% OVERLAP, WITH THE OPTION TO SWITCH TO MANUAL OPERATION IN EMERGENCY SITUATIONS.
- 2. THE IRRIGATION SYSTEM WILL BE CAPABLE OF DISTRIBUTING 1-1/2" OF WATER PER WEEK DURING A MAXIMUM EIGHT (8) HOUR WATERING CYCLE.
- 3. THE IRRIGATION SYSTEM IS DESIGNED TO AVOID OVER SPRAY INTO PUBLIC AND PEDESTRIAN AREAS.
- 4. CONTRACTOR TO VERIFY LOCATION OF ALL EXISTING UTILITIES.
- 5. IT SHALL BE THE CONTRACTOR'S SOLE RESPONSIBILITY TO TAKE THE NECESSARY PRECAUTIONS TO ENSURE PROPER SAFETY AND WORKMANSHIP WHEN WORKING IN THE VICINITY OF EXISTING UTILITY LINES.
- 6. CONTRACTOR SHALL BE RESPONSIBLE TO COORDINATE WITH FPL ON ANY WORK IN THE VICINITY OF OVERHEAD OR UNDERGROUND POWER LINES.
- 7. CONTRACTOR SHALL VERIFY PROPER CLEARANCE BELOW EXISTING OVERHEAD POWER LINES PRIOR TO WORKING WITHIN THE VICINITY THE POWER LINES.
- 8. MAINLINE LOCATION, WHERE SHOWN, IS FOR GRAPHIC CLARITY PURPOSES ONLY. INSTALL AT THE BACK OF CURB, FRONT OF WALK, BACK OF WALK, OR ADJACENT TO OTHER HARDSCAPES TO FACILITATE FUTURE LOCATION AND TO PROTECT FROM DAMAGE. ENSURE MAINLINE IS INSTALLED ACCORDING TO THE IRRIGATION SPECIFICATIONS AND DETAILS.
- 9. IF IT IS NECESSARY TO HAVE PIPING UNDER HARDSCAPE ITEMS, SUCH AS ROADS, WALKS AND PATIOS, THE PIPES MUST BE SLEEVED WITH THE SLEEVE DIAMETER BEING AT LEAST TWICE THE SIZE OF THE PIPE IT IS
- 10. ANY MAJOR DESIGN CHANGES SHALL BE BROUGHT TO THE ATTENTION OF THE LANDSCAPE ARCHITECT OF RECORD PRIOR TO CONSTRUCTION; CONTRACTOR PROCEEDS WITH CHANGES AT OWN RISK.
- 11. NO SUBSTITUTIONS SHALL BE PERMITTED, EXCEPT WITH WRITTEN APPROVAL FROM THE LANDSCAPE ARCHITECT OF RECORD.

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PROJECT NUMBER 20-487.001

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DATE OF ISSUE


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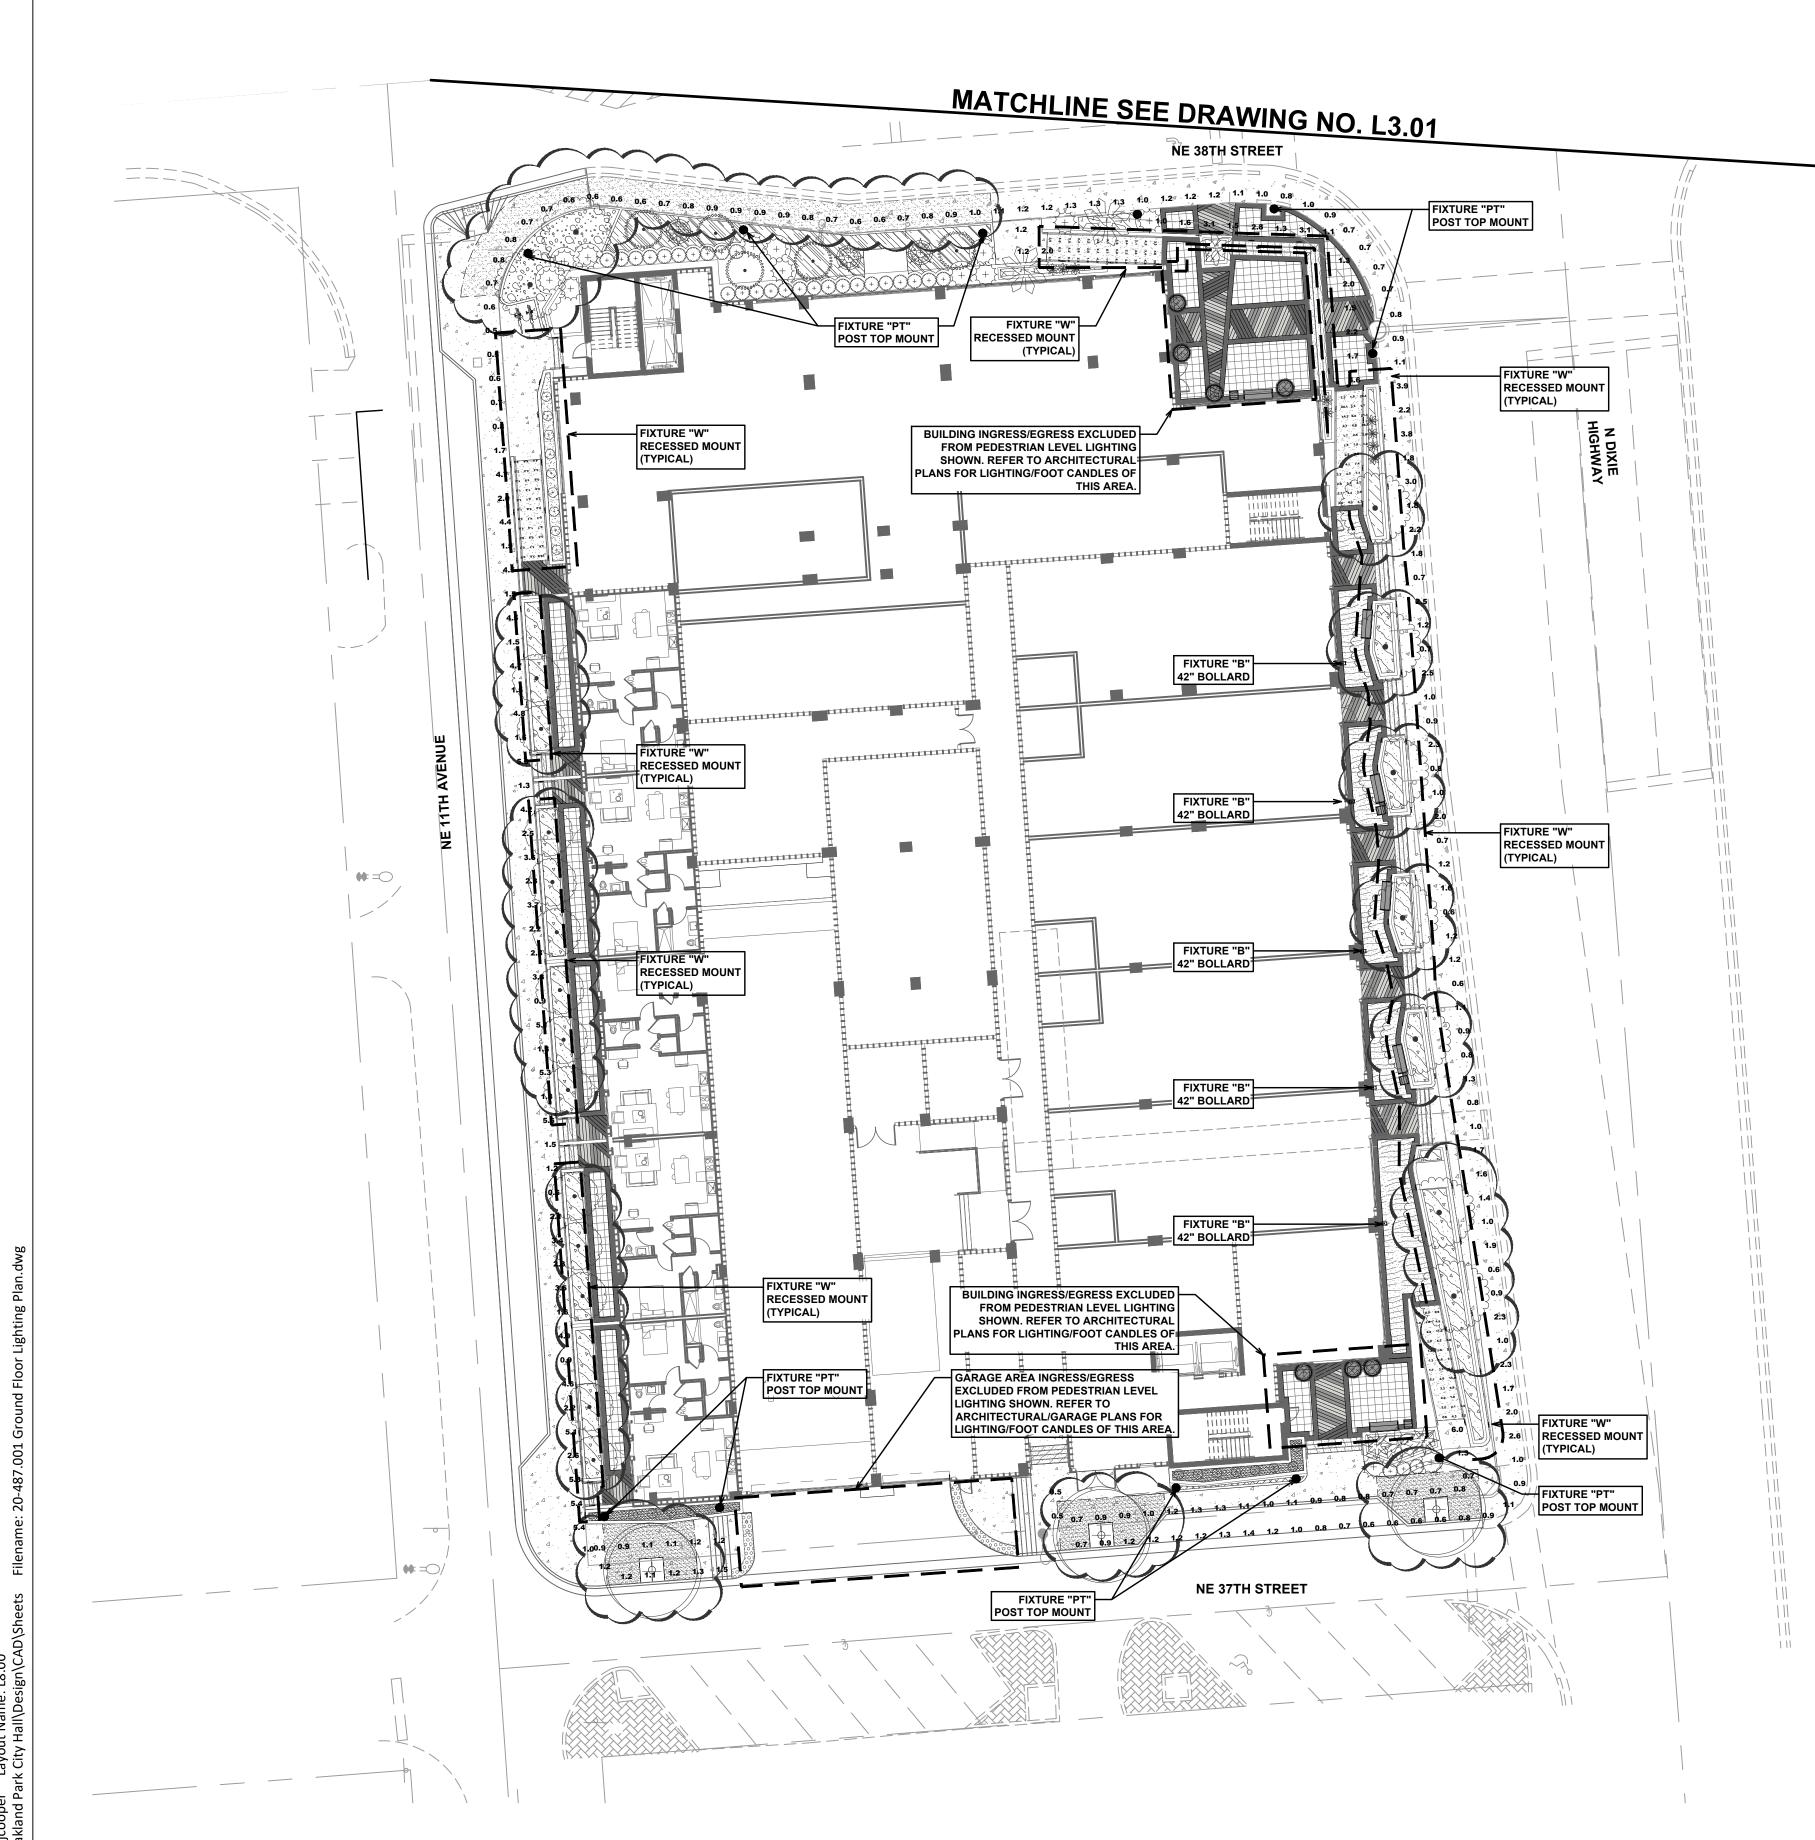
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AMENITY DECK IRRIGATION NOTES AND DETAILS





LUMINAIRE SCHEDULE AND CALCULATION SUMMARY

| Project: OAKLAND PARK CITY HALL | | | | | | | | | |
|---------------------------------|---|----|--------|--------------------------------|---|------|--------------------|-------------------|---------|
| Symbol | Qty. Label Arrangement Manufacturer Description | | | Description | Luminaire Lumens | LLF | Luminaire Watts | Assembly Watts | |
| | 21 | PT | SINGLE | LITHONIA LIGHTING | RADPT P1 40K PATH MH: POST TOP MOUNT A.F.G. (bottom of fixture) | 2592 | 0.855 | 25.4134 | 25.4134 |
| -> | 12 | В | SINGLE | U.S. Architectural Lighting | RZRB1-PLED-II-20LED-175mA-NW MH: 42" BOLLARD | 1794 | 0.855 | 11 | 11 |
| → | 188 | w | SINGLE | Bega US | 33 154 MH: RECESSED MOUNT A.F.F. (bottom of fixture) | 514 | 0.855 | 8 | 8 |
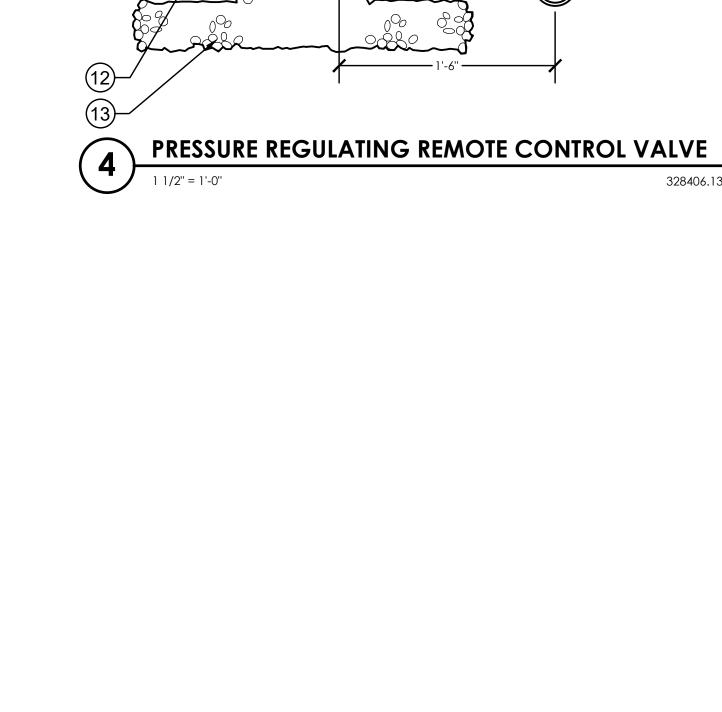
| Project: OAKLAND PARK CITY HALL | | | | | | | | | |
|---------------------------------|-------------|-------|------|------|-----|---------|---------|--|--|
| Label | CalcType | Units | Avg | Max | Min | Avg/Min | Max/Mir | | |
| PERIMETER BUILDING (bottom) | Illuminance | Fc | 6.97 | 26.2 | 0.9 | 7.74 | 29.11 | | |
| PERIMETER BUILDING (top) | Illuminance | Fc | 4.00 | 16.9 | 0.5 | 8.00 | 33.80 | | |
| SIDEWALKS (bottom) | Illuminance | Fc | 1.62 | 6.0 | 0.5 | 3.24 | 12.00 | | |
| SIDEWALKS (top) | Illuminance | Fc | 1.62 | 5.5 | 0.5 | 3.24 | 11.00 | | |

GM3

chen moore and associates

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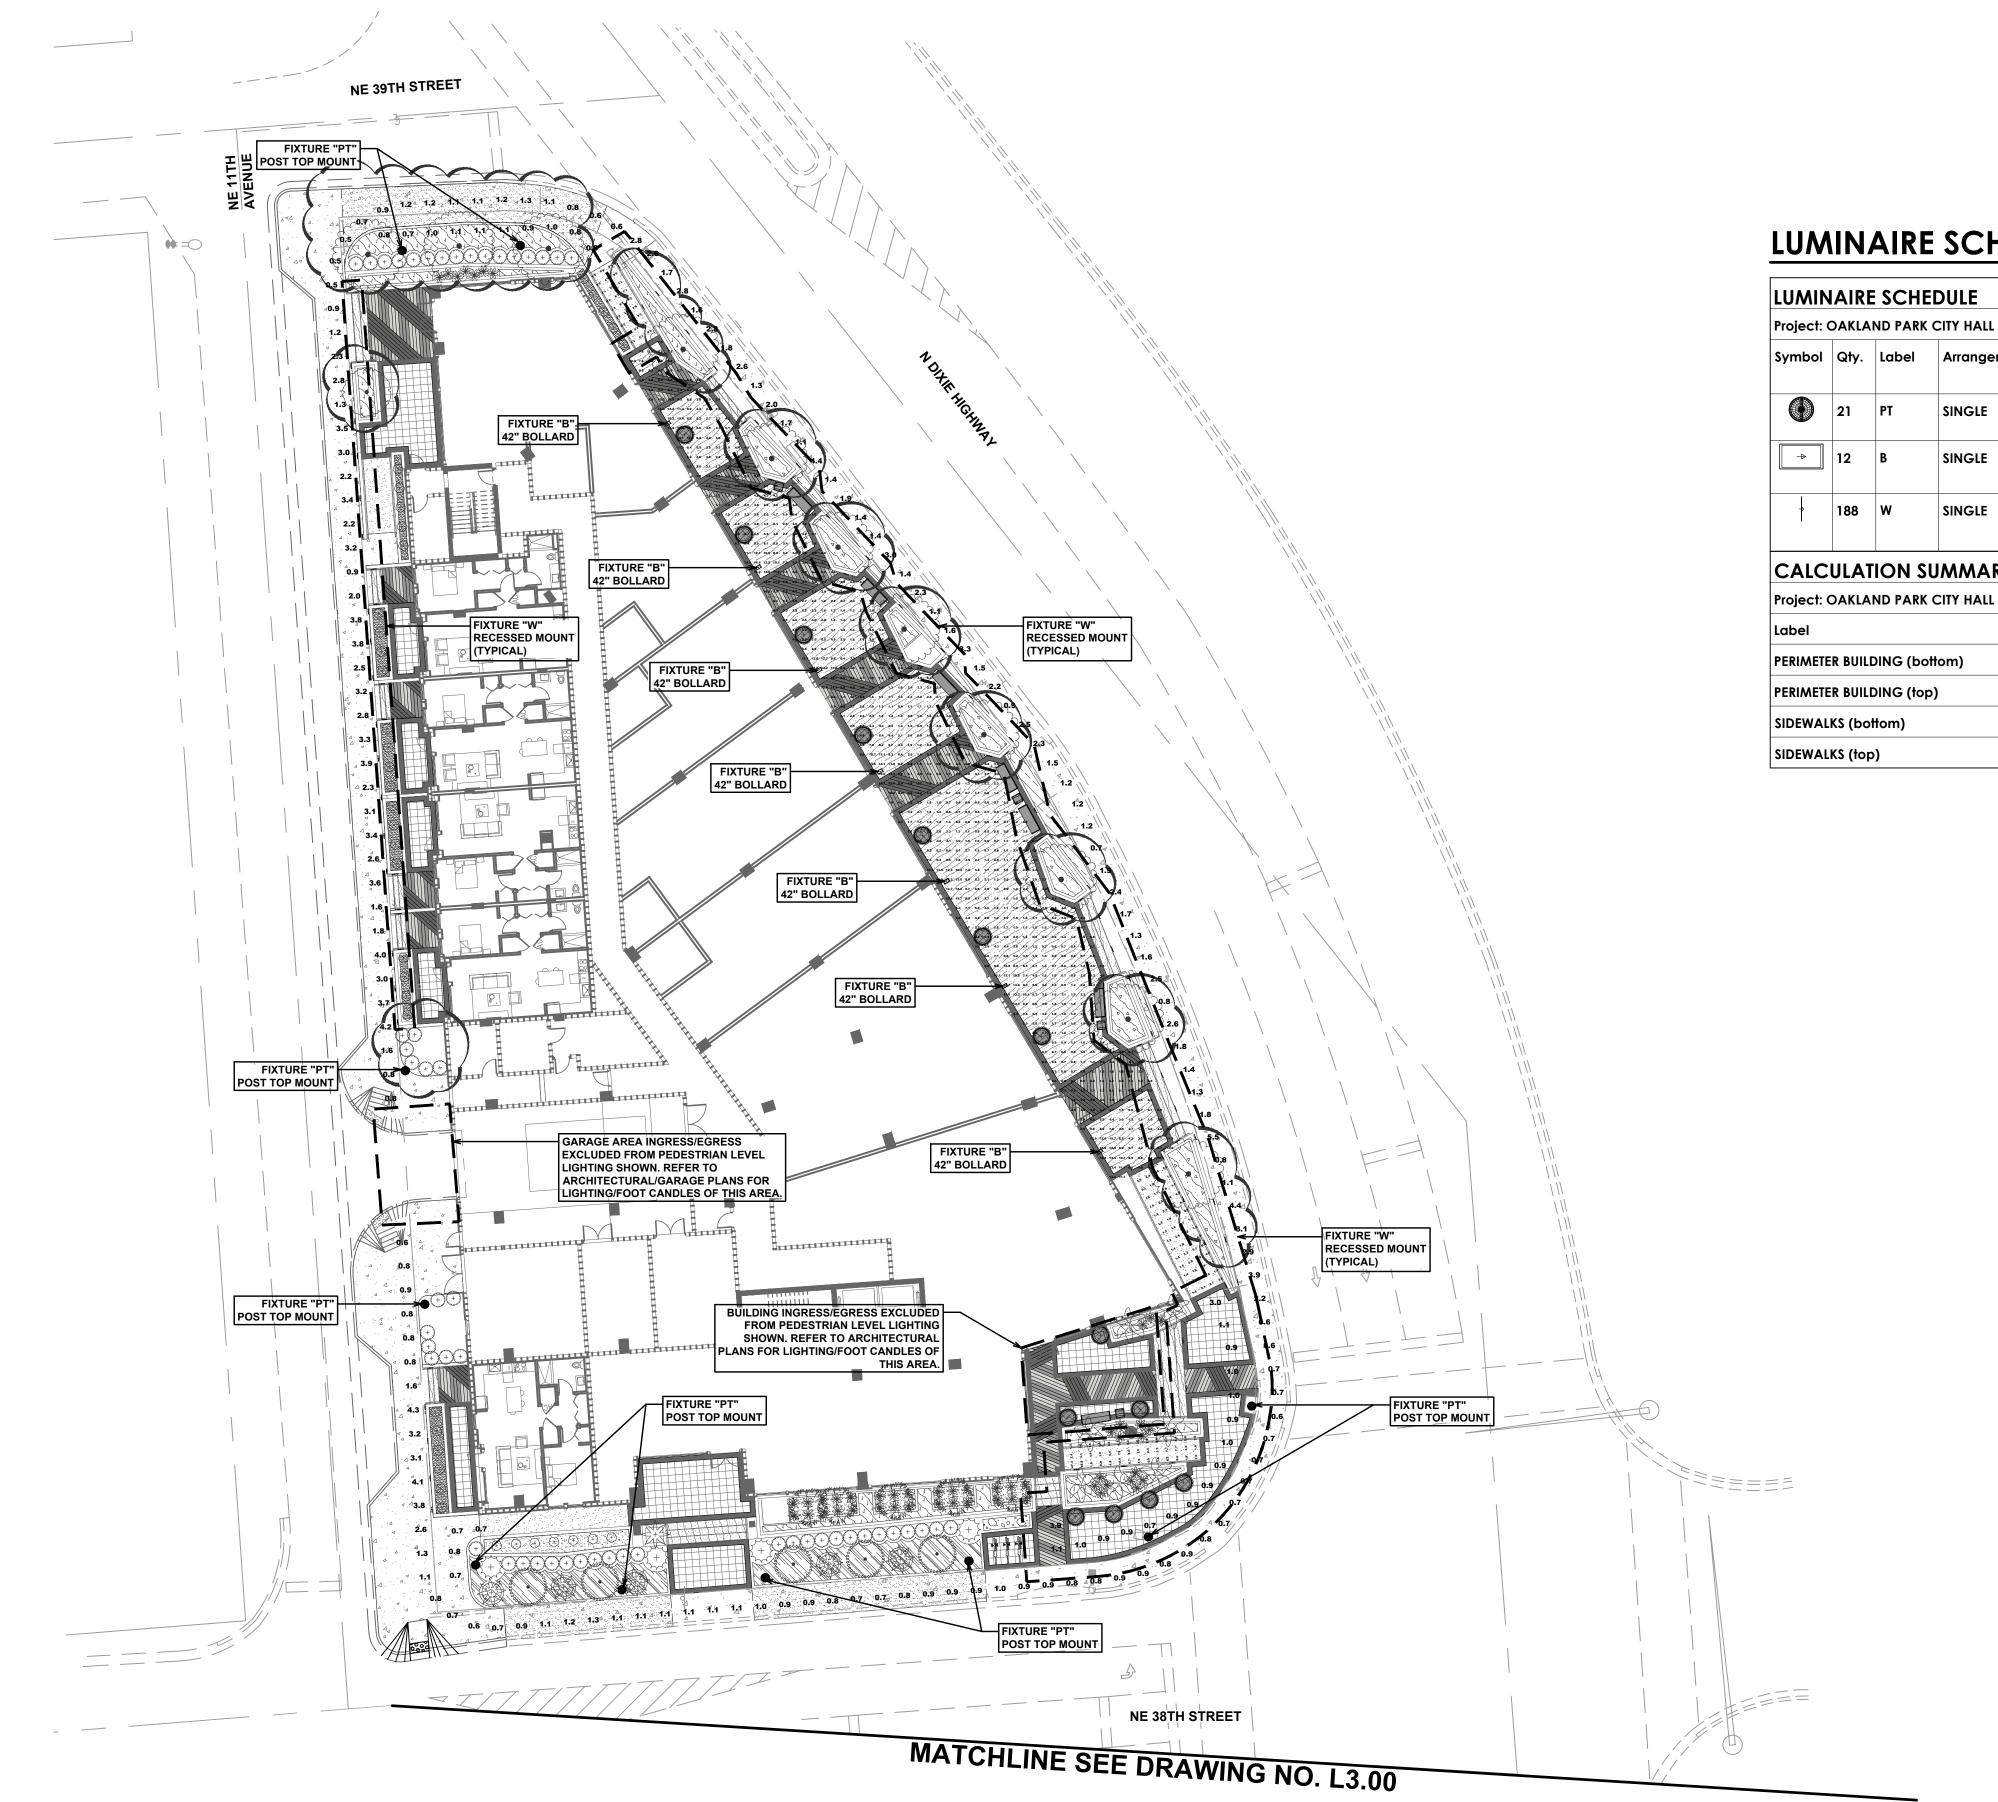
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GROUND FLOOR LIGHTING PLAN

L8.00

1 INCH = 20 FEET



LUMINAIRE SCHEDULE AND CALCULATION SUMMARY

| Project: OAKLAND PARK CITY HALL | | | | | | | | | |
|---------------------------------|------|-------|-------------|--------------------------------|---|---------------------|-------|--------------------|-------------------|
| Symbol | Qty. | Label | Arrangement | Manufacturer | Description | Luminaire Lumens | LLF | Luminaire Watts | Assembly Watts |
| | 21 | PT | SINGLE | LITHONIA LIGHTING | RADPT P1 40K PATH MH: POST TOP MOUNT A.F.G. (bottom of fixture) | 2592 | 0.855 | 25.4134 | 25.4134 |
| -> | 12 | В | SINGLE | U.S. Architectural Lighting | RZRB1-PLED-II-20LED-175mA-NW MH: 42" BOLLARD | 1794 | 0.855 | 11 | 11 |
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| Project: OAKLAND PARK CITY HALL | | | | | | | | | |
|---------------------------------|-------------|----|------|------|-----|------|-------|--|--|
| | | | | | | | | | |
| PERIMETER BUILDING (bottom) | Illuminance | Fc | 6.97 | 26.2 | 0.9 | 7.74 | 29.11 | | |
| PERIMETER BUILDING (top) | Illuminance | Fc | 4.00 | 16.9 | 0.5 | 8.00 | 33.80 | | |
| SIDEWALKS (bottom) | Illuminance | Fc | 1.62 | 6.0 | 0.5 | 3.24 | 12.00 | | |
| SIDEWALKS (top) | Illuminance | Fc | 1.62 | 5.5 | 0.5 | 3.24 | 11.00 | | |

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GROUND FLOOR LIGHTING PLAN

DRAWING NUMBER

DRC SUBMITTAL. NOT FOR CONSTRUCTION.

1 INCH = 20 FEET

Radean Post Top LED Area Luminaire 🛜 👽 🕮 🕮 Introduction The architecturally-inspired shape of the RADEAN™ post top area luminaire embodies **Specifications** the grace and strength of the RADEAN family. The twin copper-core cast aluminum arms support the slender superstructure, creating a beautiful sculpture by day transforming into a beacon of comfort by night. Triangular arms redirect reflection maintaining its visually Luminaire (10.16cm) quiet appearance. With sleek lines and simple silhouettes, these LED luminaires use specialized lighting and visual comfort to transform common areas like courtyards, outdoor retail locations, universities and corporate campuses into pedestrian-friendly nighttime environments.

| | ring Informatio | 211 | | | E | KAIVIPL | E: RAD | PT LED P | 3 30K SYM MVOLT PT4 PIR DI |
|-------------------|---|-----------------|---|---|-------------------------|---|--------------------------------|--------------------------------------|---|
| RADPT | LED | | | | | | | | |
| | | | | | | Voltage | | | |
| RADPT LEI | P1 3,000 Lumens P2 5,000 Lumens P3 7,000 Lumens P4 10,000 Lumen P5 15,000 Lumen | s | 27K 2700K 30K 3000K 35K 3500K 40K 4000K 50K 5000K | SYM Symmetric type V ASY Asymmetric type IV PATH Pathway Type III | | MVOLT ¹ 120 ¹ 208 ¹ 240 ¹ | 277 ¹ 347 480 | RADPT20 | Slips inside a 4° 00 round metal pole Slips over a 2 3/8° diameter tenon Slips over a 2 7/8° diameter tenon |
| | | | | | | | | | |
| | | Other : | | | Finis | | | | |
| Shipped installed | | SF DF R90 | Single Fuse ¹ Double Fuse ¹ Rotated optics ⁹ | Shipped installed HS Houseside shield ¹⁰ | DDI DBI DN/ DW | XD Black | ral aluminum | DDBTXD DBLBXD DNATXD DWHGXD | Textured dark bronze Textured black Textured natural aluminum Textured white |

POST MOUNT LIGHT - FIXTURE "PT". REFER TO SCHEDULE

N.T.S.

LÉD recessed wall luminaire with unshielded light for use as location luminaires for means of way finding.

Materials

Luminaire housing constructed of die-cast aluminum marine grade, copper free (s 0.3% copper content) A360.0 aluminum alloy White safety glass

Silicone applied robotically to plasma treated casting for increased adhesion High temperature silicone gasket Mechanically captive stainless steel fasteners

Stainless steel screw clamps

Composite installation housing

NRTL listed to North American Standards, suitable for wet locations

Protection class IP65

Weight: 4.2 lbs

Electrical

Operating voltage 120-277V AC

Minimum start temperature -30° C

LED module wattage 5.9 W

System wattage 8.0 W

Controlability 0-10V

Color rendering index Ra>80

Lifetime at Ta=15°C >500,000 h (L70)

LED color temperature

2700K - Product number + K27

3000K - Product number + K3

3500K - Product number + K3

3500K - Product number + K3

5400K - Product number + K3

550K - Product number + K4

BEGA can supply you with suitable LED replacement modules for up to 20 years after the purchase of LED luminaires - see website for details

Finish


All BEGA standard finishes are matte, textured polyester powder coat with minimum 3 mil thickness.

Available colors Black (BLK) White (WHT) RAL:

Bronze (BRZ) Silver (SLV) CUS:

LED recessed wall luminaires - unshielded location luminaires

. A . . . C.

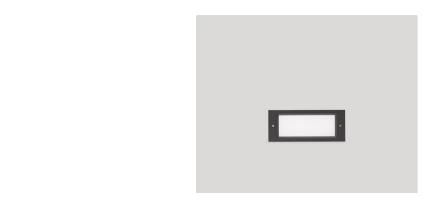

RECESSED LIGHT - FIXTURE "W". REFER TO SCHEDULE

NOTE:

BUILDING MASSES REPRESENTED ARE PROVIDED TO SHOW INTENT/ PROVIDE CONTEXT TO LIGHTING DESIGN. THE BUILDING FACADES ARE INTENDED TO LOOK AS SHOWN. REFER TO ARCHITECTURAL ELEVATIONS FOR DEPICTION OF BUILDING FACADES AND PROPOSED HEIGHTS.




NORTH BUILDING LIGHTING STUDY (LOOKING SOUTHWEST FROM DIXIE HIGHWAY)



NORTH BUILDING LIGHTING STUDY (LOOKING SOUTHEAST FROM NE 11TH AVENUE)

N.T.S.

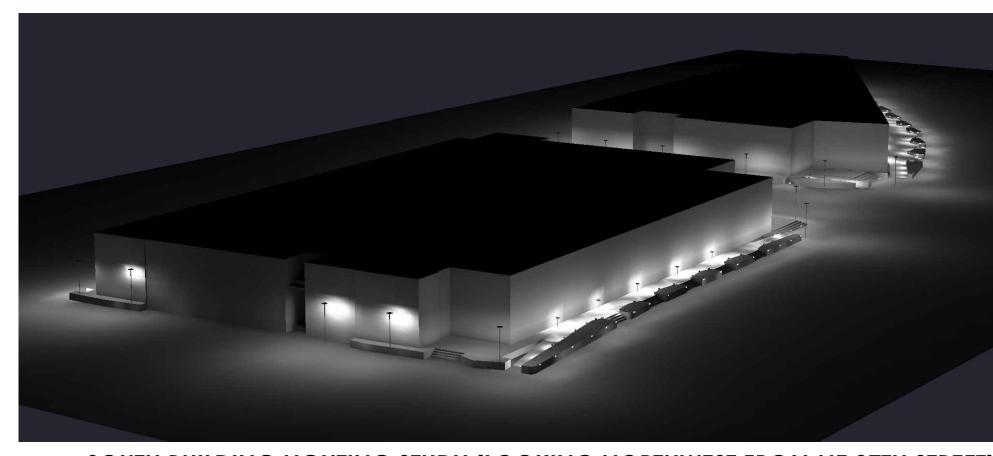

SOUTH BUILDING LIGHTING STUDY (LOOKING NORTHWEST FROM NE 37TH STREET)

N.T.S.



SOUTH BUILDING LIGHTING STUDY (LOOKING SOUTHEAST FROM NE 38TH STREET)

N.T.S.

GMG chen moore and associates

500 West Cypress Creek Road Suite 630 Ft. Lauderdale, FL 33309 **954.730.0707** www.chenmoore.com

REGISTRATION

CRISTOBAL A. BETANCOURT, RLA
REGISTRATION NO. 6666941
DATE: _5/6/2021______



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CLIENT

OAKLAND PARK DIXIE, LLC

PROJECT INFORMATION

SKY BUILDING

PROJECT NUMBER 20-487.001

CLIENT PROJECT NUMBER

VERIFY SCALES

0 ► 1"

IF NOT ONE INCH ON THIS SHEET,

ADJUST SCALES ACCORDINGLY

REVISIONS

⚠ DRC COMMENTS

DATE OF ISSUE 03.18.2021

DESIGNED BY

DRAWN BY

CHECKED BY

DRAWING TITLE

GROUND FLOOR LIGHTING STUDY AND DETAILS

L8.02

AMENITY DECK LIGHTING PLAN LIMIT OF WORK SECOND FLOOR AMENITY DECK

LUMINAIRE SCHEDULE AND CALCULATION SUMMARY

| LU | LUMINAIRE SCHEDULE | | | | | | | | | | | |
|--------|--------------------|------|---------|--------------|---------------|--|------------------|-------|--------------------|-------------------|--|--|
| Proj | ject: | OAKI | LAND PA | RK CITY HALL | - AMENITY DEC | K | | | | | | |
| Symbol | | Qty | Label | Arrangement | Manufacturer | Description | Luminaire Lumens | LLF | Luminaire Watts | Assembly Watts | | |
| | | 36 | W | SINGLE | Bega US | 33 154 MH: RECESSED MOUNT A.F.F. (bottom of fixture) | 514 | 0.855 | 8 | 8 | | |

| CALCULATION SUMMARY | | | | | | | | | | | |
|--|-------------|-------|------|-----|-----|---------|---------|--|--|--|--|
| Project: OAKLAND PARK CITY HALL - AMENITY DECK | | | | | | | | | | | |
| Label | CalcType | Units | Avg | Max | Min | Avg/Min | Max/Min | | | | |
| AMENITY DECK | Illuminance | Fc | 3.08 | 9.4 | 0.5 | 6.16 | 18.80 | | | | |

Agailaction
LED occessed wall luminaries - unshielded location luminairies

Agailaction
LED occessed will luminaries with unshielded light for use as location humanistic for mains of view flinding.

Must make the fault controlled of dis-cast shumburn make grounds, copper fine (6.03% copper carried ASIGO Burntum along which is copper for profession by plasma receded casting for increased adhesion light sharper and the statement of the profession of the profes

Chen moore and associates

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DRAWING TITLE

AMENITY DECK LIGHTING PLAN

DRAWING NUMBER L8.03