PROJECT NUMBER
1608-61
SHEET NUMBER
CS-1

SAFE AND SECURE SELF STORAGE CITY OF OAKLAND PARK, BROWARD COUNTY, FLORIDA OAKLAND LAKES BLVD, LLC.

INDEX OF PLANS

SHEET NO.	SHEET DESCRIPTION						
CS-1	COVER SHEET						
SP-1	SITE PLAN						
CE-1	CONCEPTUAL ENGINEERING PLAN						
CE-2	SITE CROSS SECTIONS AND DETAILS						
PH-1	PHOTOMETRIC PLAN						
A1	FLOOR PLAN WEST - GROUND LEVEL						
A2	FLOOR PLAN EAST - GROUND LEVEL						
A3	FLOOR PLAN WEST- LEVEL 2						
A4	FLOOR PLAN EAST- LEVEL 2						
A5	FLOOR PLAN WEST- LEVEL 3						
A6	FLOOR PLAN EAST- LEVEL 3						
A7	ROOF PLAN - WEST						
A8	ROOF PLAN - EAST						
A9	COMBINED PLANS - GROUND LEVEL & LEVEL 2						
A10	COMBINED PLANS - LEVEL 3 & ROOF PLAN						
A11	BUILDING ELEVATIONS						
A12	BUILDING ELEVATIONS						
A13	BUILDING ELEVATIONS - COMBINED						
A14	IDENTITY SIGNAGE MONUMENT SIGN						
L-1	LANDSCAPE PLAN						
T-1	TREE DISPOSITION PLAN						

LEGAL DESCRIPTION:

SURVEY


A PORTION OF TRACTS G AND H, OAKLAND LAKES, ACCORDING TO THE PLAT THEREOF AS RECORDED IN PLAT BOOK 111, PAGE 7 OF THE PUBLIC RECORDS OF BROWARD COUNTY, FLORIDA.

NOTES:

THE PROPOSED WORK HAS BEEN DESIGNED IN ACCORDANCE WITH ALL APPLICABLE, FEDERAL, STATE, COUNTY AND CITY CODES AND REGULATIONS HAVING JURISDICTION. IF ANY DISCREPANCIES EXIST BETWEEN THE PLANS/ SPECIFICATIONS PREPARED BY THE DESIGNER AND THE CITY CODE AND/OR THE CITY STANDARD DETAILS, THE LATER SHALL GOVERN OR THE MOST STRINGENT.

ALL VEGETATION, MUCH, AND ANY DELETERIOUS MATERIAL WITHIN THE ROW LIMITS OF ALL STREETS AND ALLEYS AND REQUIRED OFF-STREET PARKING AREAS MUST BE REMOVED AND REPLACED WITH CLEAN FILL MATERIAL, FREE OF STUMPS, LARGE ROOTS OR OTHER MATERIAL NOT SUITABLE FOR INCLUSION IN ROADWAY FILL.

OWNERSHIP AND MAINTENANCE OF THE SANITARY SYSTEM BY THE CITY IS LIMITED TO THE MAINS FROM MANHOLE TO MANHOLE AND EXPRESSLY EXCLUDES SEWER LATERAL SERVICES. THE SEWER LATERAL SERVICE FROM GRAVITY MAIN INTO THE BUILDING IS TO BE MAINTAINED BY THE PROPERTY OWNER.

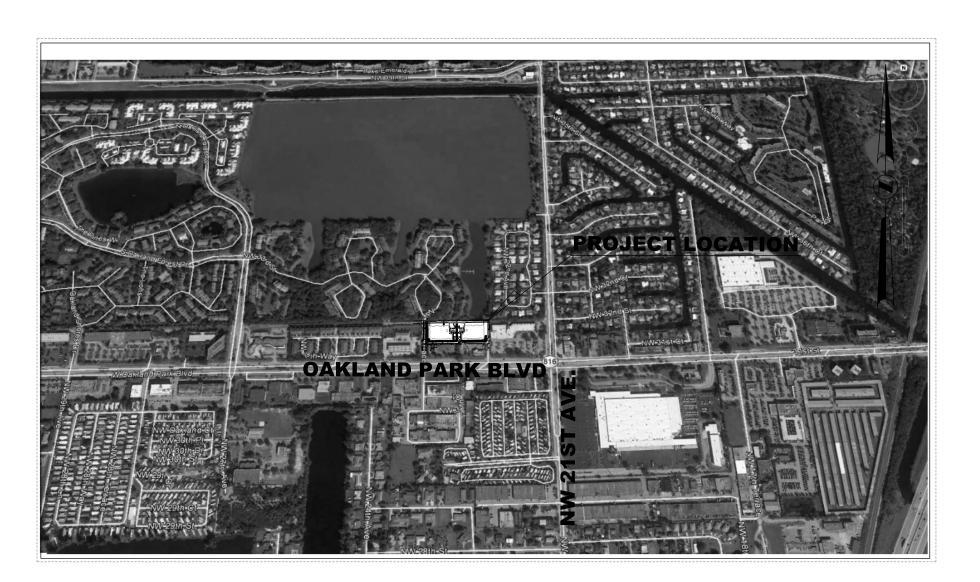

LOCATION MAP

SCALE: 1" = 200' SECTION 21 / TOWNSHIP 49 S / RANGE 42 E

SITE PLAN



HSQ GROUP, INC.

Engineers · Planners · Surveyors

1001 Yamato Road, Suite 105

1001 Yamato Road, Suite 105 Boca Raton, Florida 33431 · 561.392.0221 CA26258 · LB7924

DEVELOPER:

THE PUGLIESE COMPANY 101 PUGLIESES WAY DELRAY BEACH, FL 33444 (561) 454-1625

PLANNER:

HSQ GROUP, INC. 1001 YAMATO ROAD SUITE 105 BOCA RATON, FL 33431 (561) 392-0221

ARCHITECT:


KENNETH R. CARLSON ARCHITECT, P.A. 1166 W. NEWPORT CENTER, DRIVE STE 311 DEERFIELD BEACH, FL 33442 (954) 427-8848

CIVIL ENGINEER:

HSQ GROUP, INC. 1001 YAMATO ROAD SUITE 105 BOCA RATON, FL 33431 (561) 392-0221


LANDSCAPE ARCHITECT:

MICHEAL J PETROW & ASSOCIATES, INC CORAL SPRINGS, FL (954) 752-7762

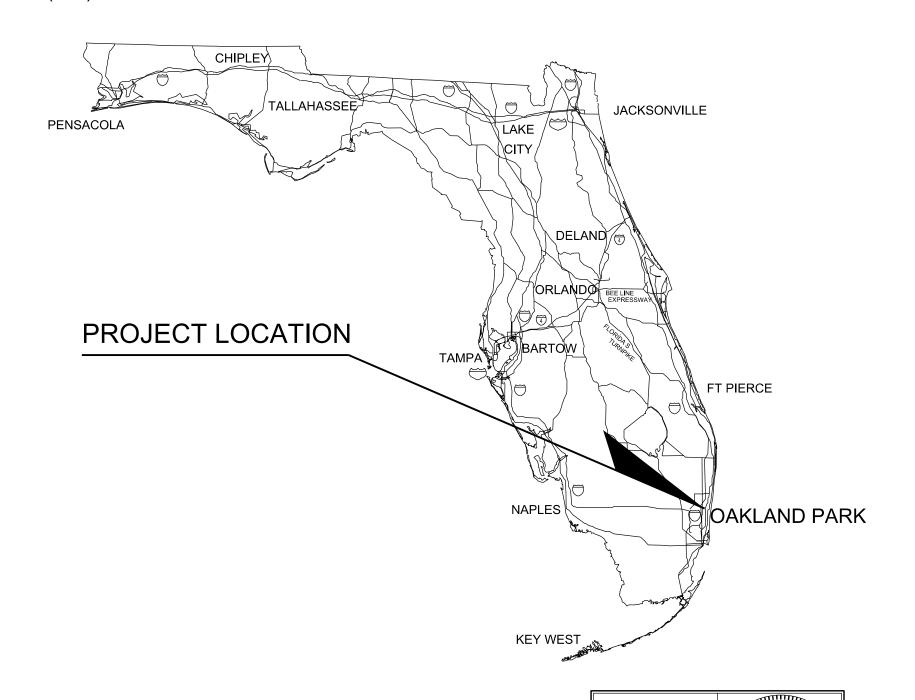



ENGINEER'S CERTIFICATION

THESE PLANS WERE PREPARED UNDER MY DIRECTION AND TO THE BEST OF MY KNOWLEDGE AND BELIEF COMPLY WITH THE INTENT OF THE MANUAL OF UNIFORM MINIMUM STANDARDS FOR DESIGN, CONSTRUCTION AND MAINTENANCE FOR STREETS AND HIGHWAYS AS ADOPTED BY THE STATE OF FLORIDA LEGISLATURE, CHAPTER 72-328 F.S.

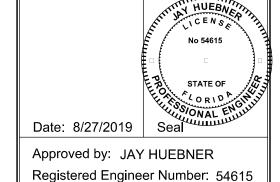

State of Florida

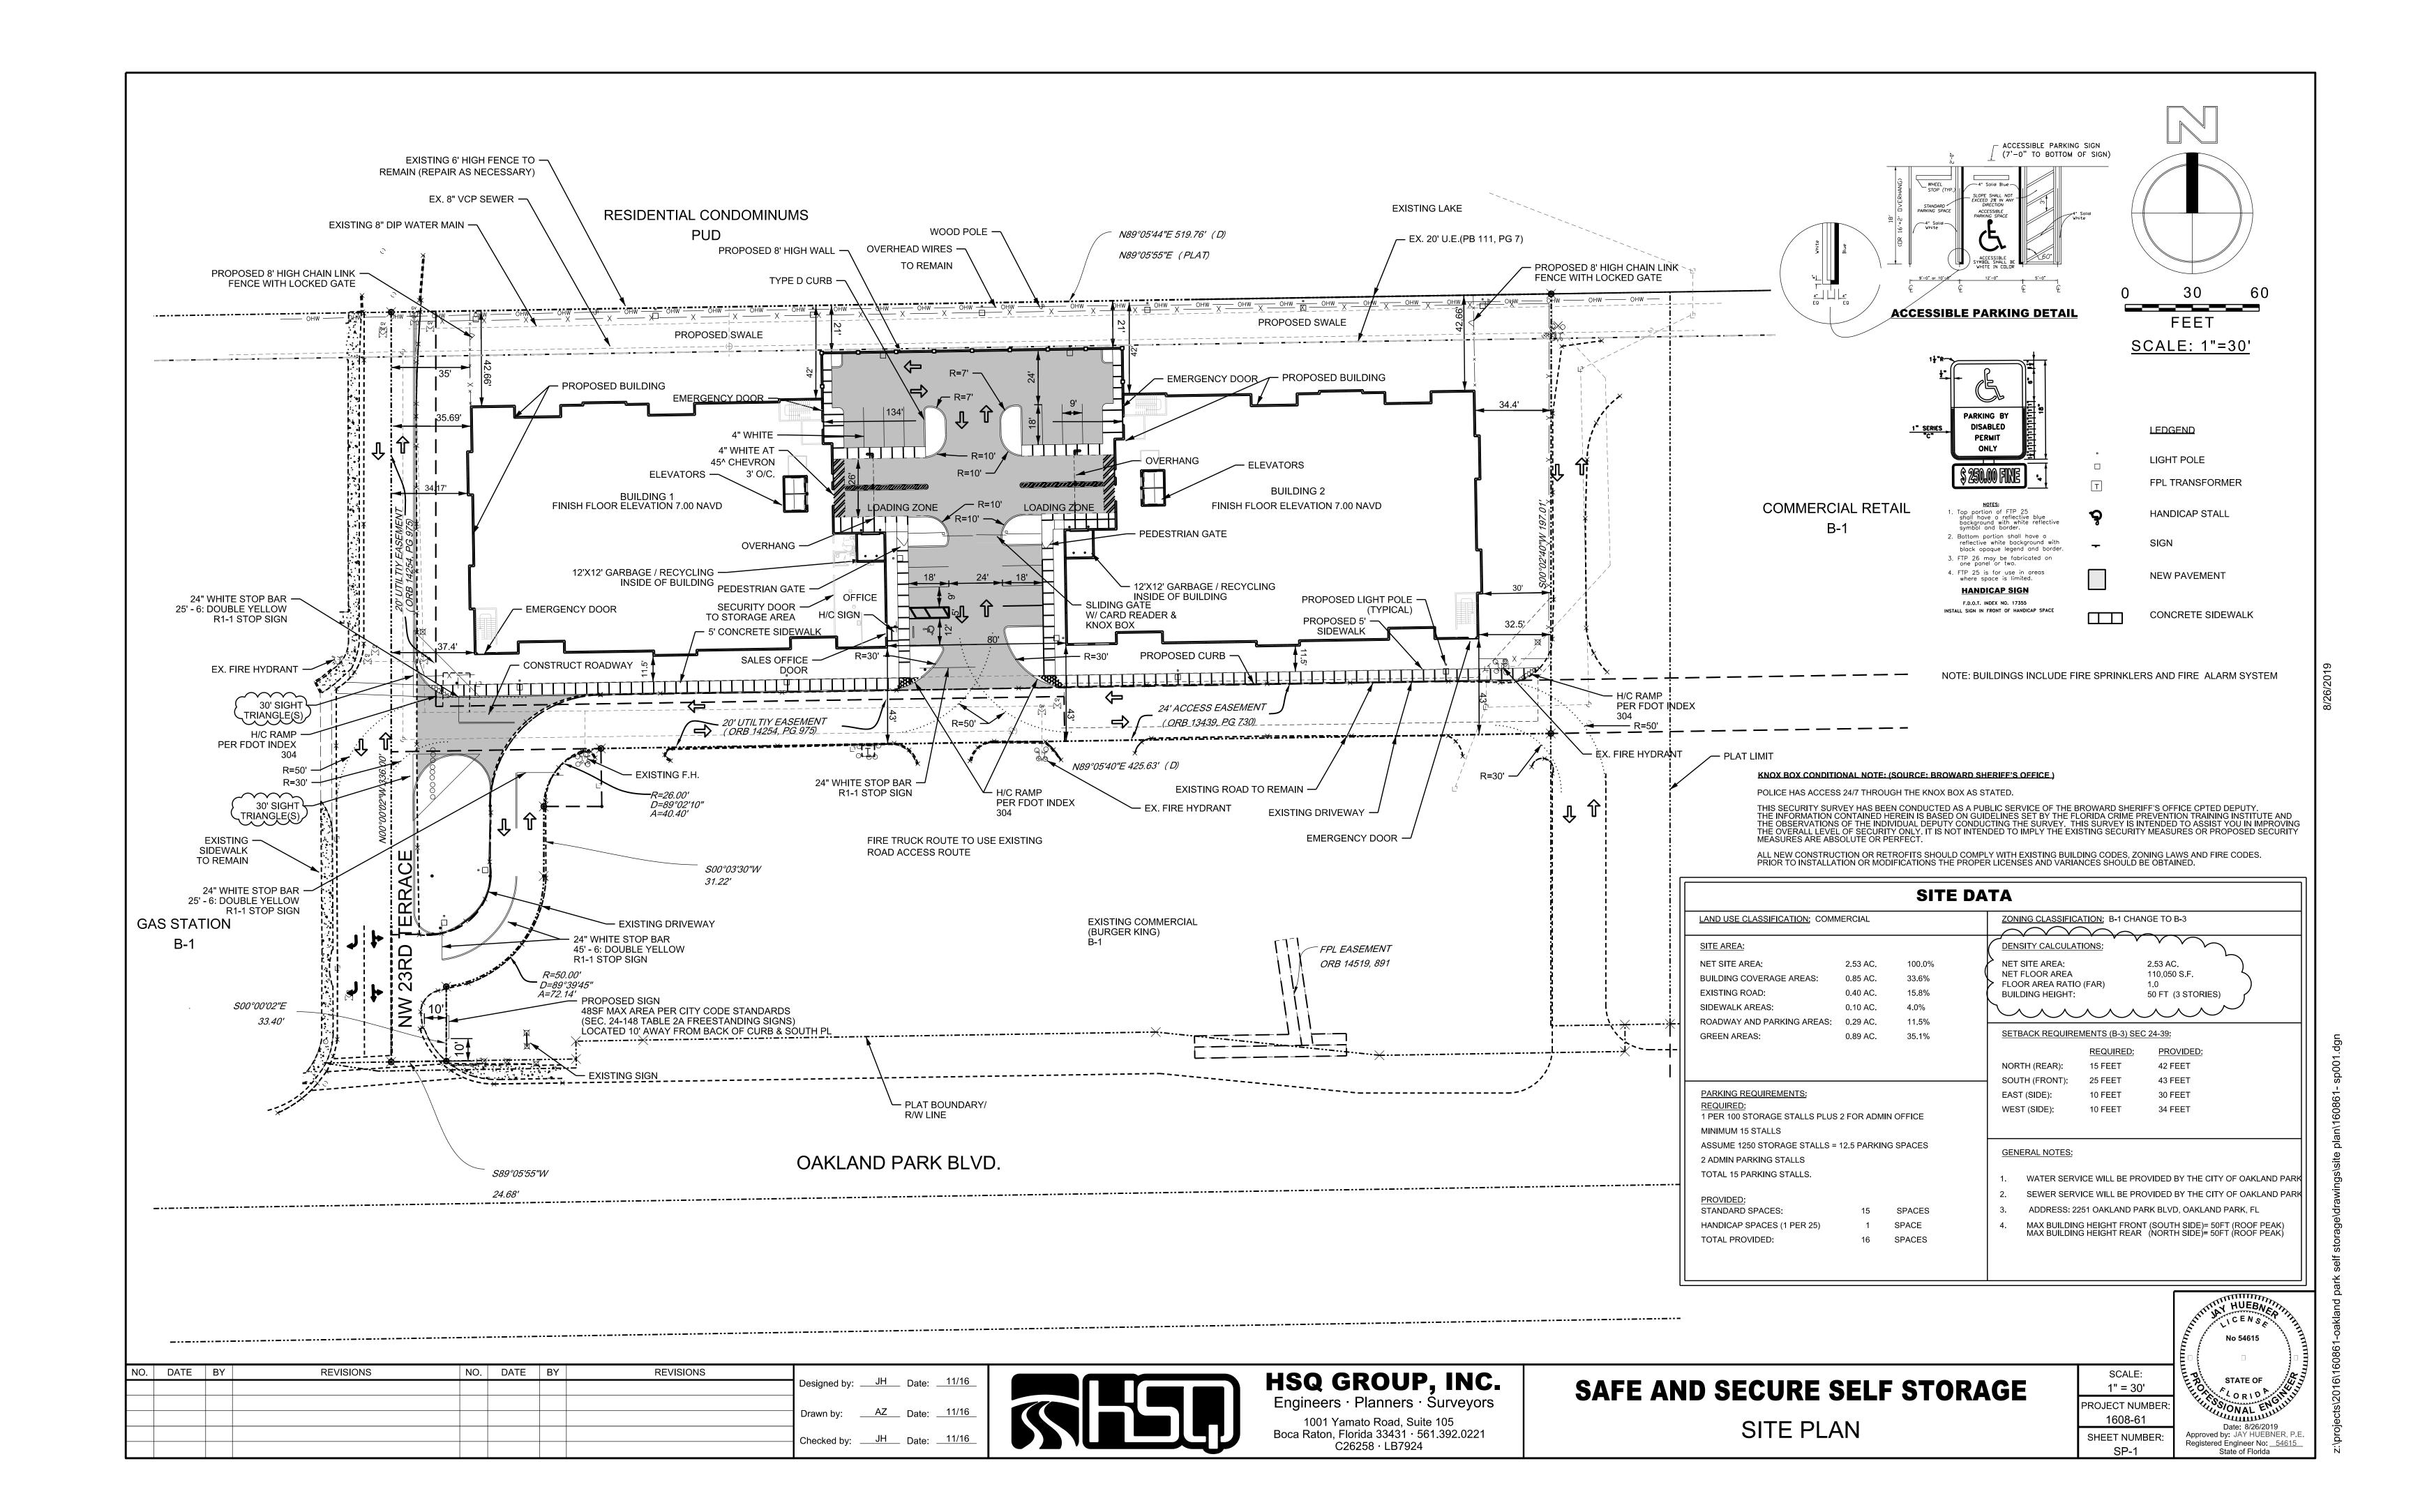

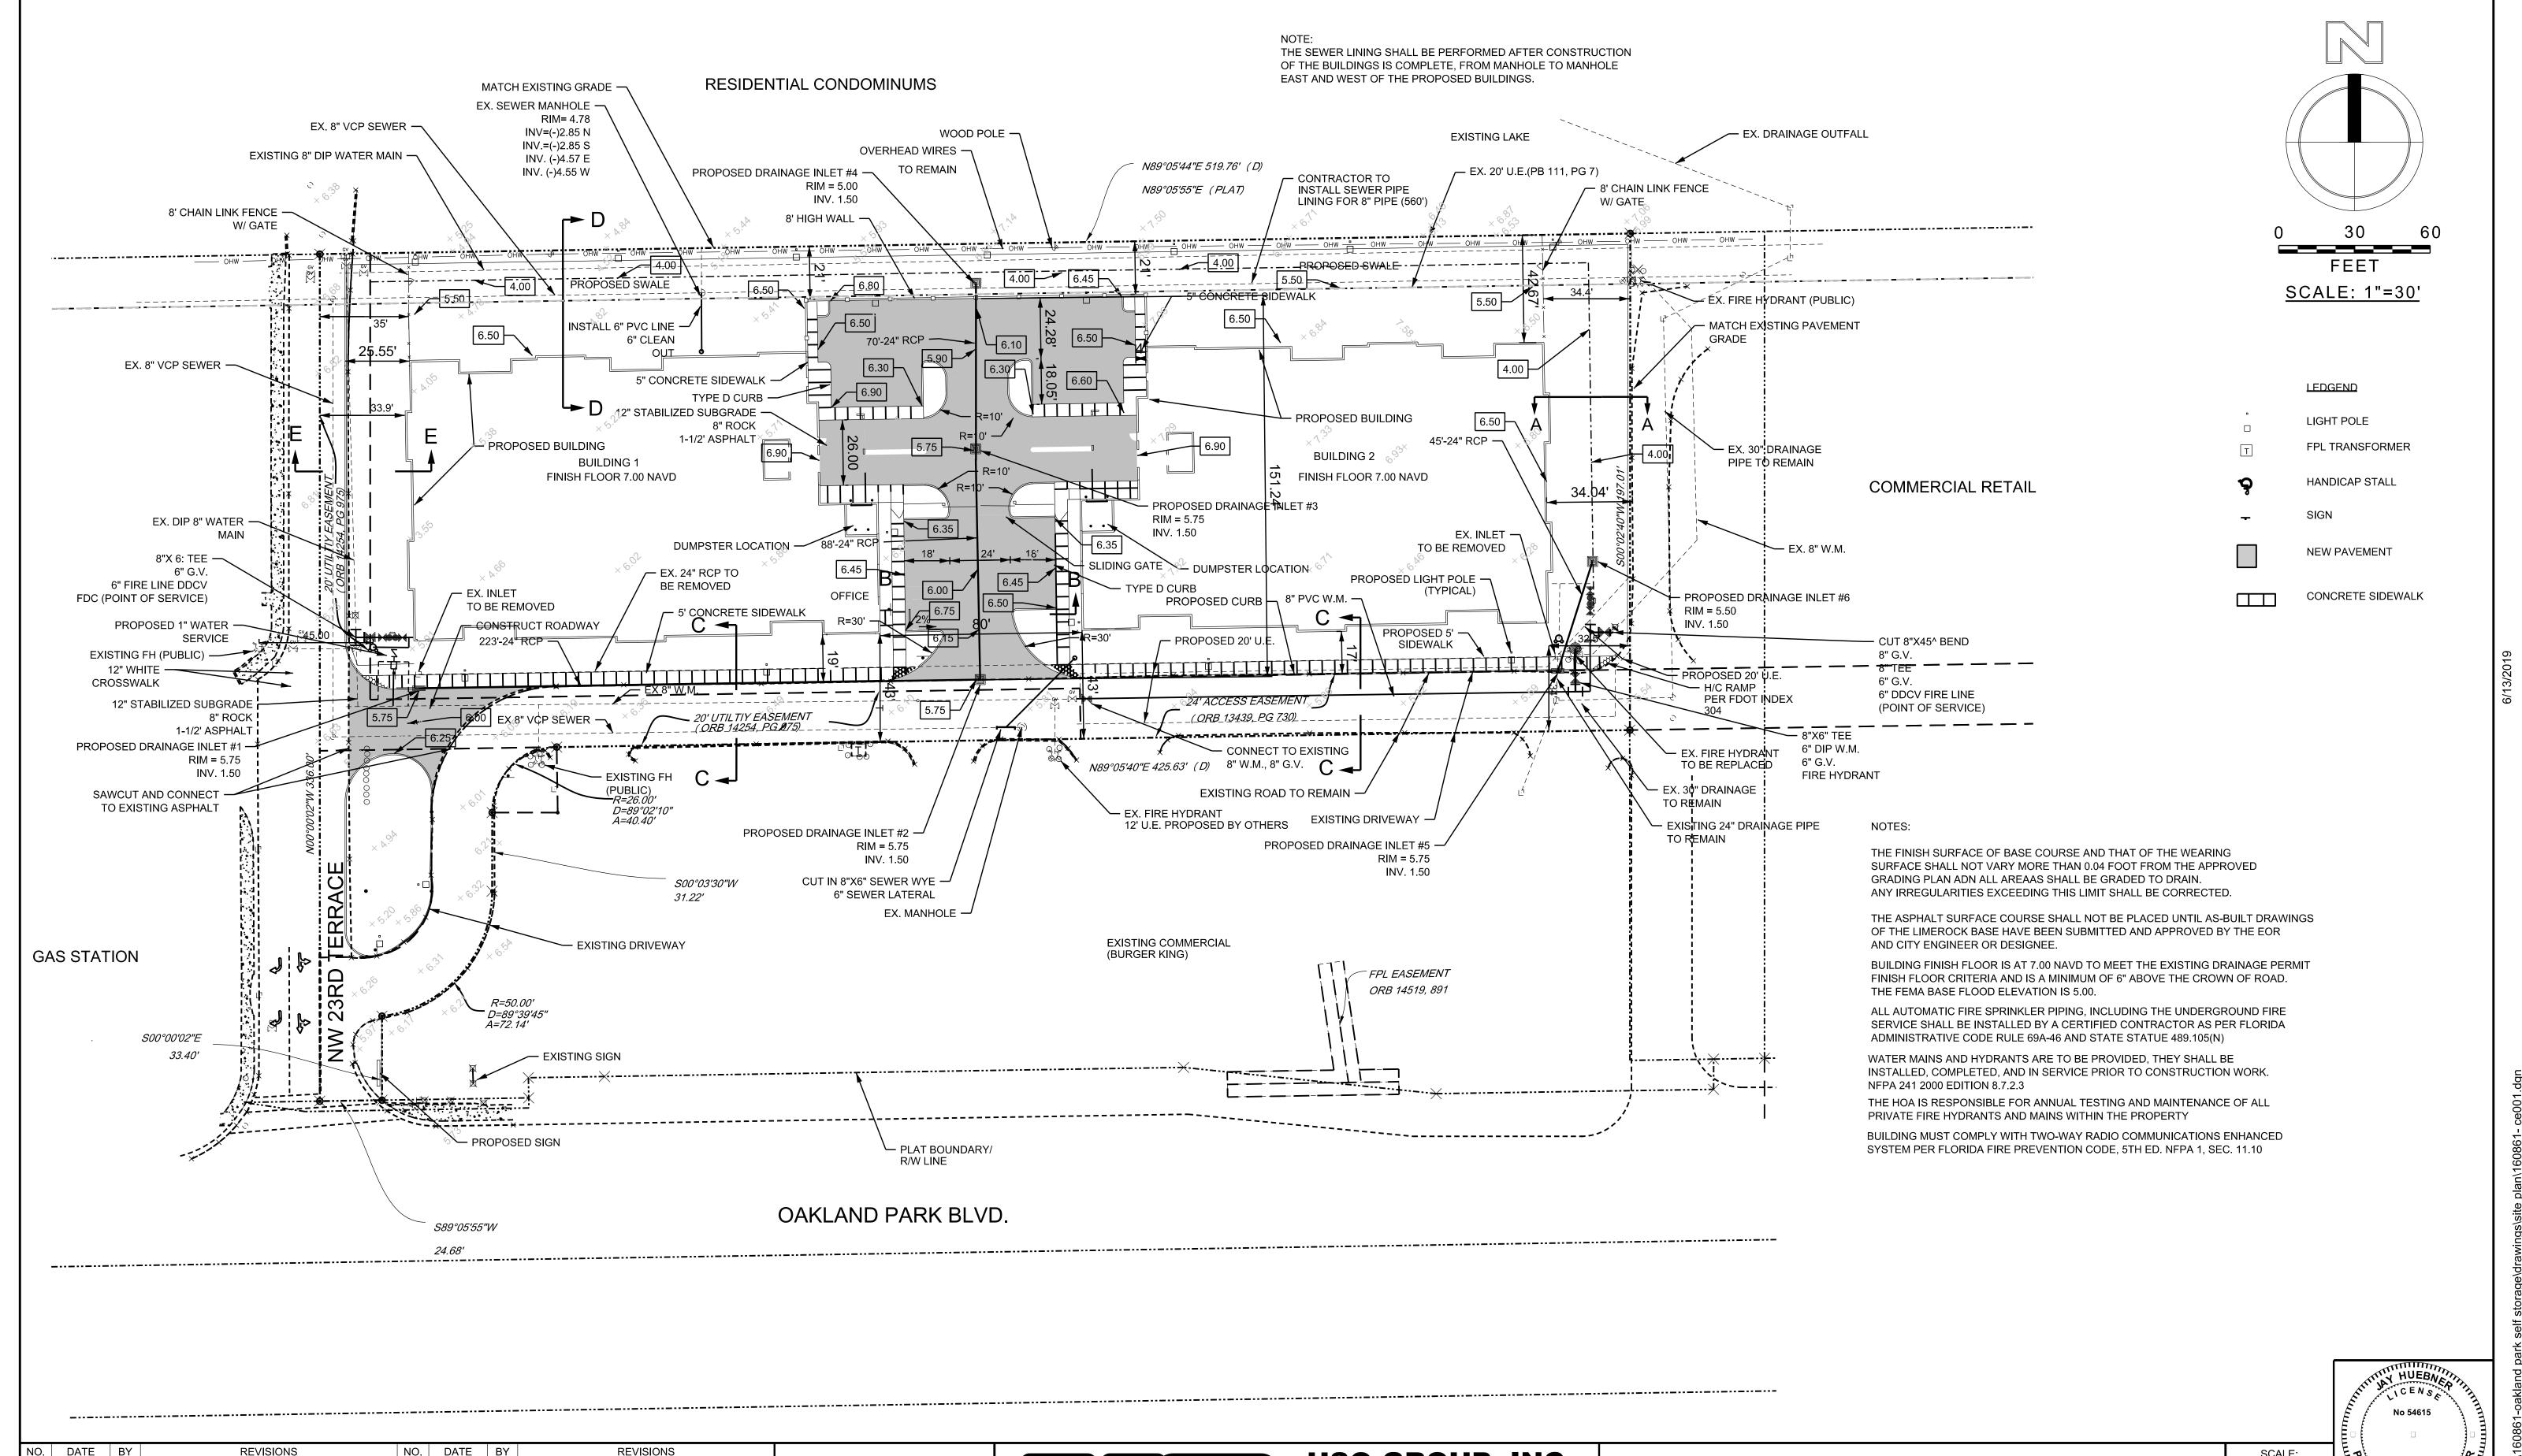

HSQ GROUP, INC.
Engineers · Planners · Surveyors


1001 Yamato Road, Suite 105
Boca Raton, Florida 33431 · 561.392.0221
C26258 · LB7924


6/1/17 JMH REVISE BUILDING FOOT PRINT.


5/17/17 JMH REVISE PER DRC COMMENTS


SAFE AND SECURE SELF STORAGE
CONCEPTUAL ENGINEERING PLAN

SCALE:
1" = 30'
PROJECT NUMBER
1608-61
SHEET NUMBER:
CE-1

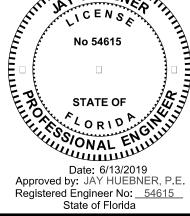

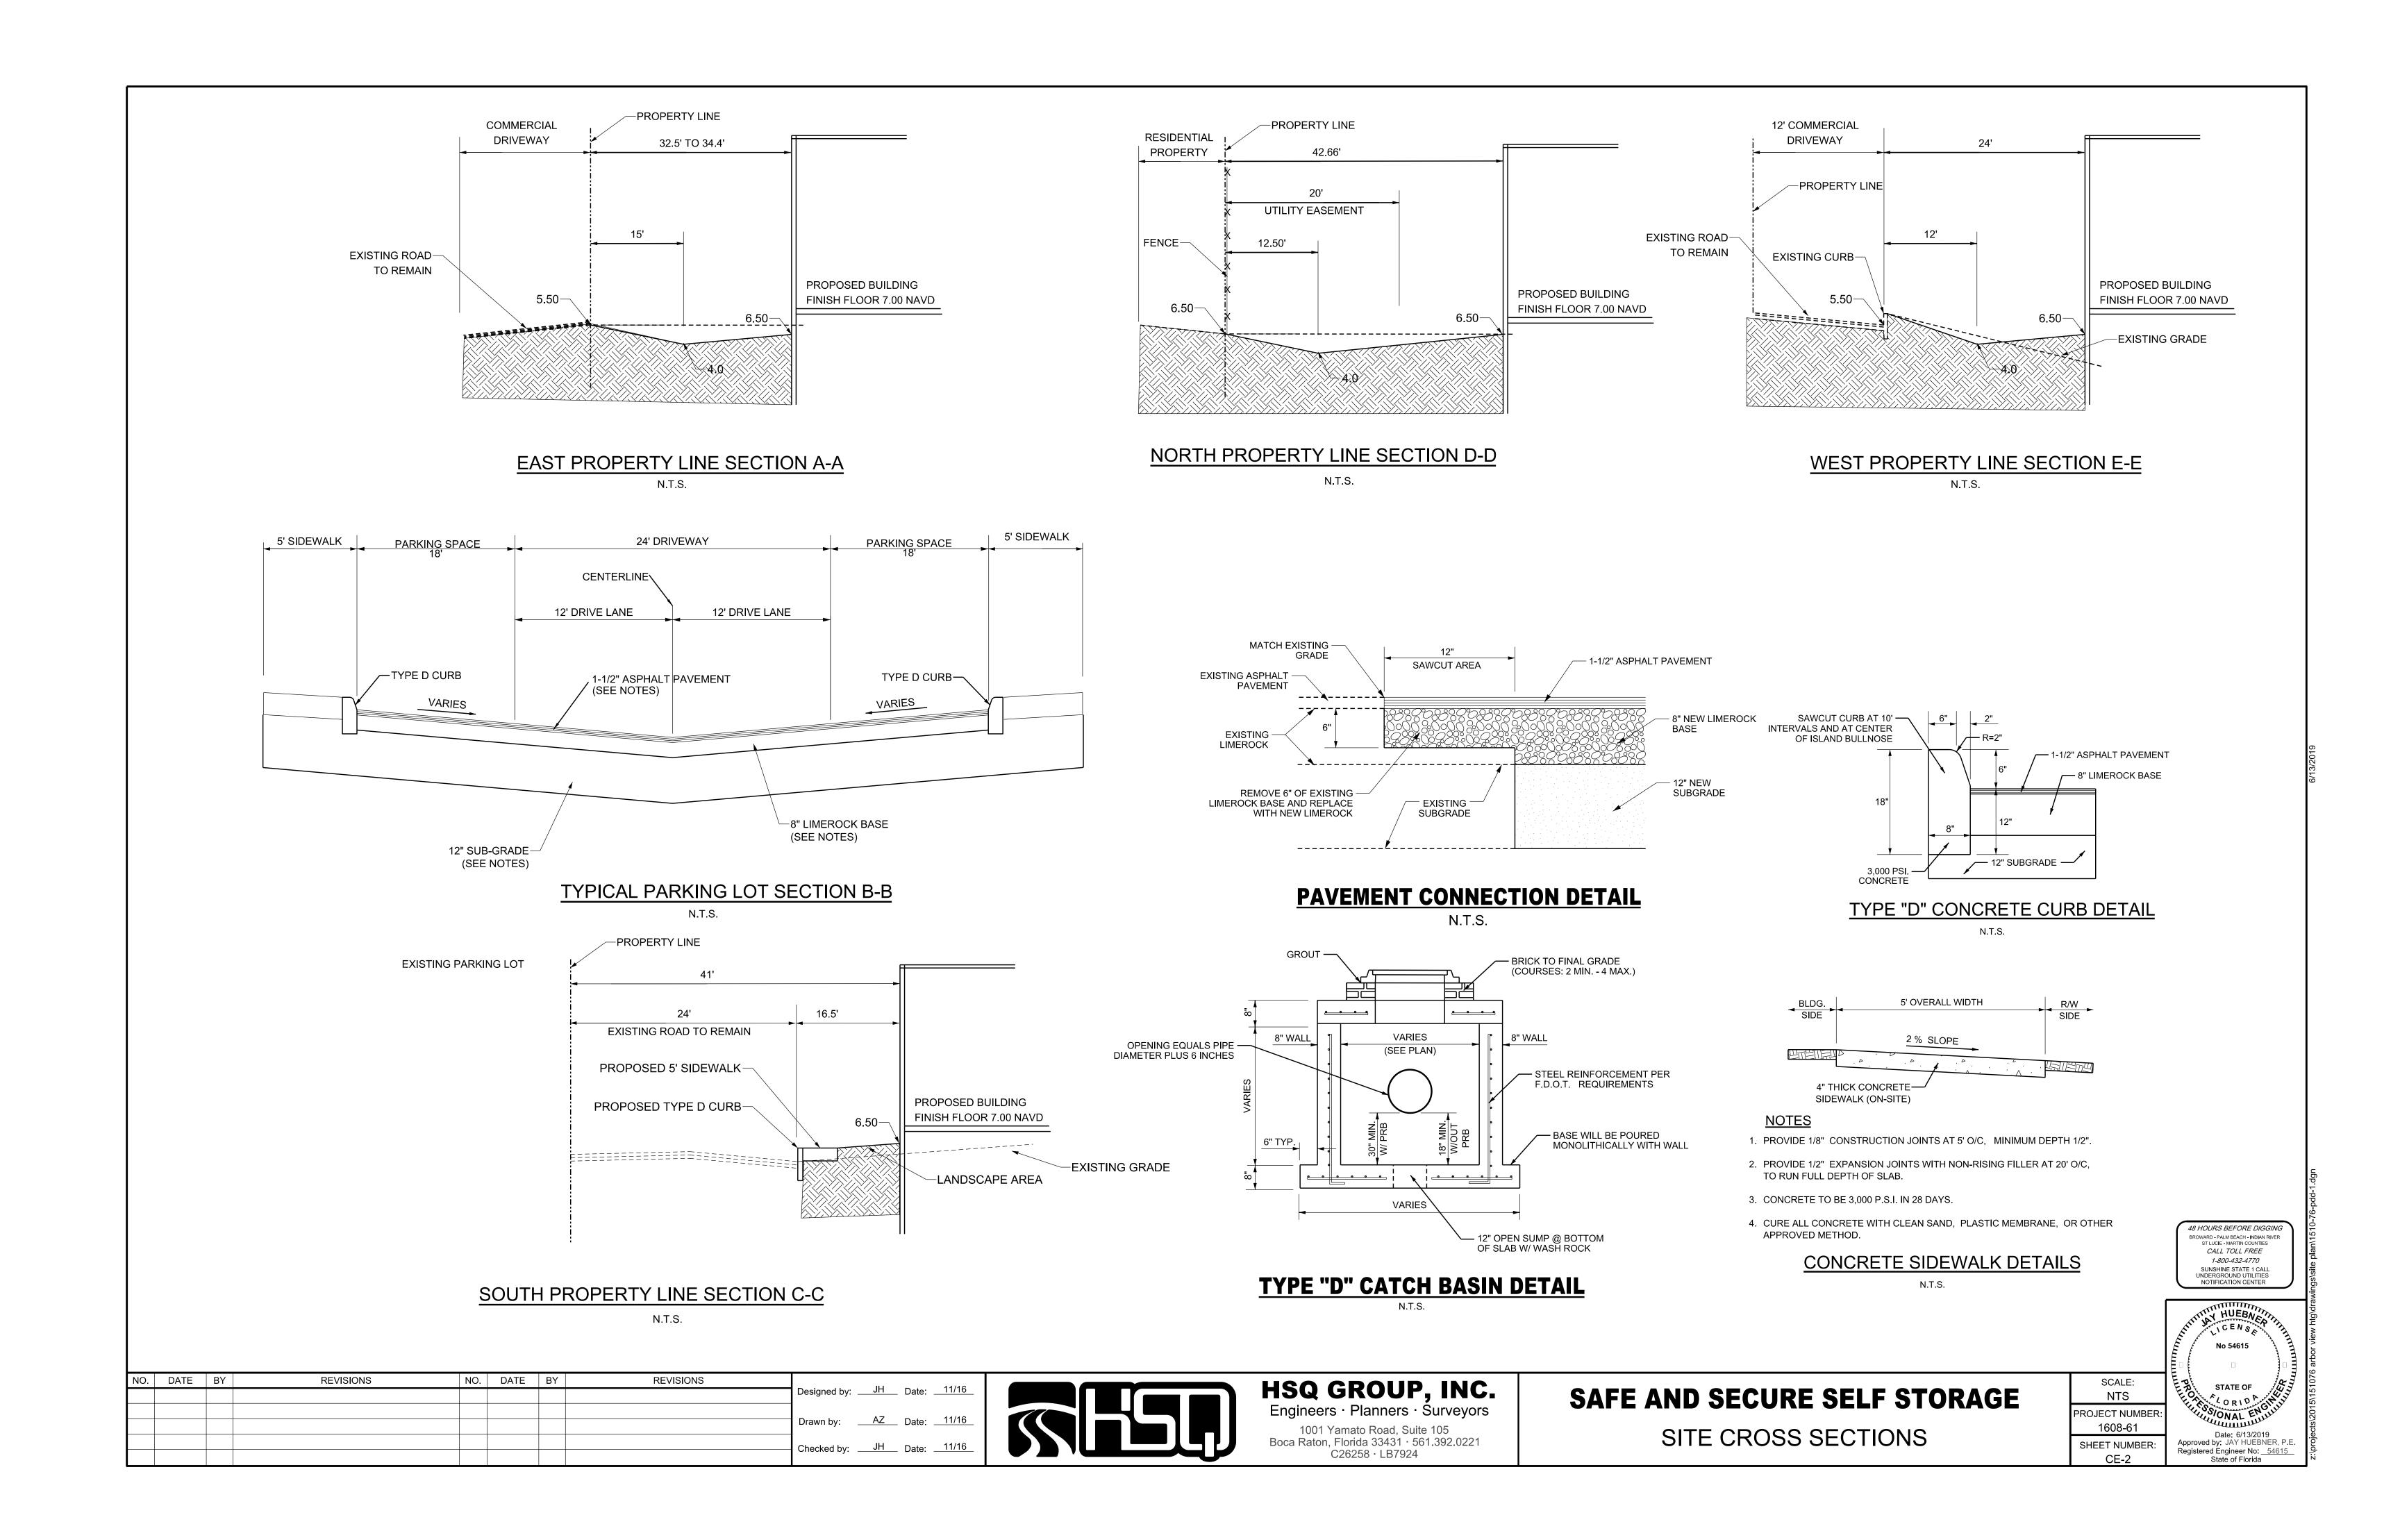

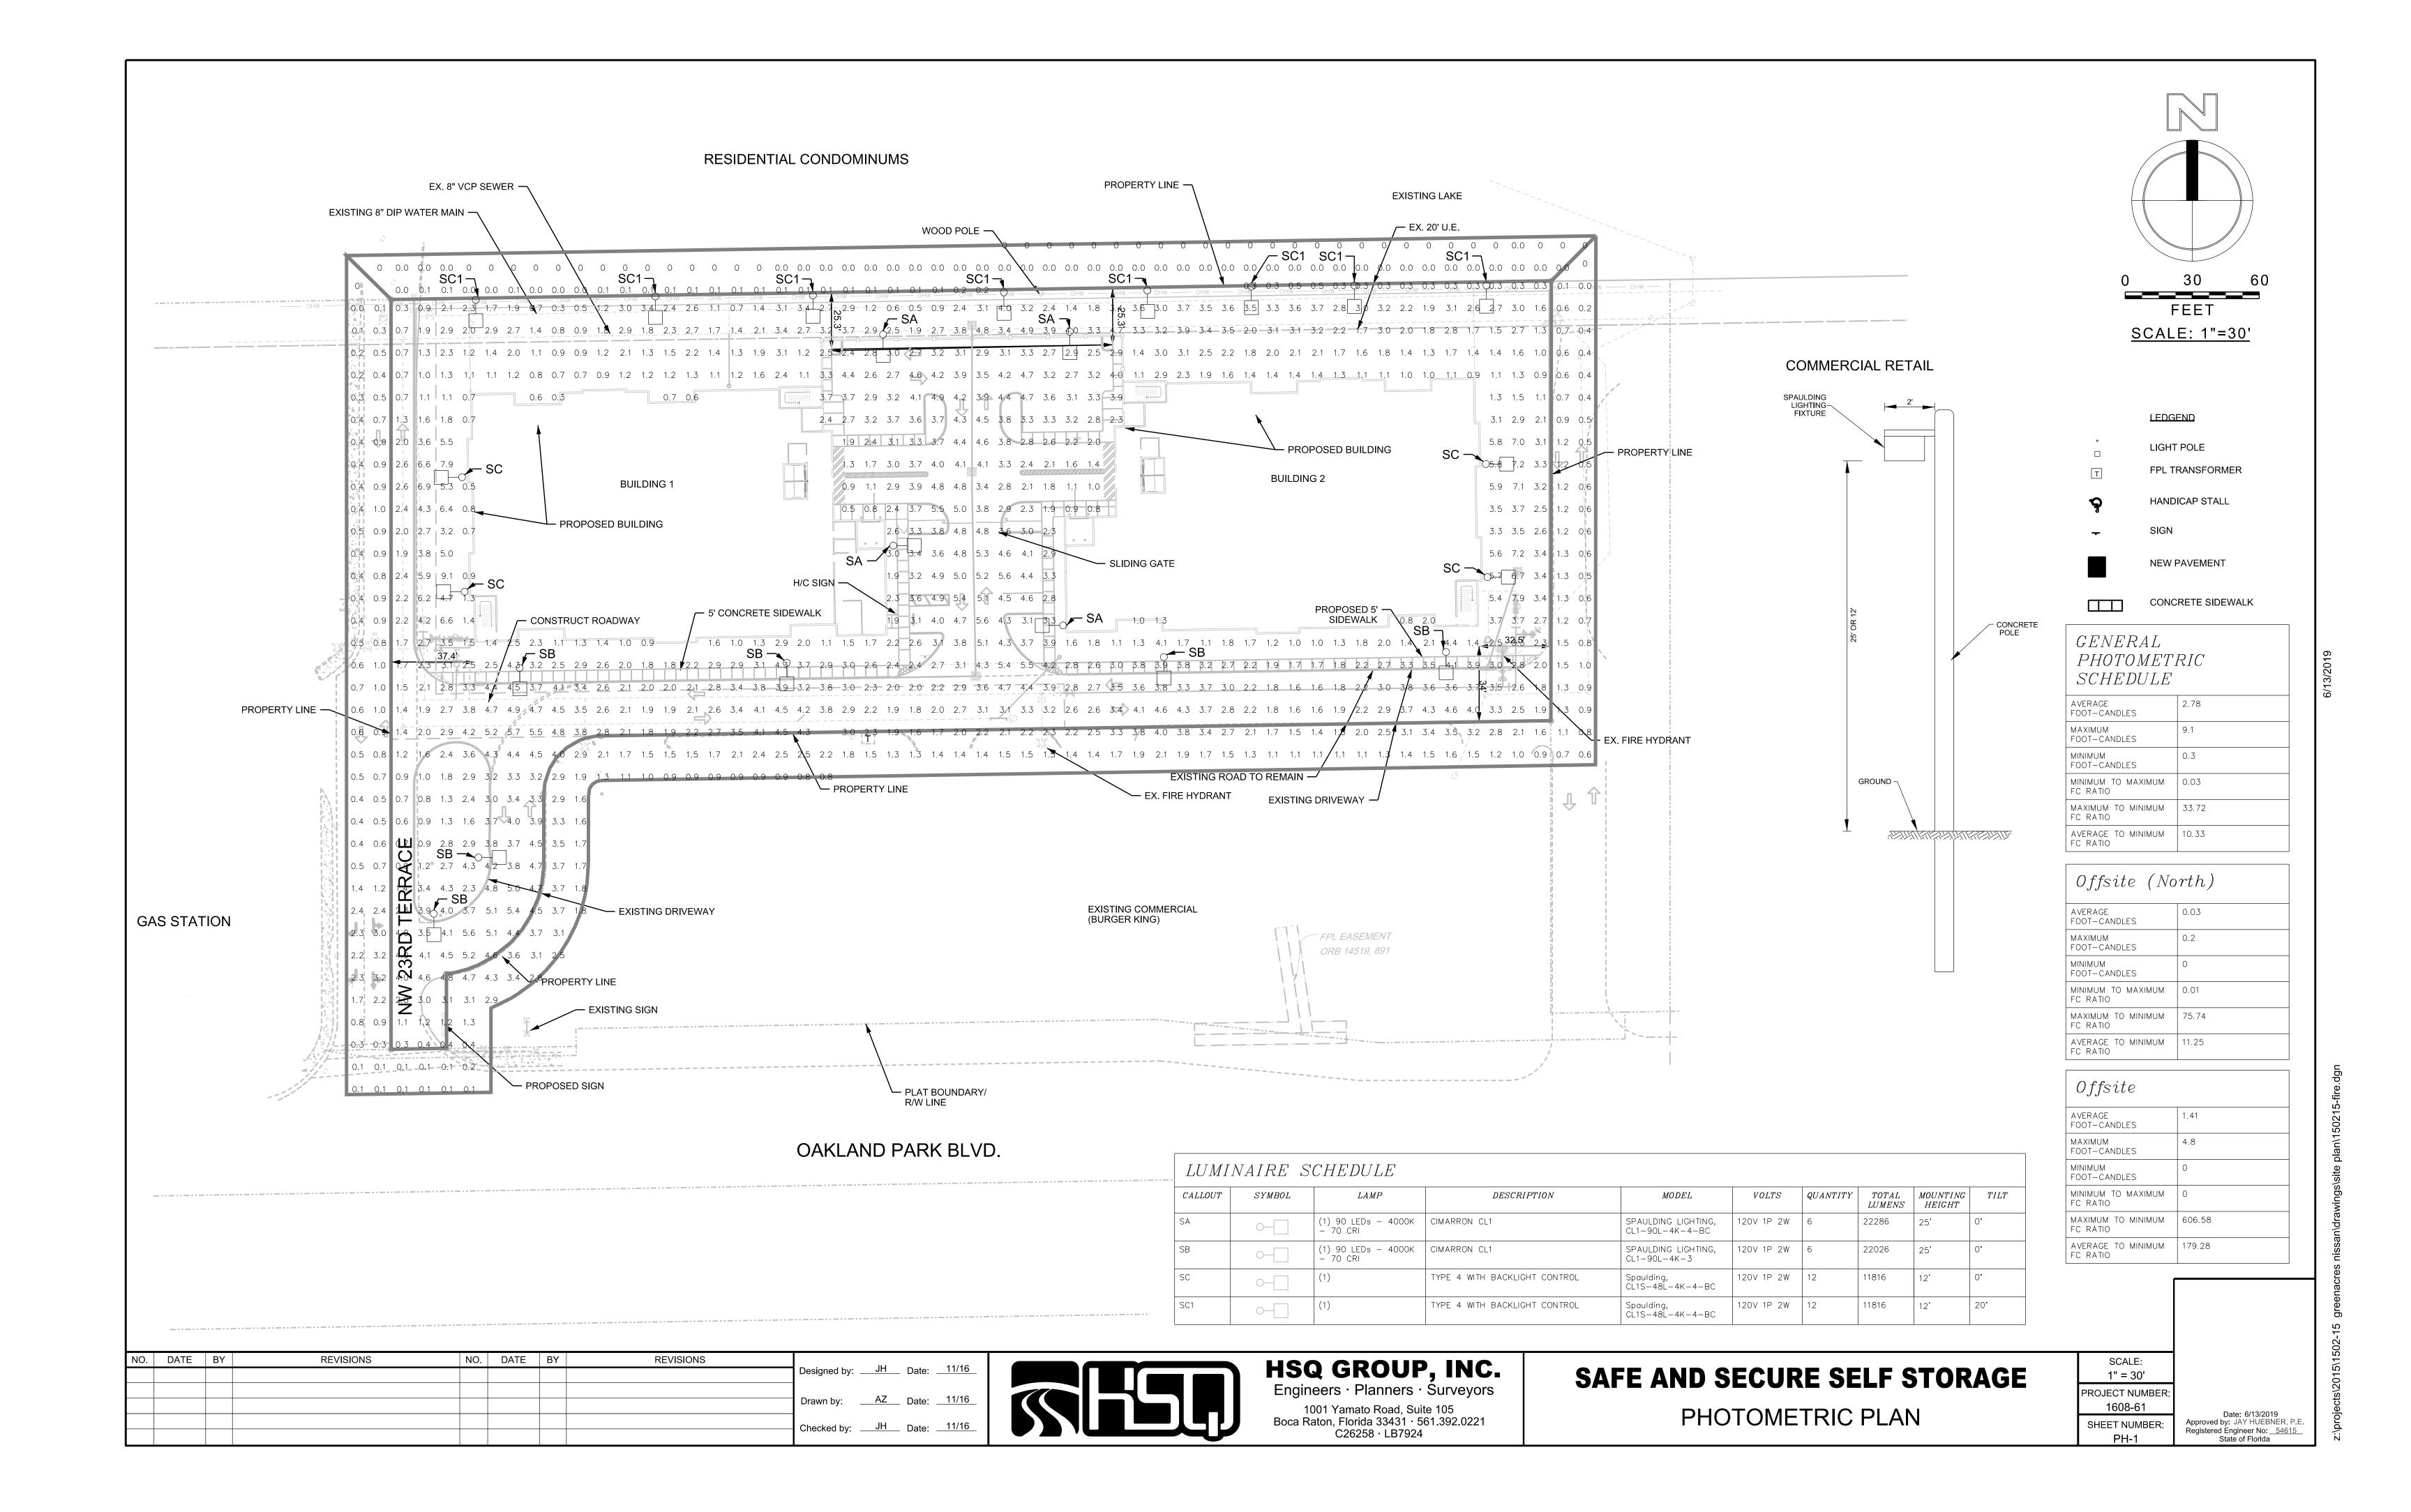

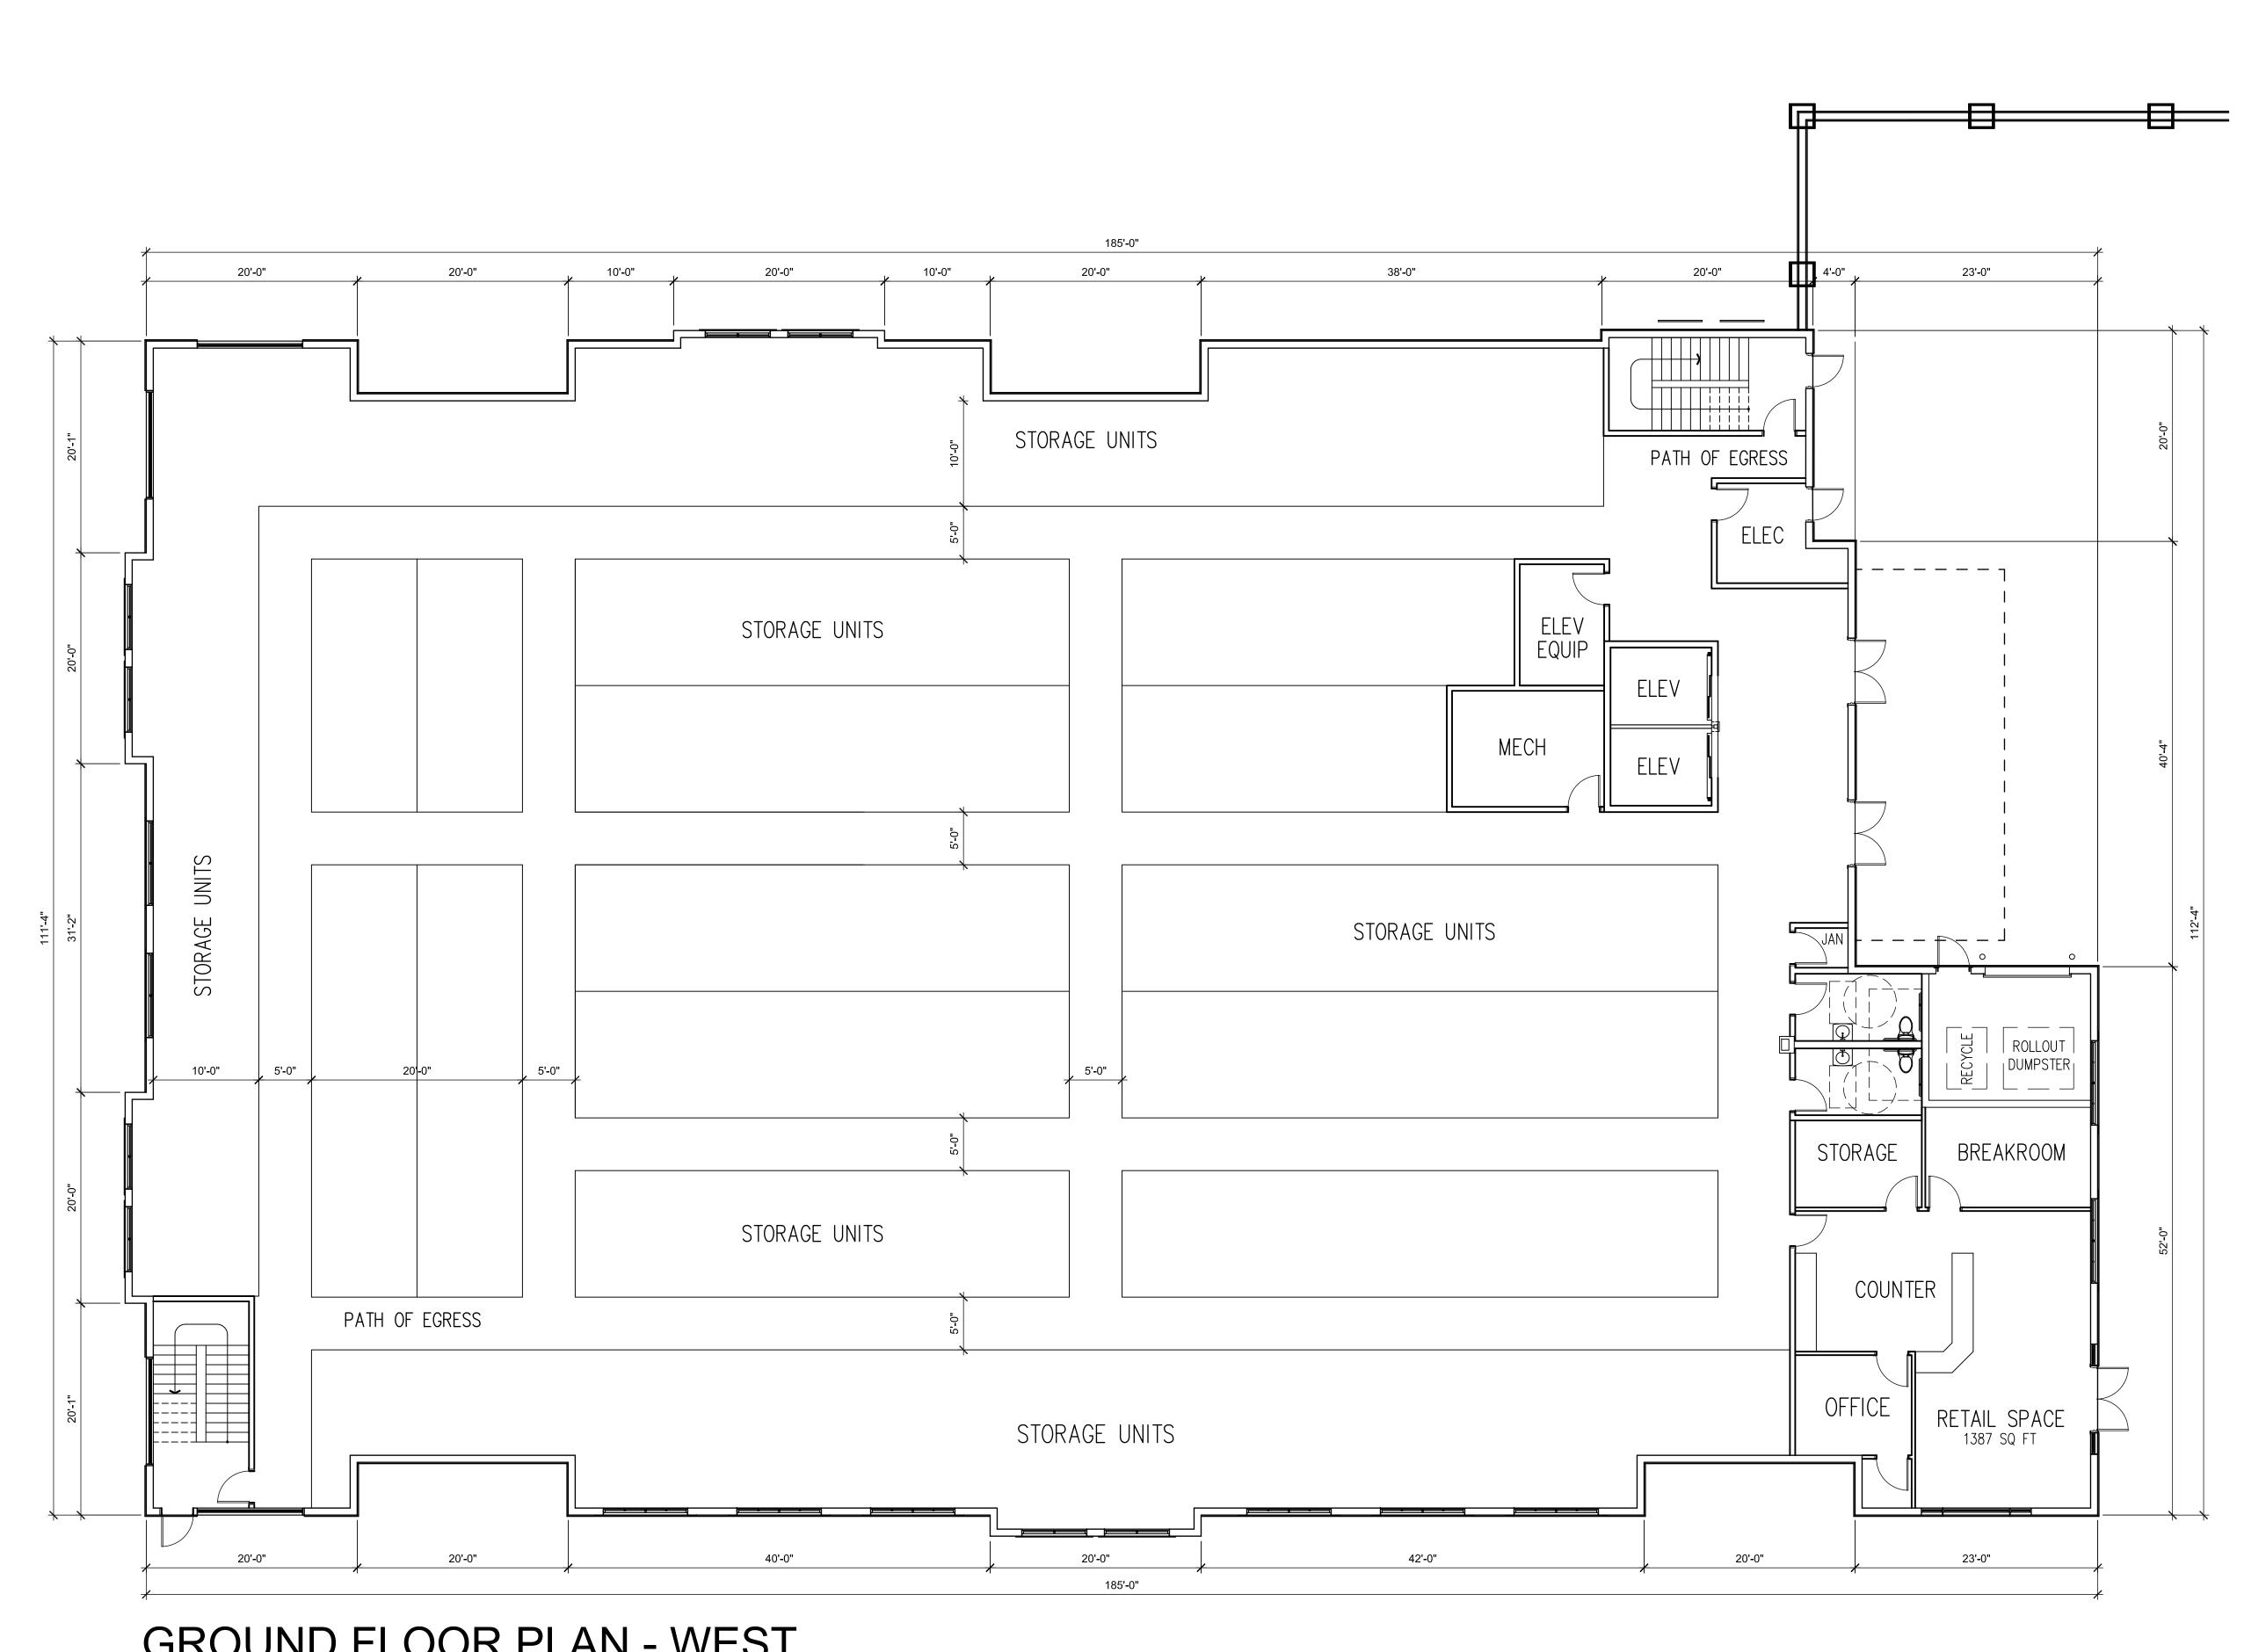

GROUND FLOOR PLAN - WEST

SCALE: 1/8" = 1'-0

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NOTES:

BUILDING OCCUPANCY: STORAGE GROUP S-2


OCCUPANT LOAD: RETAIL /OFFICE = 1387 SF /100 = 13.9 OCCUPANTS STORAGE SPACE = 112,109 SF /500 = 224.2 OCCUPANTS CALCULATED TOTAL OCCUPANT LOAD = 238.1 OCCUPANTS ANTICIPATED ACTUAL OCCUPANT LOAD = 20 OCCUPANTS

CONSTRUCTION TYPE: TYPE II-B

DUMPSTER AREA SHALL CONTAIN RECYCLING FACILITIES.

BUILDING SQUARE FOOTAGE: LEVEL 1 - 37,832 SF LEVEL 2 - 37,832 SF LEVEL 3 - 37,832 SF

TOTAL - 113,496 SF

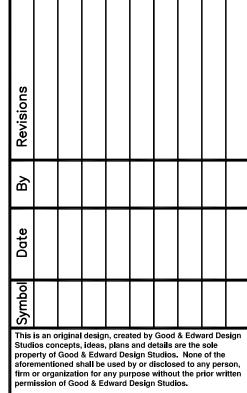




28245 Highway 74 Main Street Evergreen, CO 80439


321-271-0748 GoodEdward.com

FLOOR PLAN - WEST GROUND FLOOR

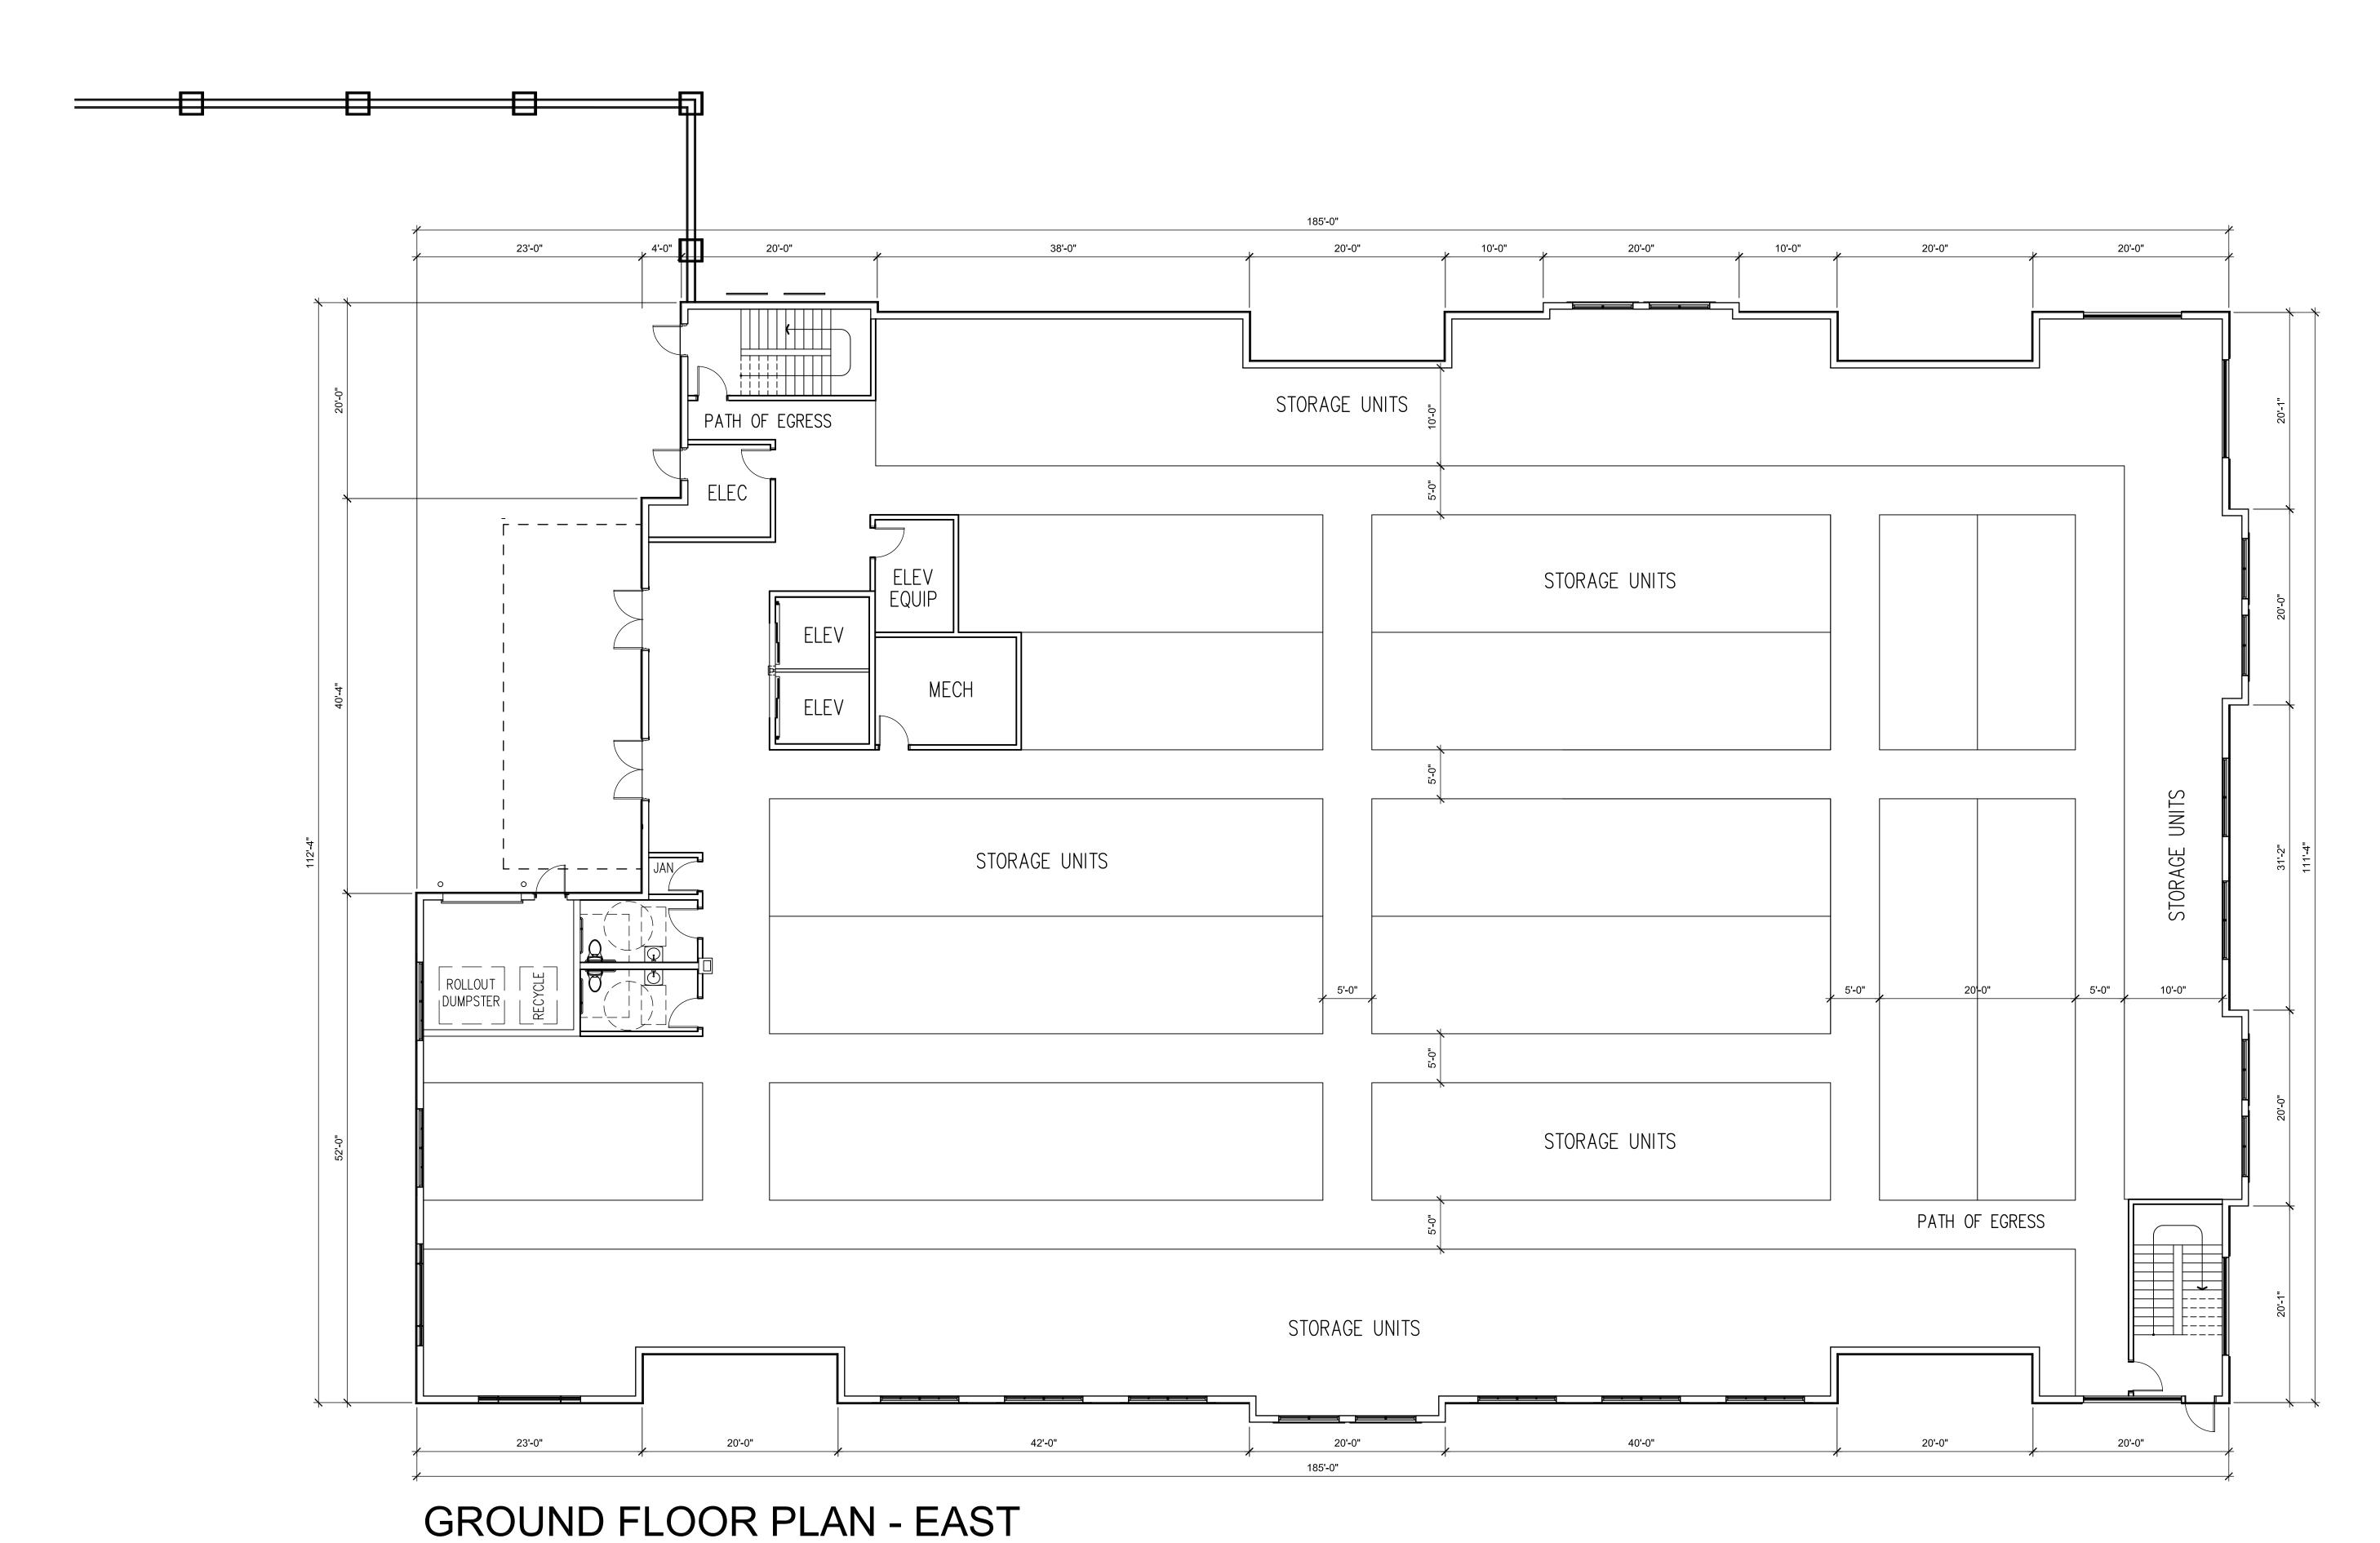

SCALE: 1/8" = 1'-0

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SECOND FLOOR PLAN - WEST

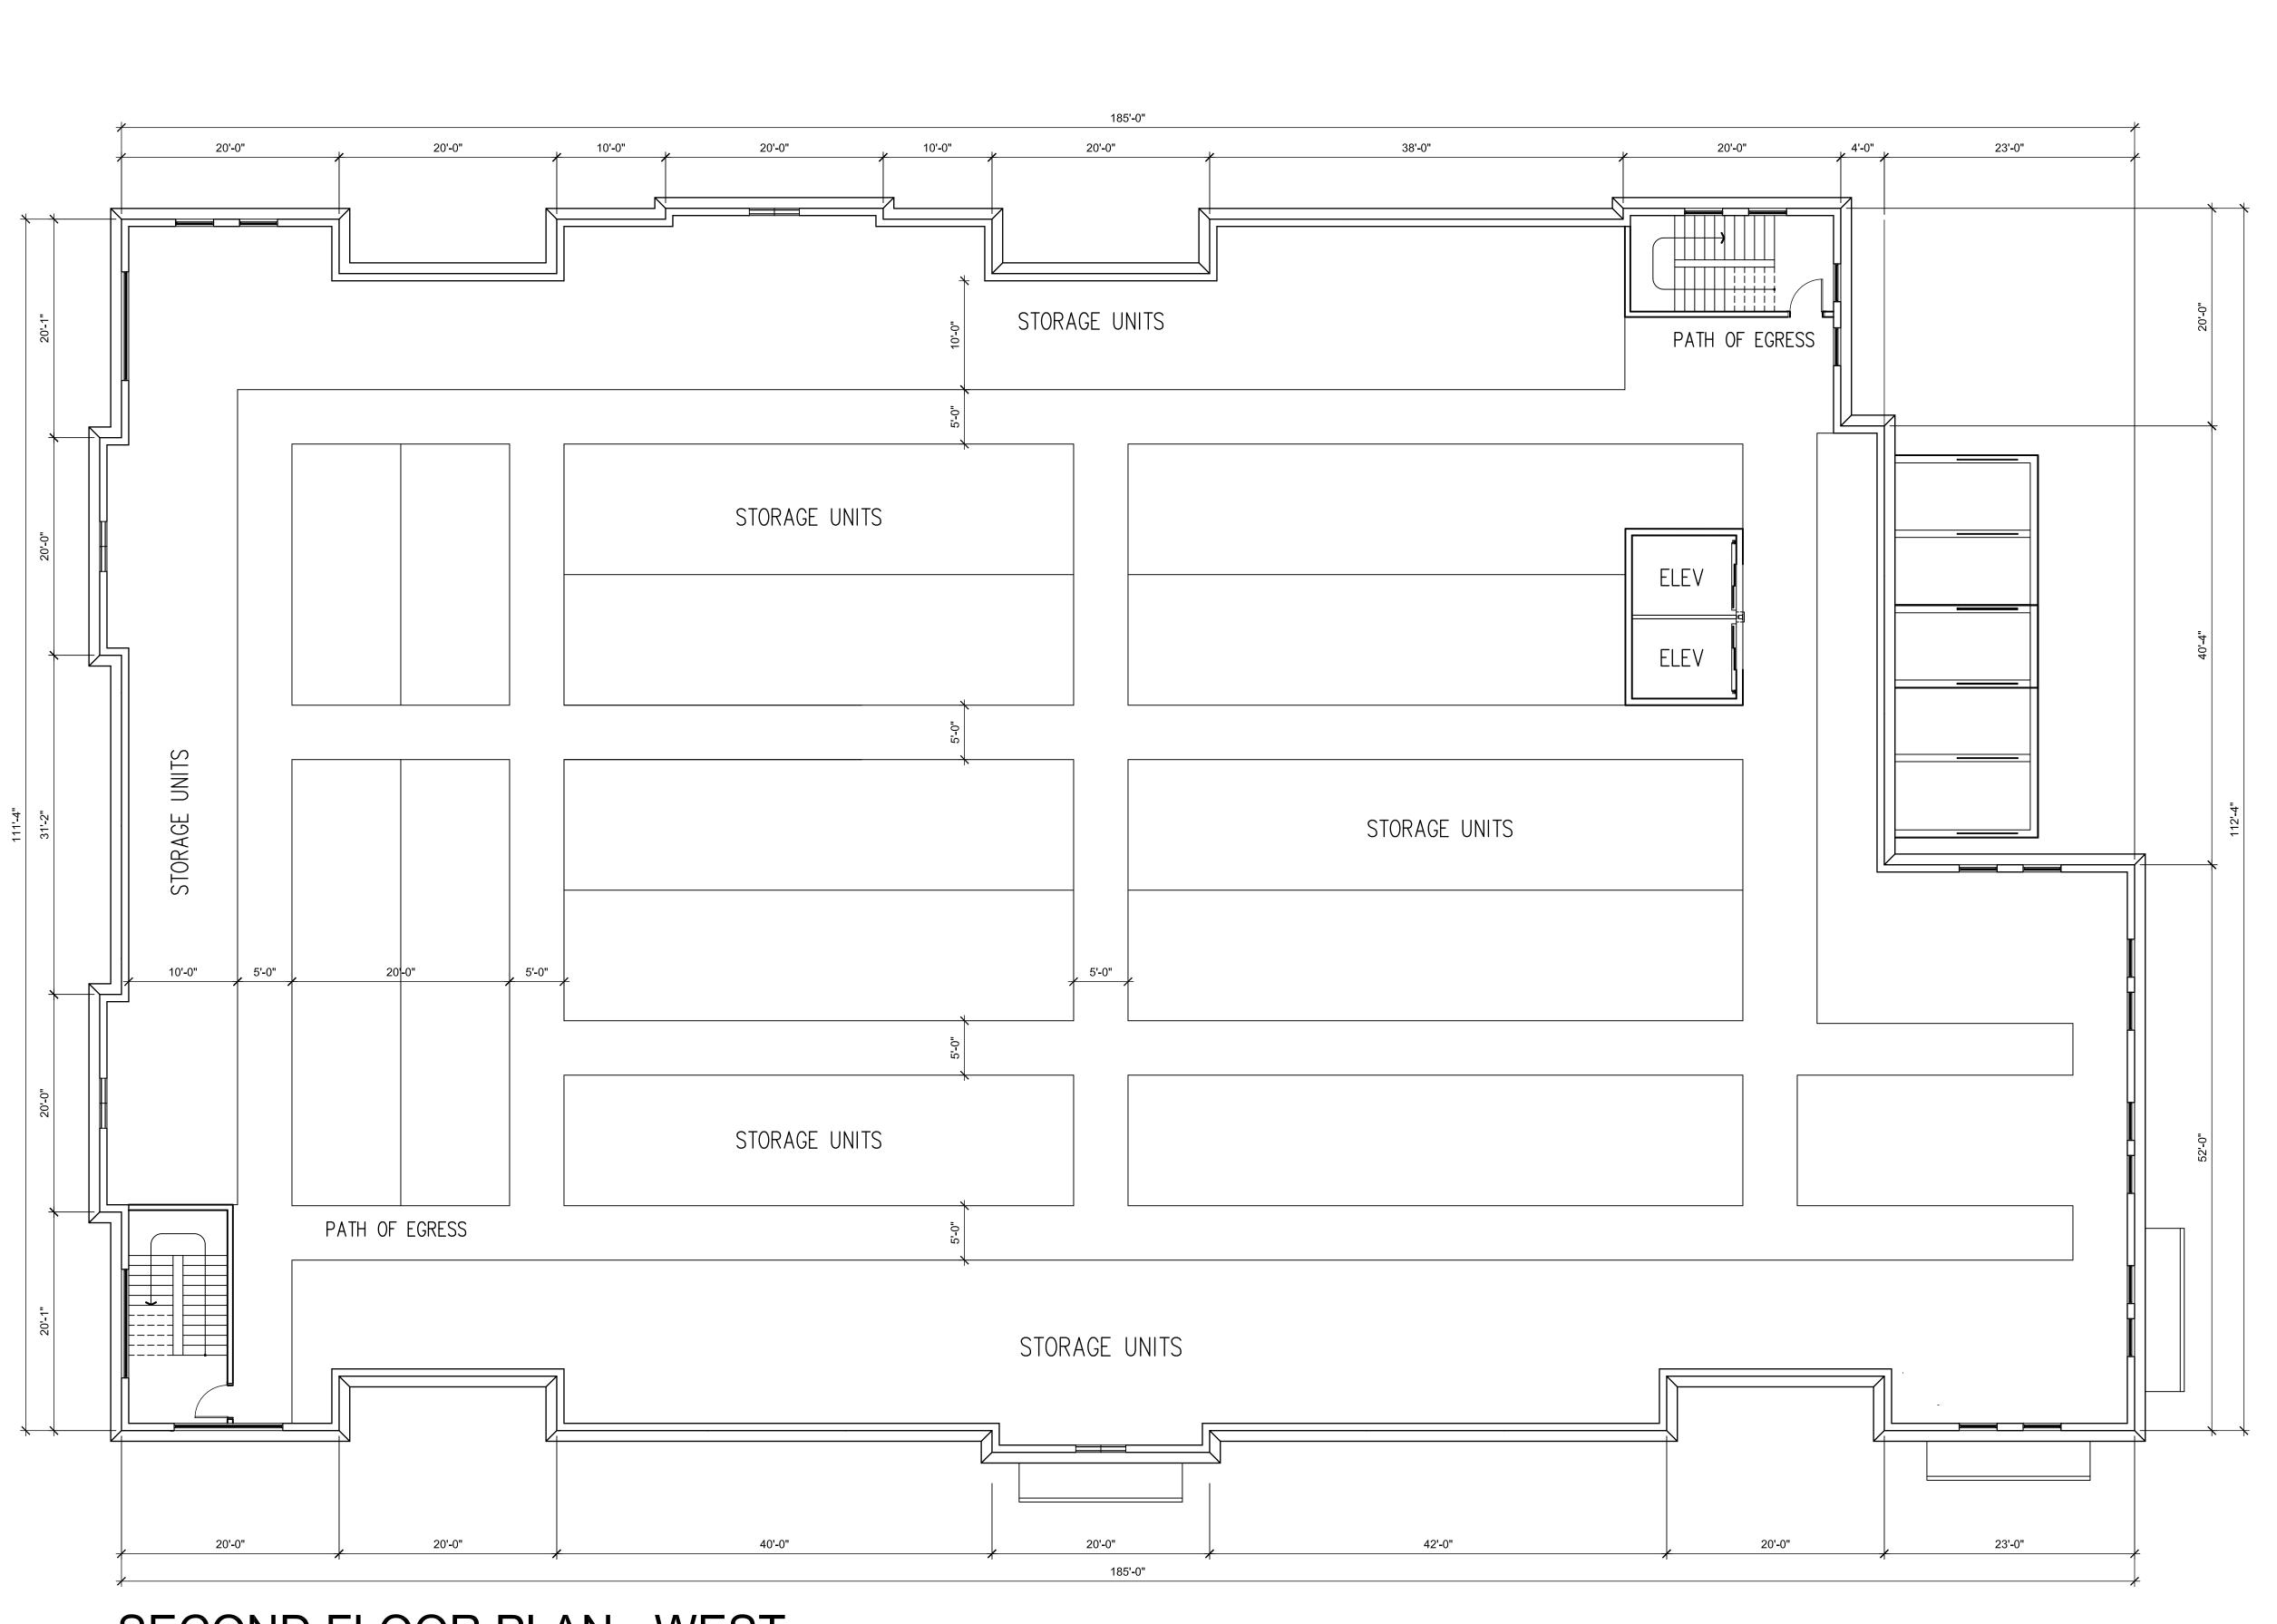
SCALE: 1/8" = 1'-0

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EDWARD DESIGN STUDIOS 28245 Highway 74 Main Street Evergreen, CO 80439 321-271-0748 GoodEdward.com FLOOR PLAN LEVEL 2 WEST


e Job No 1/8" = 1'-0" Drawn

Λ2

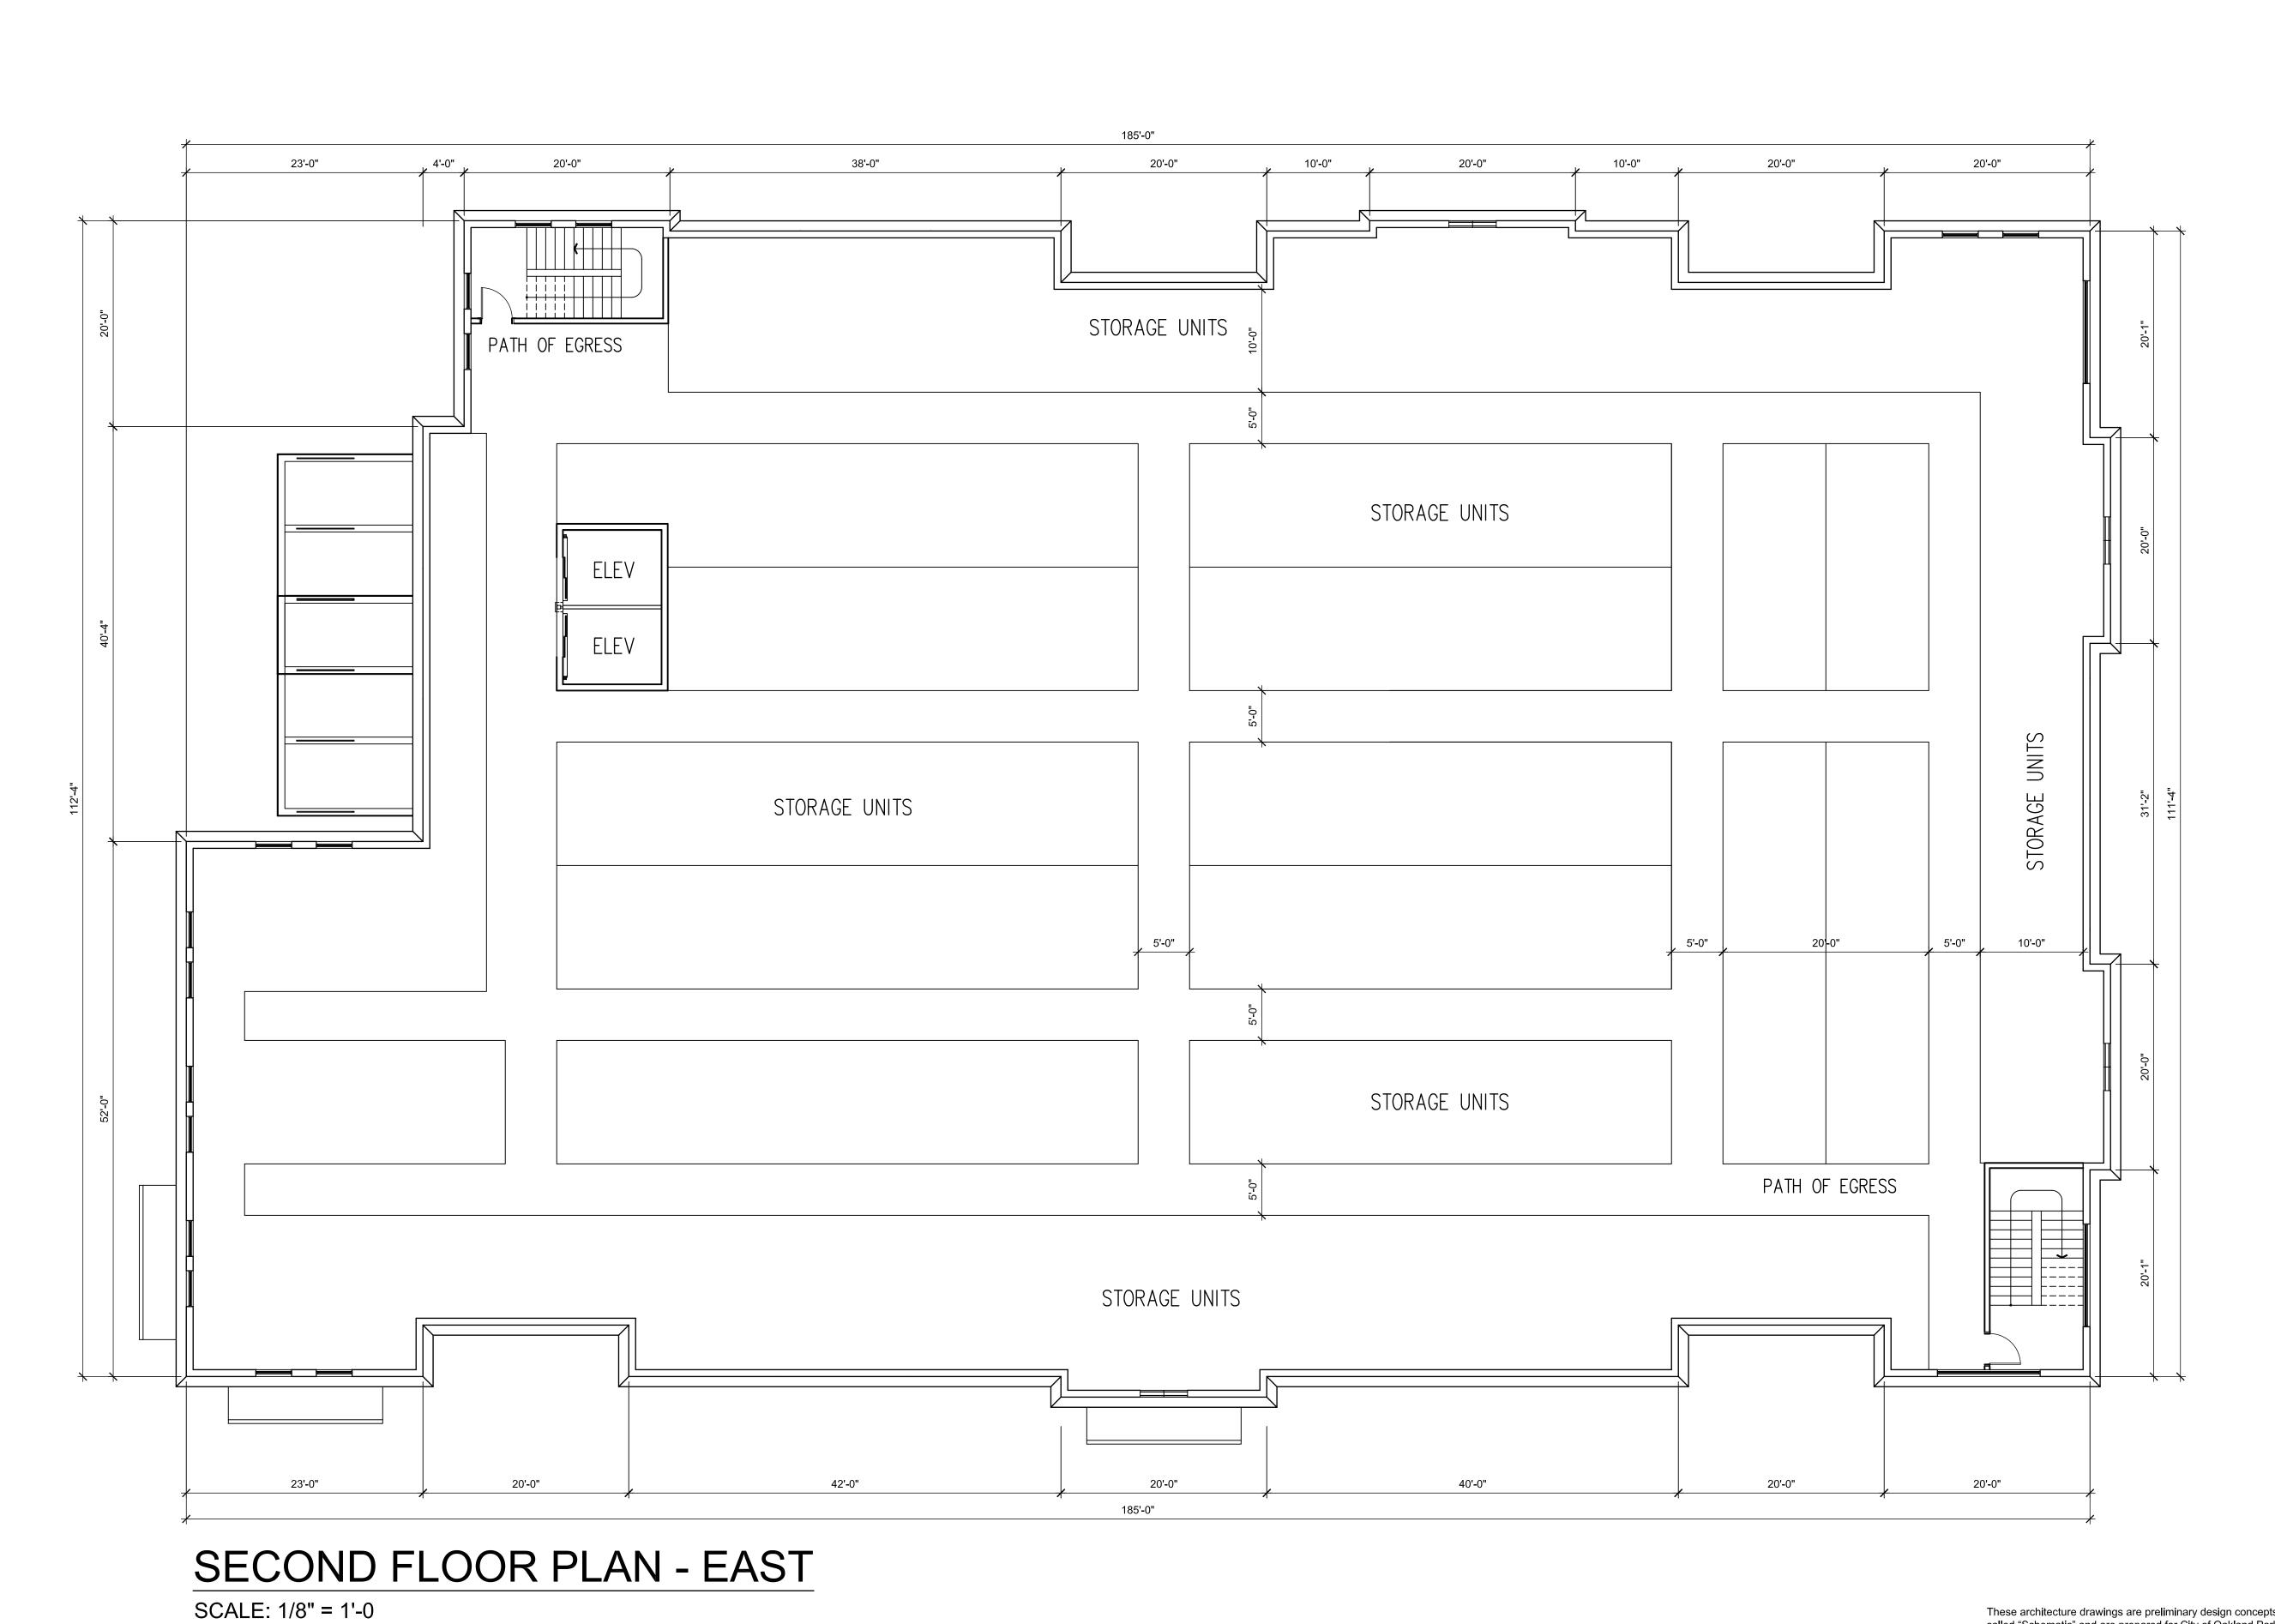

EDWARD DESIGN STUDIOS 28245 Highway 74 Main Street Evergreen, CO 80439 321-271-0748 GoodEdward.com FLOOR PLAN - EAST LEVEL 2 EAST 8/4/19

These architecture drawings are preliminary design concepts, herein called "Schematic" and are prepared for City of Oakland Park approvals. Once approvals are received, the architect and engineer will complete the architectural and engineering as required, but will maintain the Schematic design concept as presented herein. This design may be required to have modifications to meet: a.) local zoning ordinances, b.) any and all local, state and federal building requirements, and codes c.) local, state and federal ADA requirements, d.) local, state and federal structural requirements.

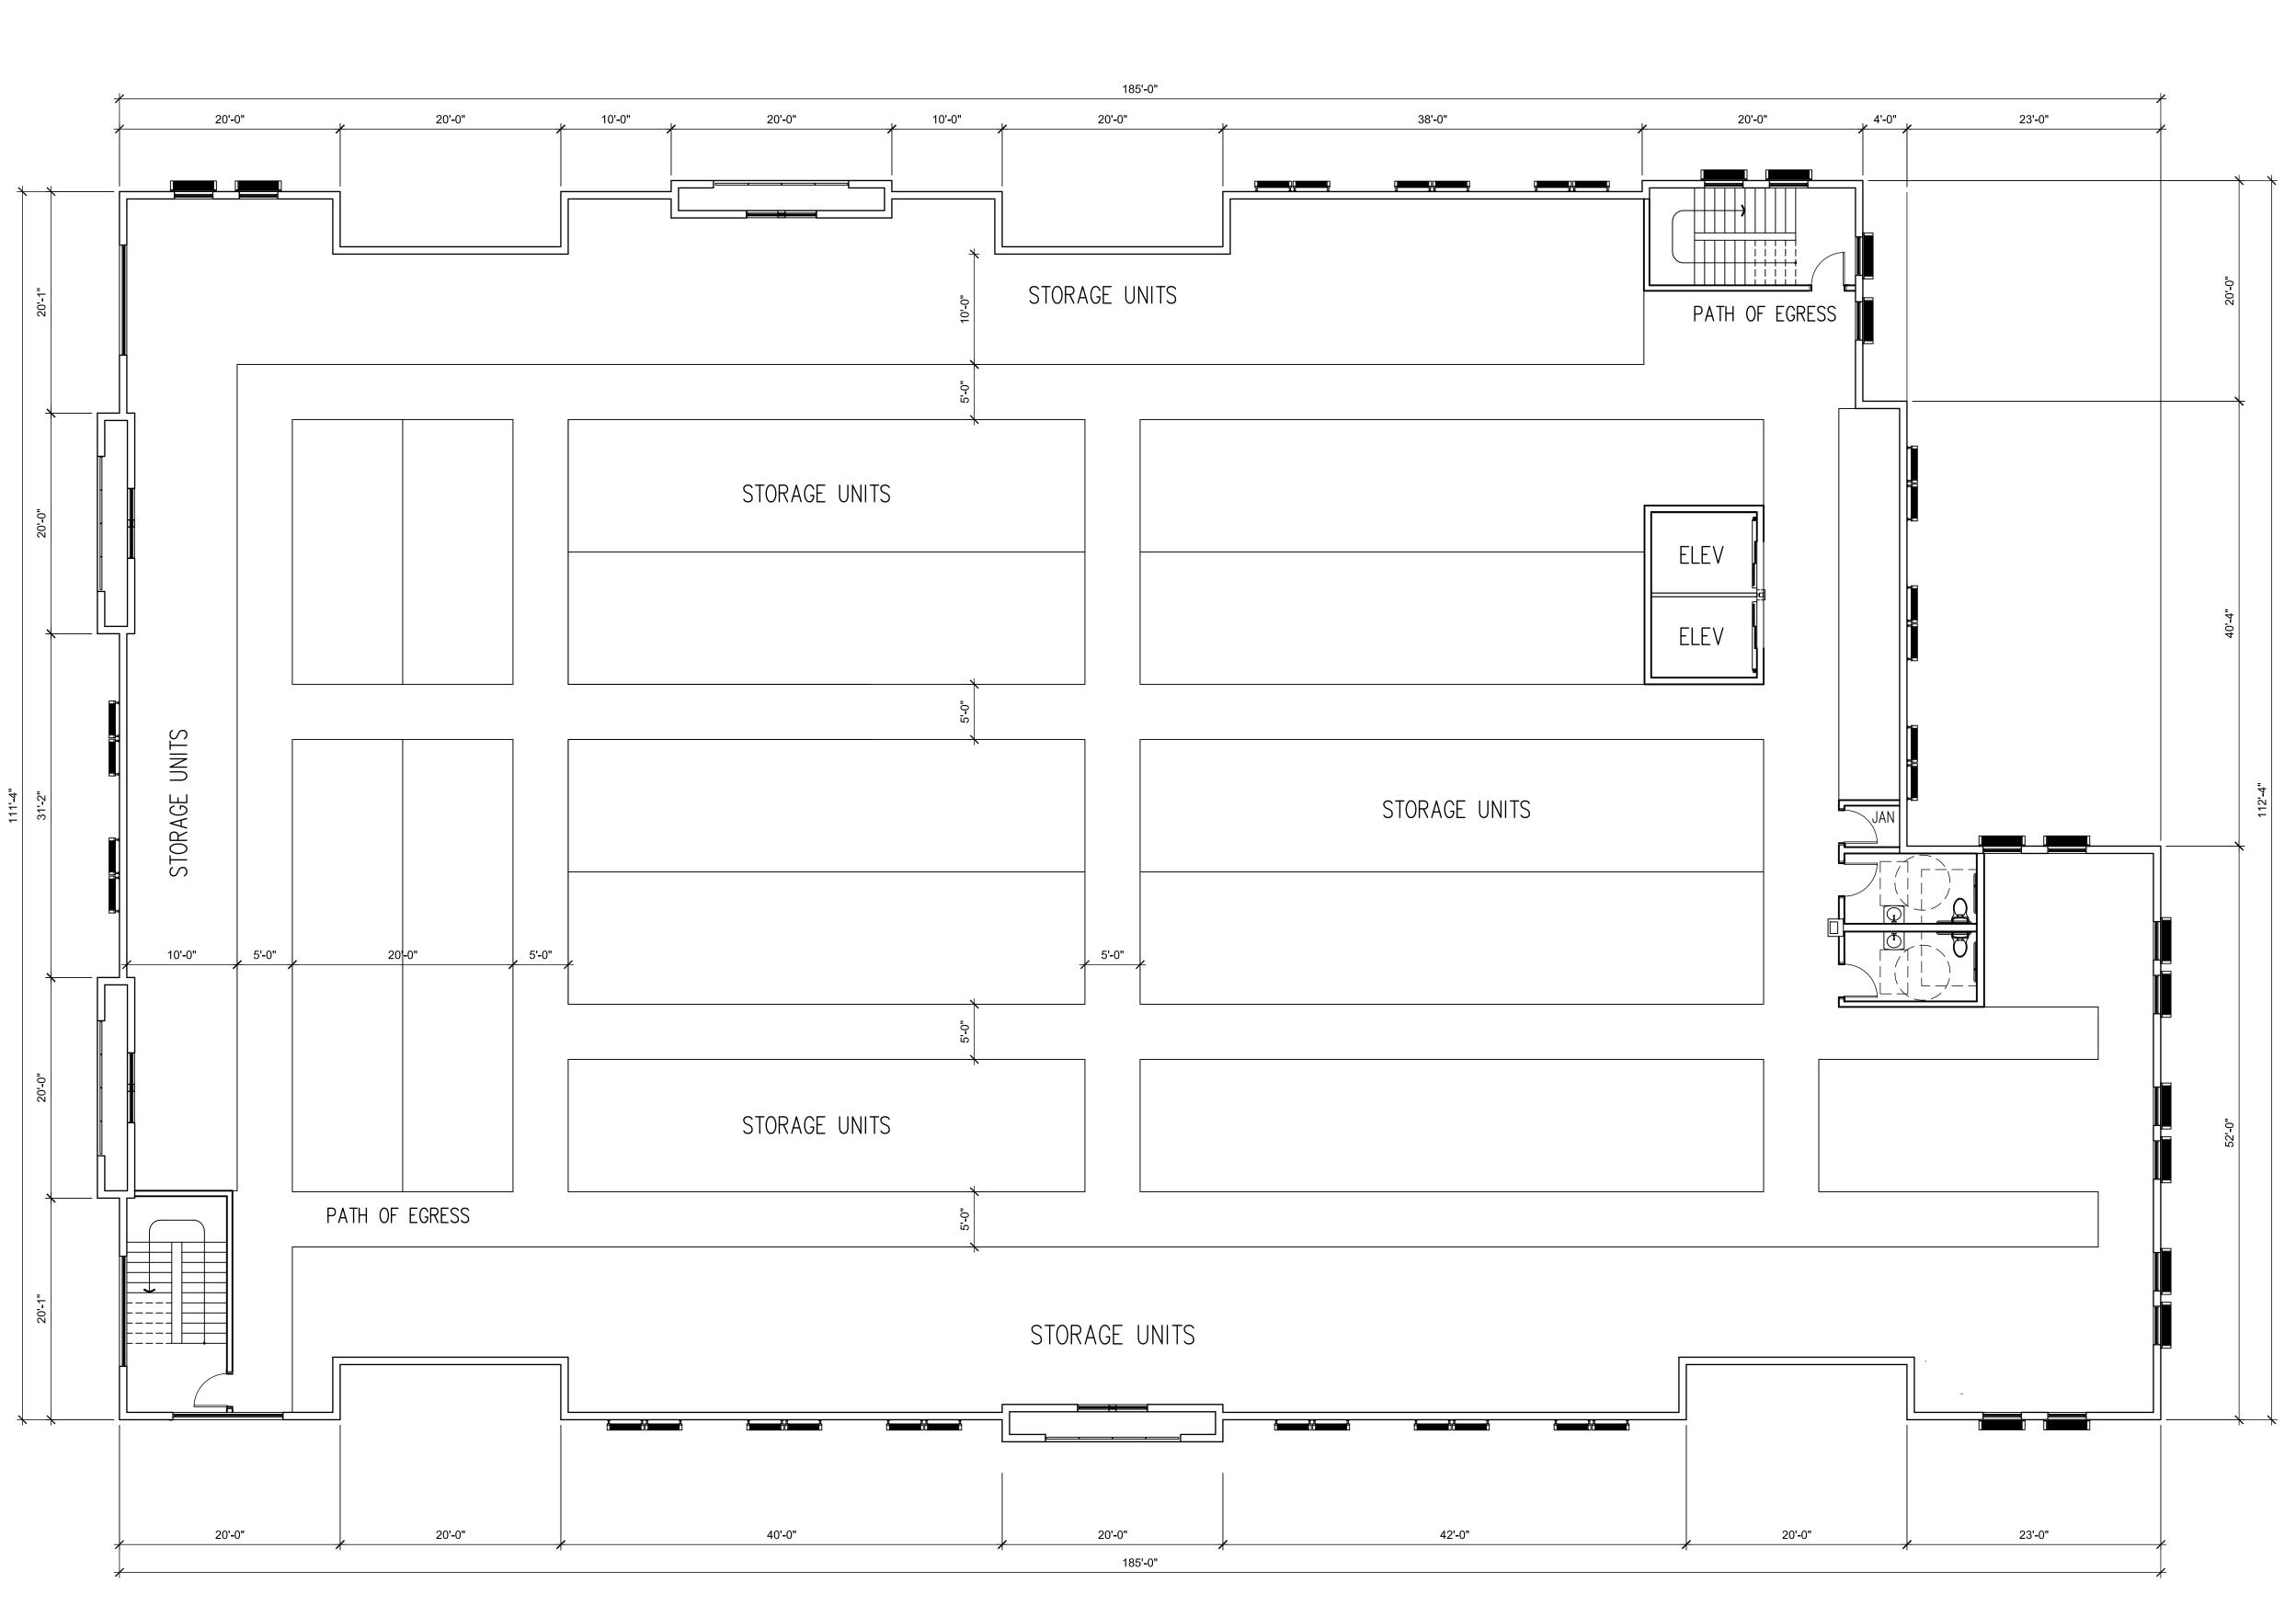


THIRD FLOOR PLAN - WEST

SCALE: 1/8" = 1'-0

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FLOOR PLAN LEVEL 3 WEST

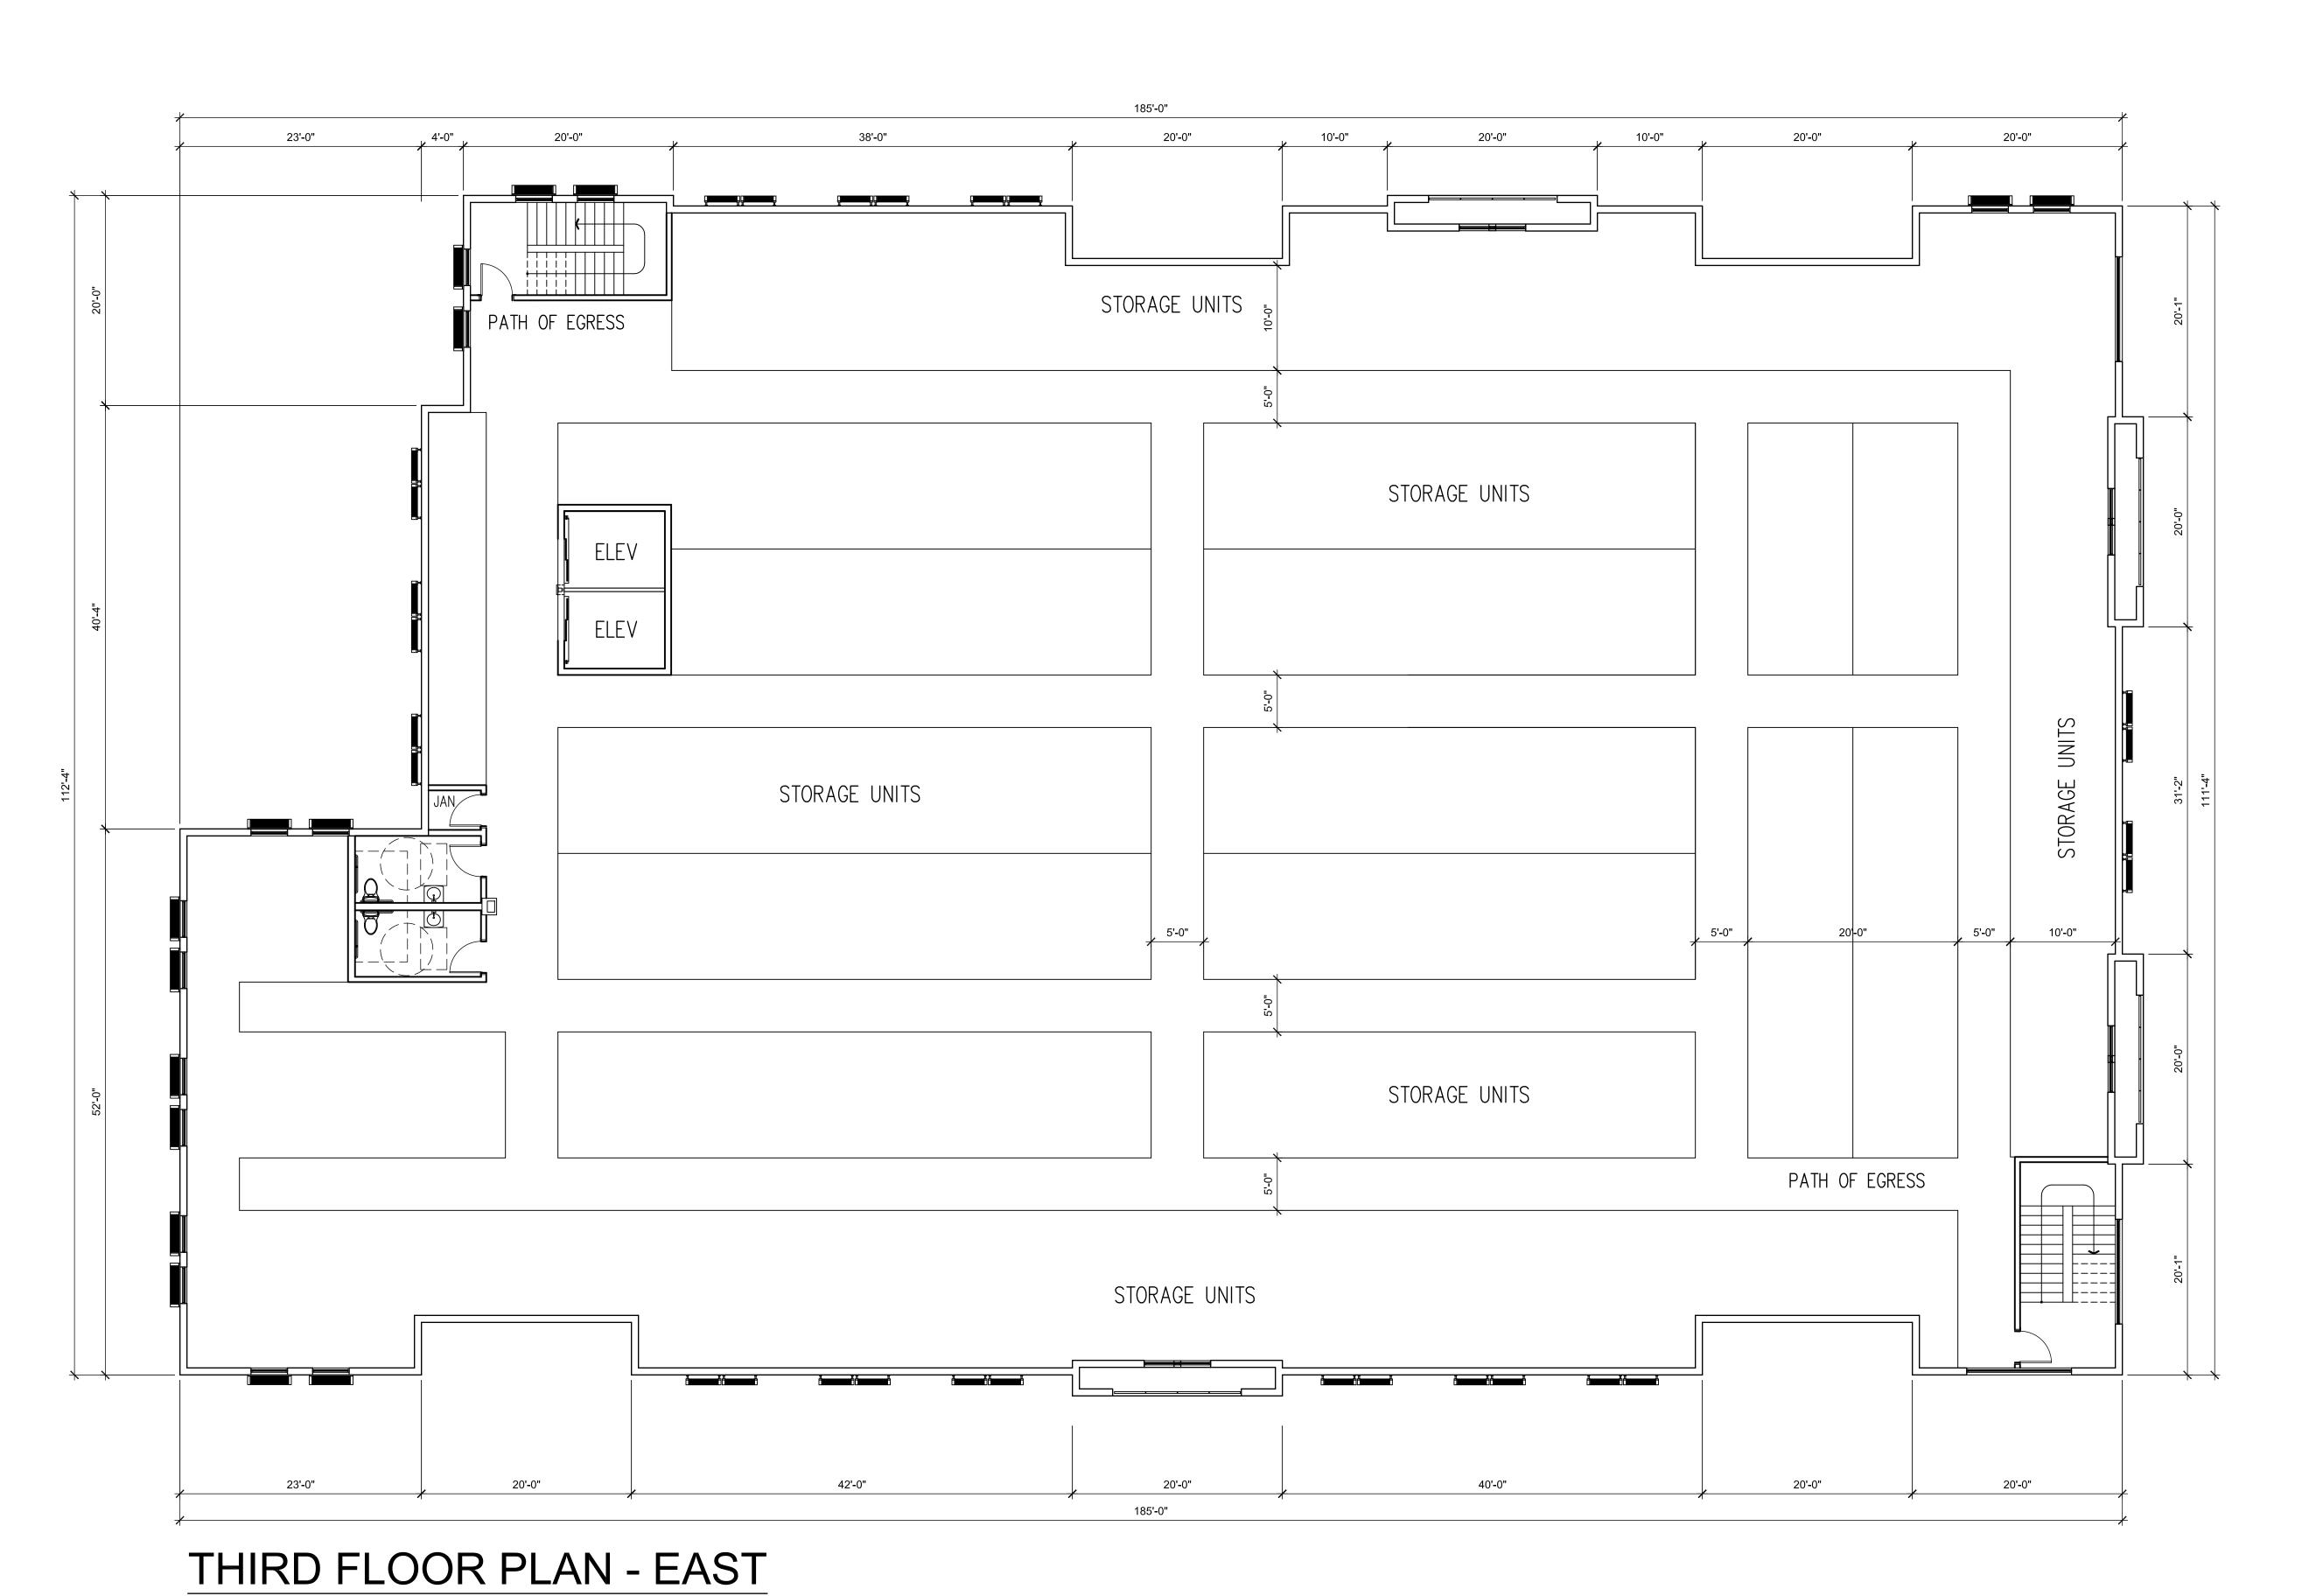

SCALE: 1/8" = 1'-0


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FLOOR PLAN - EAST LEVEL 3 EAST



ROOF PLAN - WEST

SCALE: 1/8" = 1'-0

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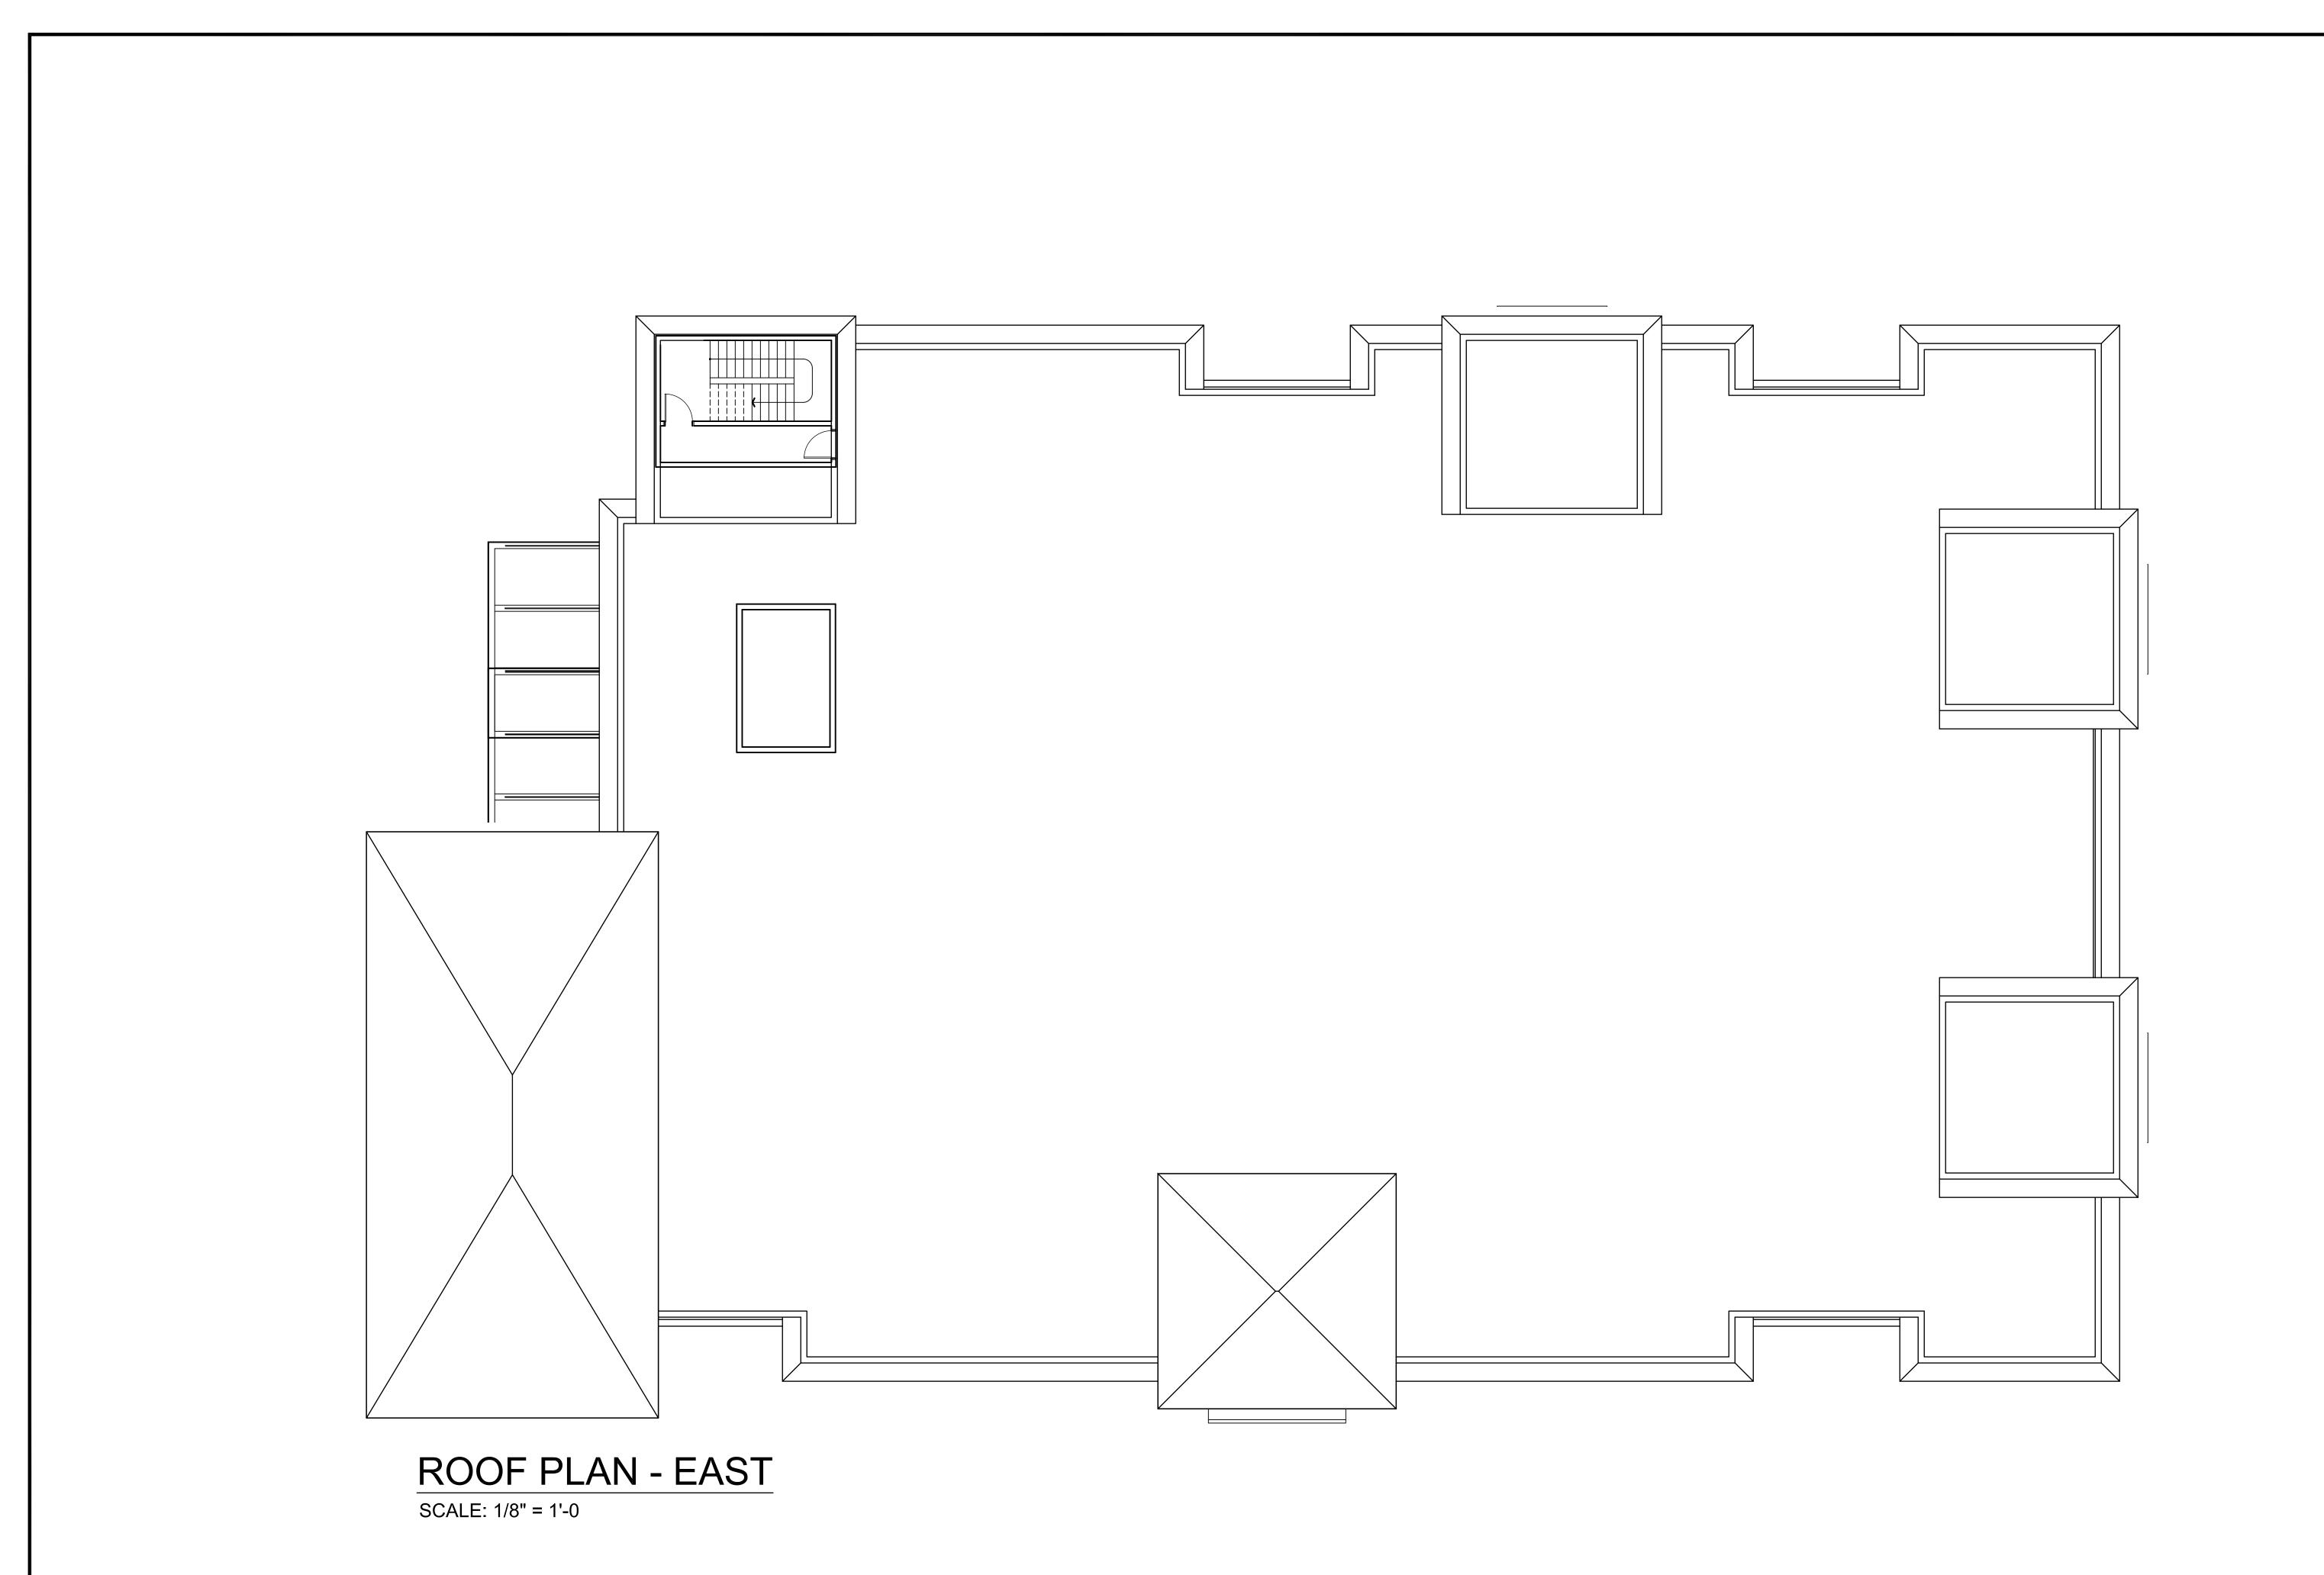
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ROOF Plans and Project SAFE & SECURE SELF-STOR.

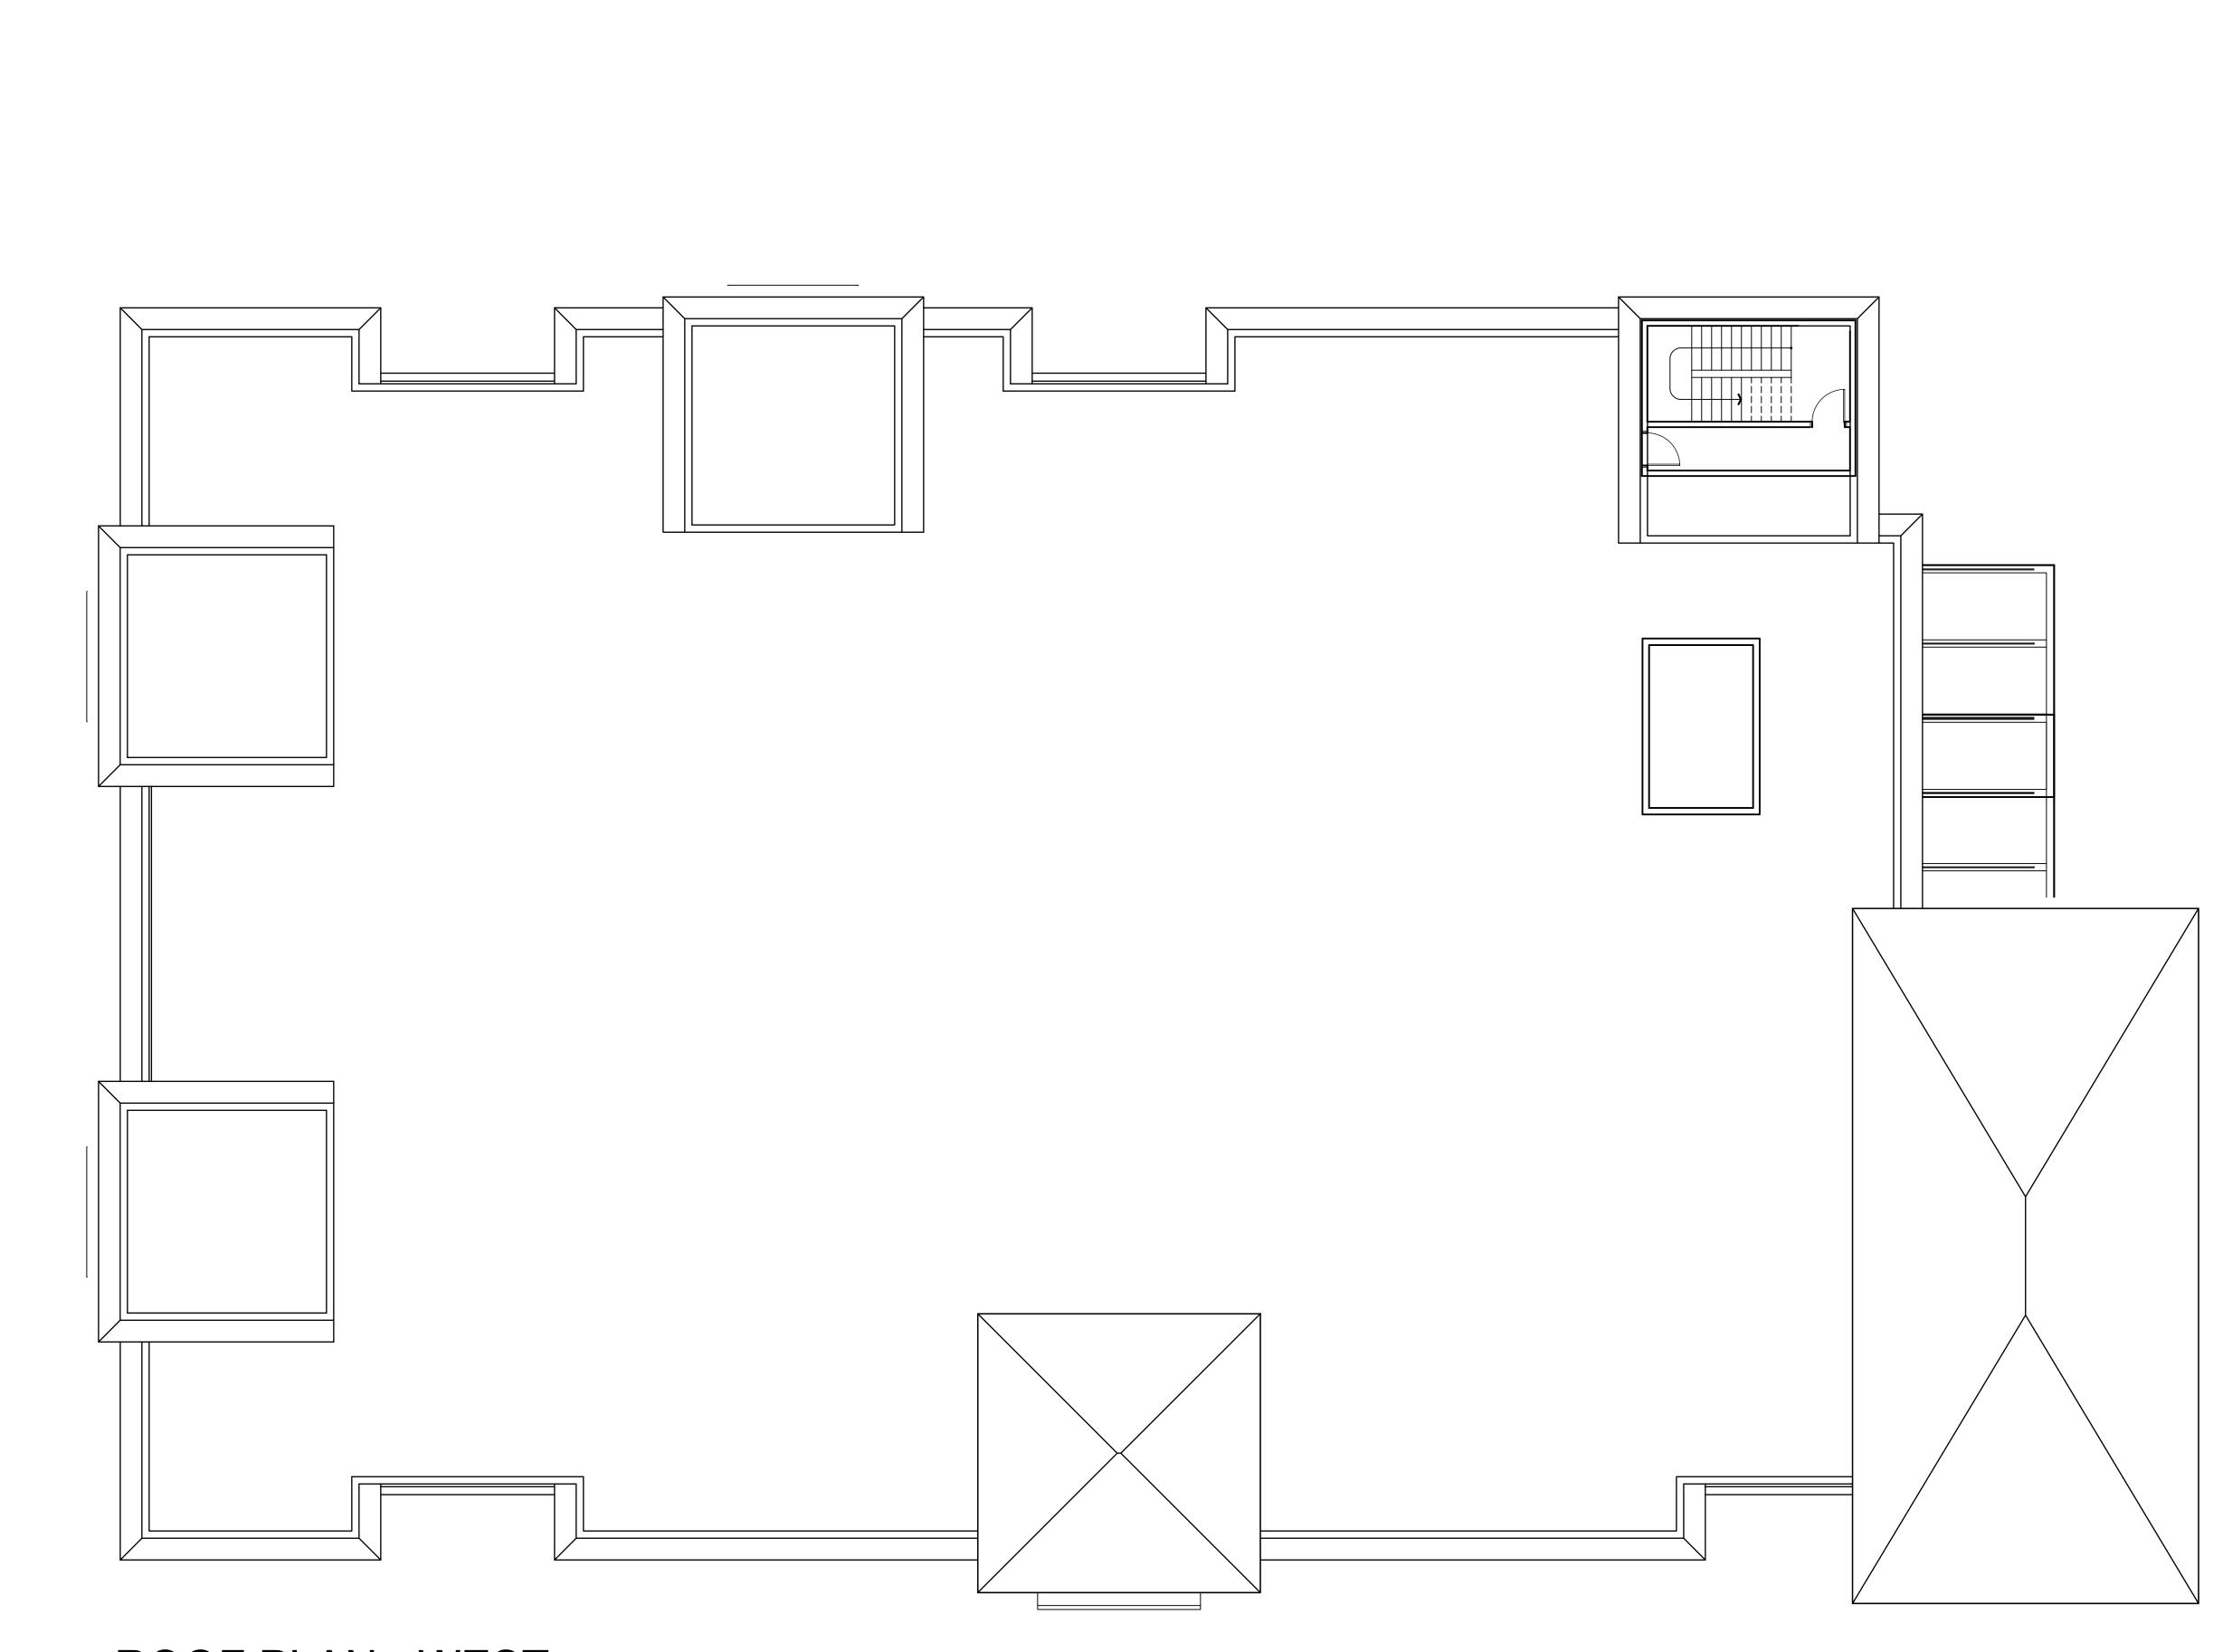Scale
1/8" = 1'-0"

Date
8/4/19

Sheet No.



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Revisions									
Ву									
Date									
Symbol									
Studi prope afore firm o	os cor erty of mention or orga	ncepts, Good oned sl onizatio	ideas, & Edwa nall be on for a	, plans ard De used l any pu	and de sign Si oy or d rpose v	etails a tudios. isclose vithou	re the None ed to a t the p	sole of the ny per:	son,
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	Symbol Date By	This is an o Studios corproperty of aforementic firm or orga permission	This is an original Studios concepts, property of Good aforementioned stifirm or organizatic permission of Good	This is an original design Studios concepts, ideas property of Good & Edwards aforementioned shall be firm or organization for a permission of Good & Edwards and the state of	This is an original design, crea Studios concepts, ideas, plans property of Good & Edward De aforementioned shall be used if firm or organization for any pur permission of Good & Edward	This is an original design, created by Studios concepts, ideas, plans and deproperty of Good & Edward Design aforementioned shall be used by or dirm or organization for any purpose permission of Good & Edward Design AR95565	This is an original design, created by Good Studios concepts, ideas, plans and details a property of Good & Edward Design Studios. aforementioned shall be used by or discloss firm or organization for any purpose withou permission of Good & Edward Design Studio. AR95565	This is an original design, created by Good & Edw Studios concepts, ideas, plans and details are the property of Good & Edward Design Studios. None aforementioned shall be used by or disclosed to a firm or organization for any purpose without the ppermission of Good & Edward Design Studios.	This is an original design, created by Good & Edward De Studios concepts, ideas, plans and details are the sole property of Good & Edward Design Studios. None of the aforementioned shall be used by or disclosed to any perfirm or organization for any purpose without the prior wr permission of Good & Edward Design Studios.





28245 Highway 74 Main Street Evergreen, CO 80439

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ROOF PLAN

E & SECURE SELF-STORAGE at OAKLAND PARK



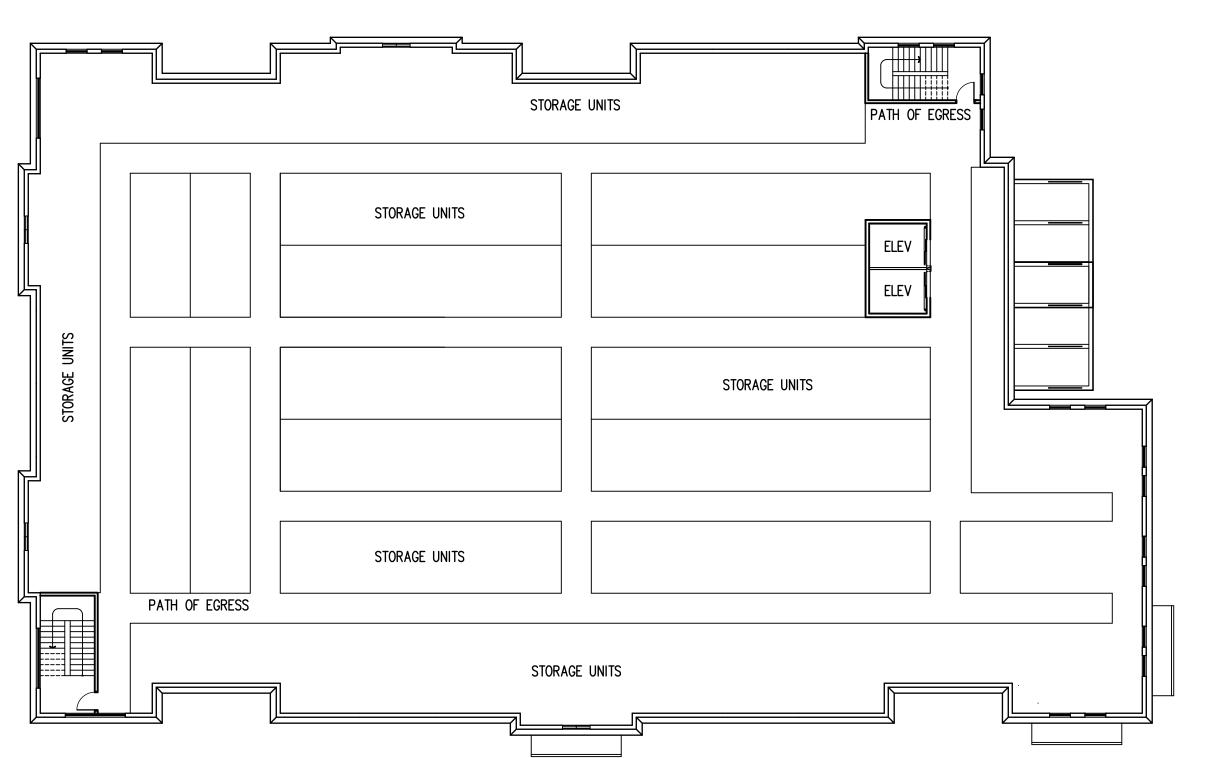

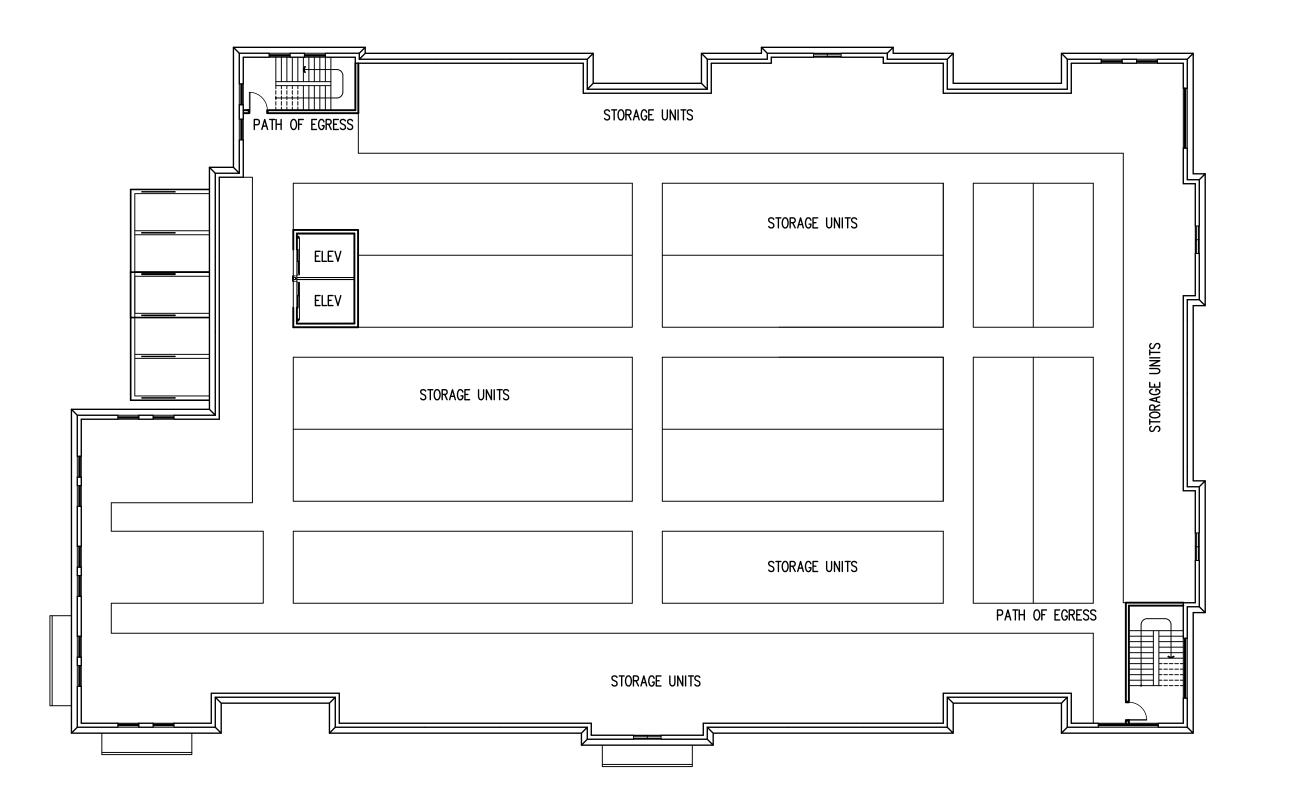firm or organization for any purpose without the prior writte permission of Good & Edward Design Studios.

DESIGN STUDIOS

28245 Highway 74 Main Street Evergreen, CO 80439


321-271-0748 GoodEdward.com

> 2 PLAN GROUND FLOOR PLAN & LEVEL **COMBINED PLANS**

1/16" = 1'-0" 8/4/19

LEVEL 2 FLOOR PLAN


SCALE: 1/16" = 1'-0

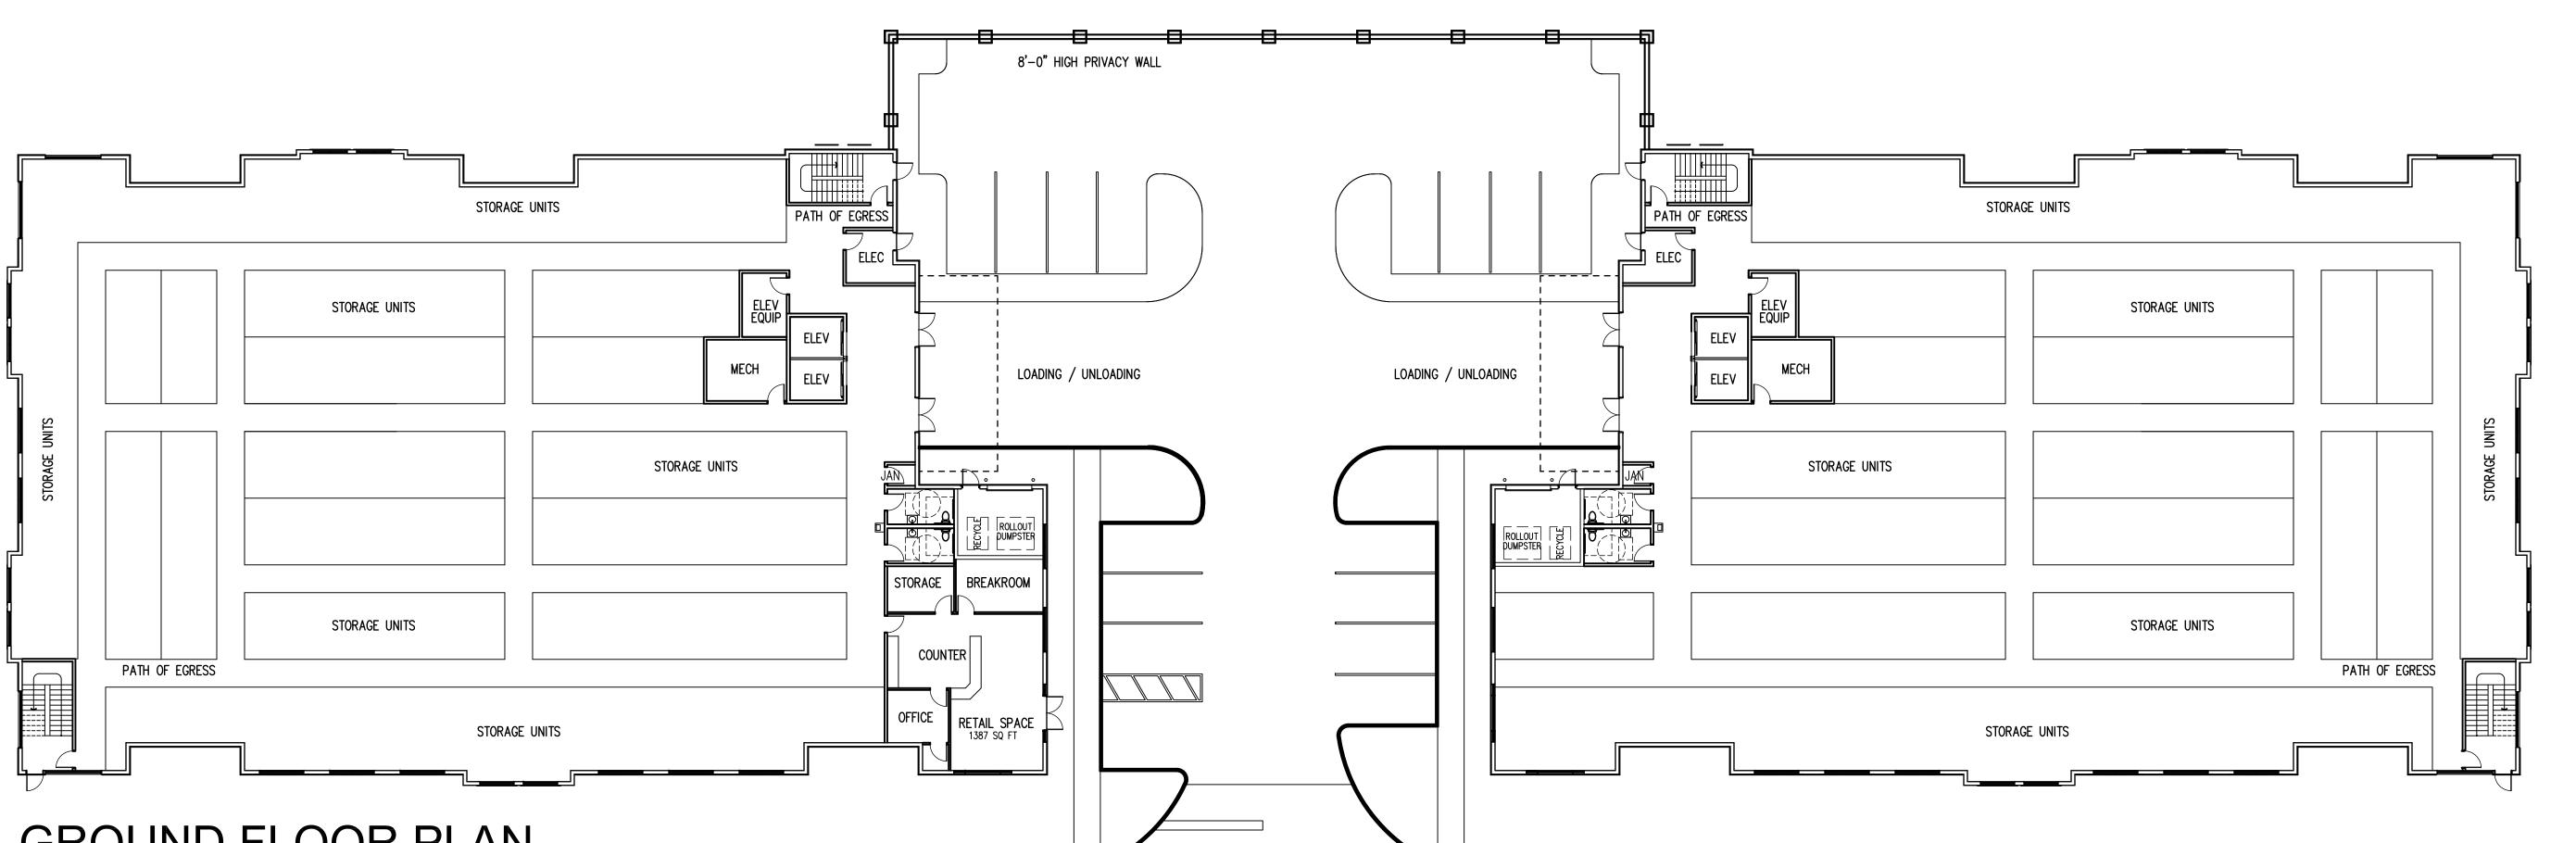


GROUND FLOOR PLAN

SCALE: 1/16" = 1'-0

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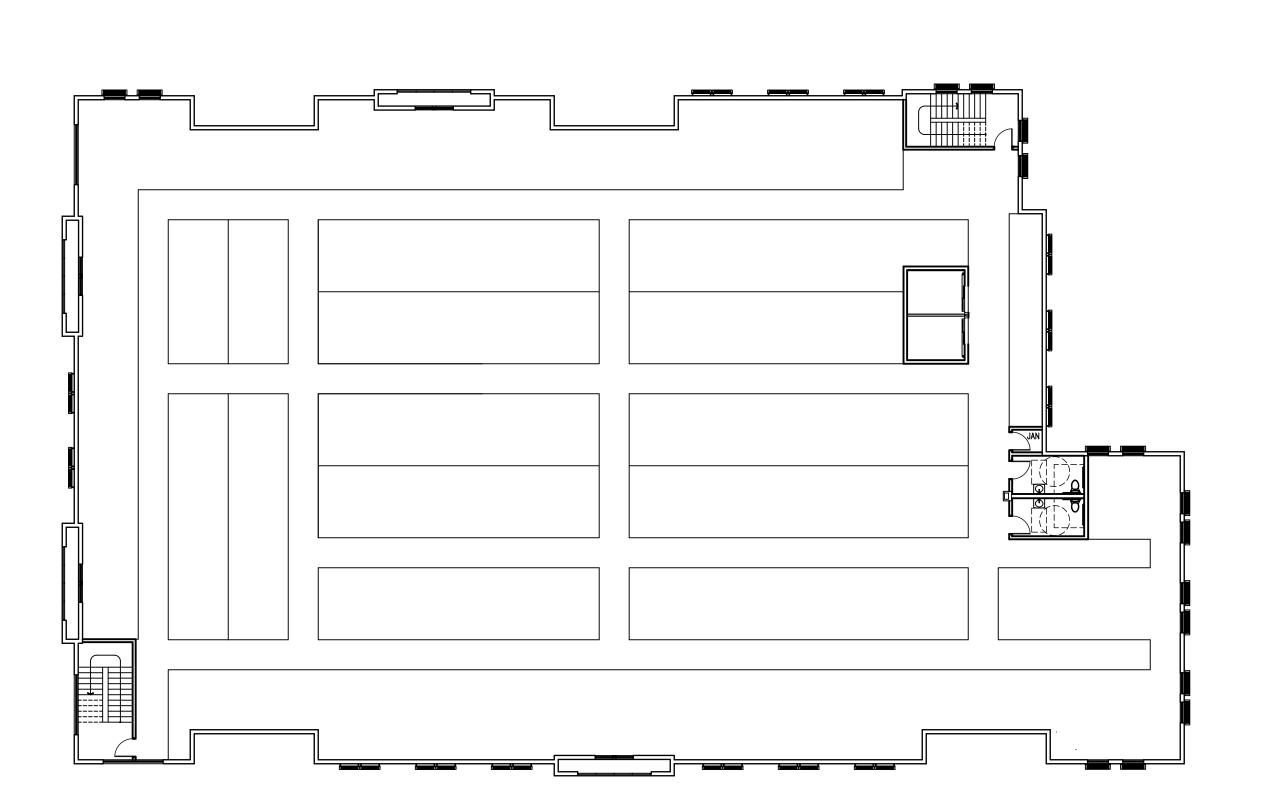


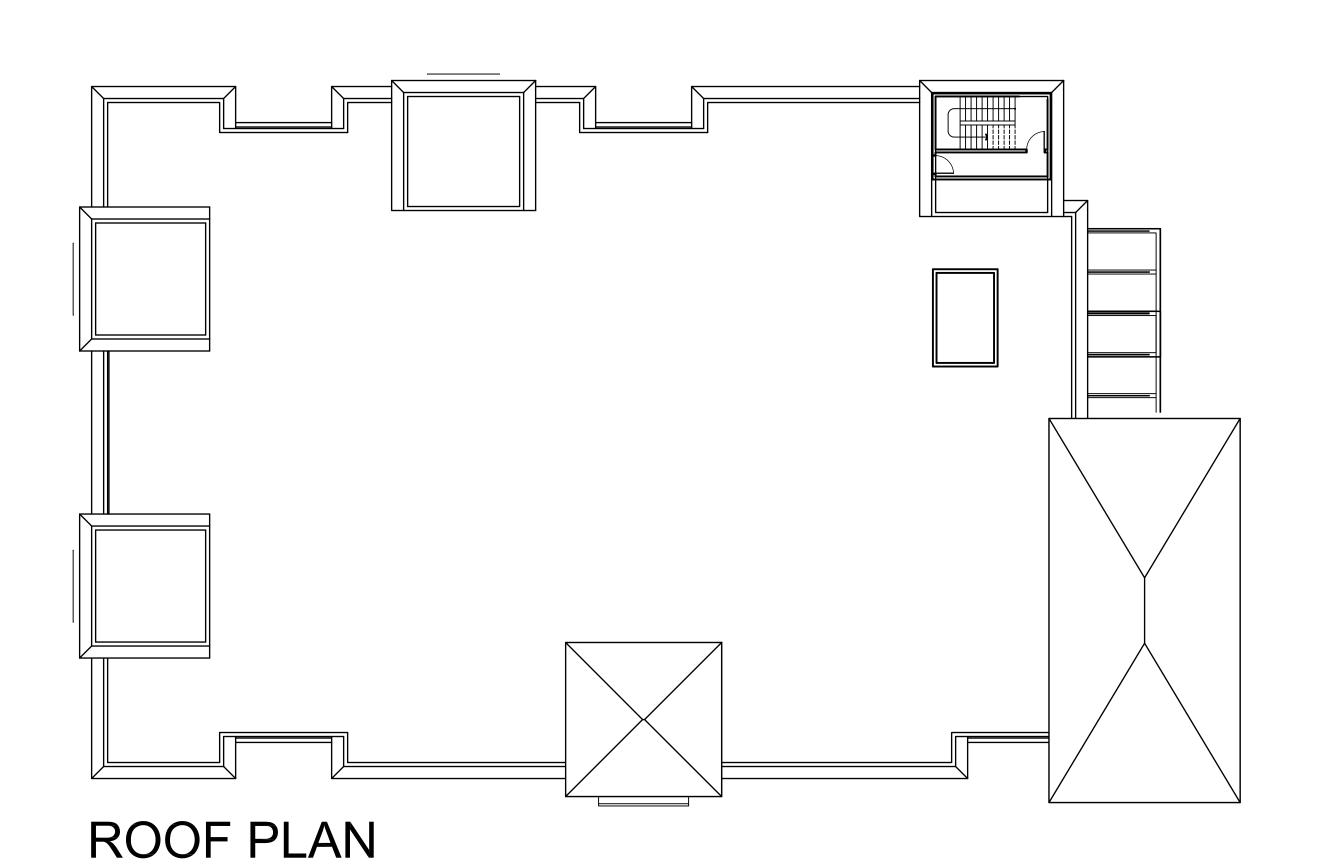28245 Highway 74 Main Street Evergreen, CO 80439

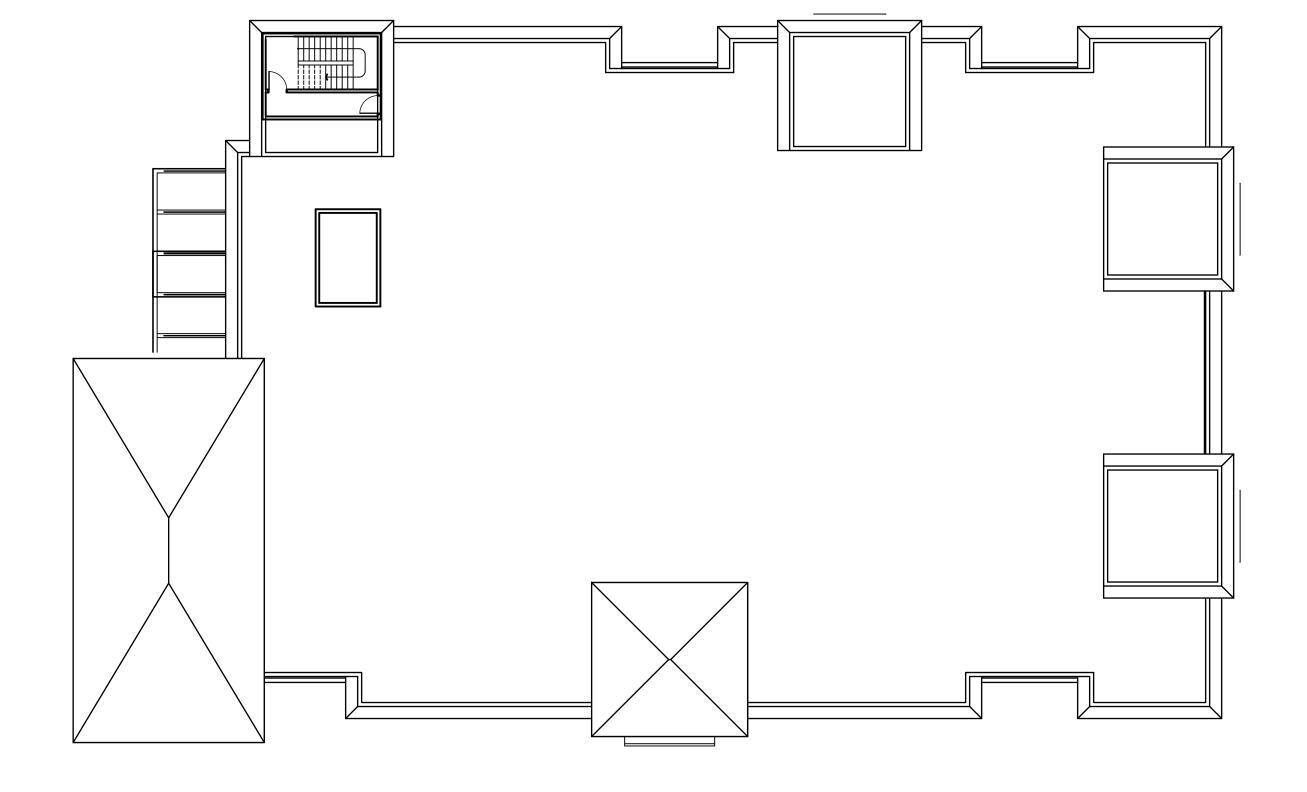321-271-0748 GoodEdward.com

> LEVEL 3 PLAN & ROOF PLAN **COMBINED PLANS**


1/16" = 1'-0" 8/4/19



LEVEL 3 FLOOR PLAN

SCALE: 1/16" = 1'-0

SCALE: 1/16" = 1'-0

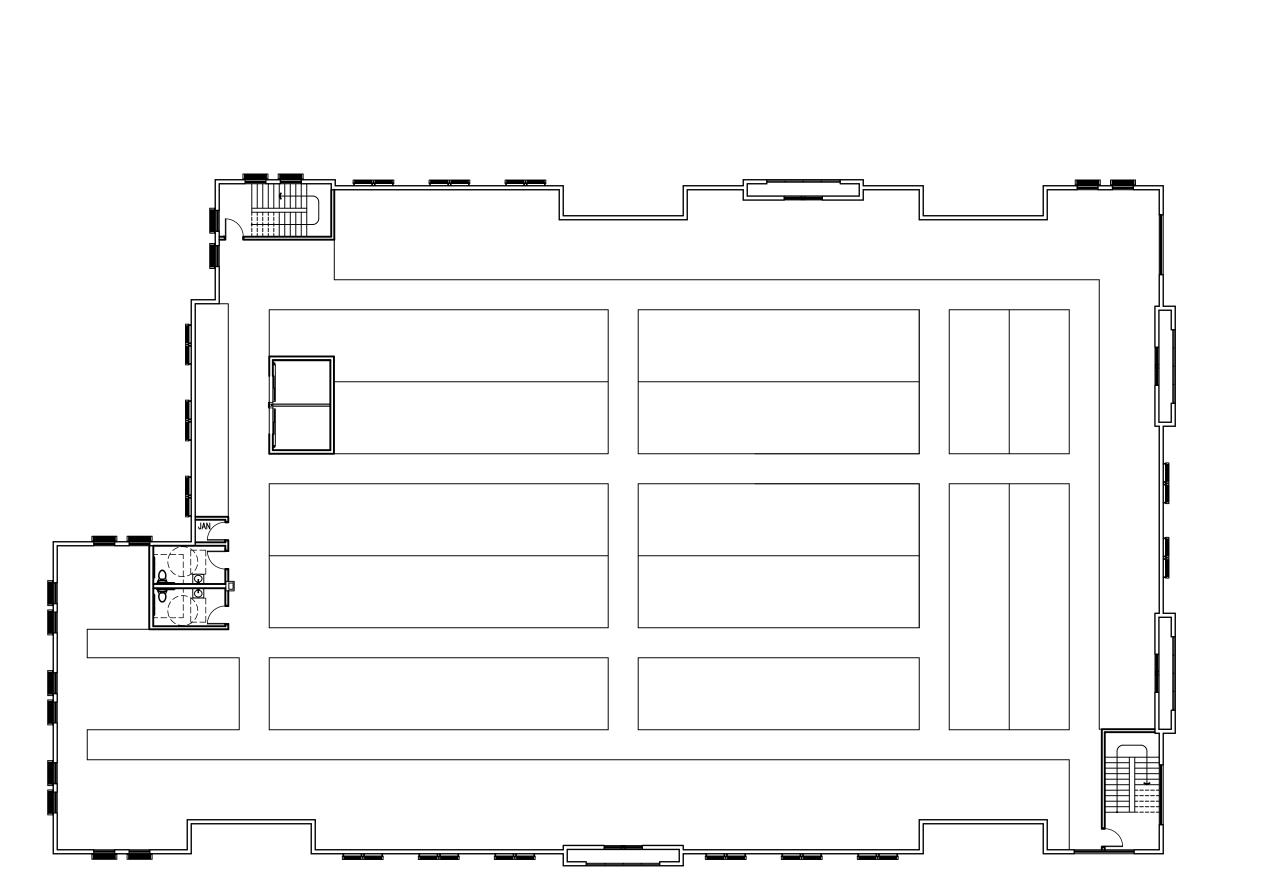

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FRONT (SOUTH) ELEVATION

SCALE: 1/8" = 1'-0 (Oakland Park Blvd)




RIGHT (EAST) ELEVATION

SCALE: 1/8" = 1'-0

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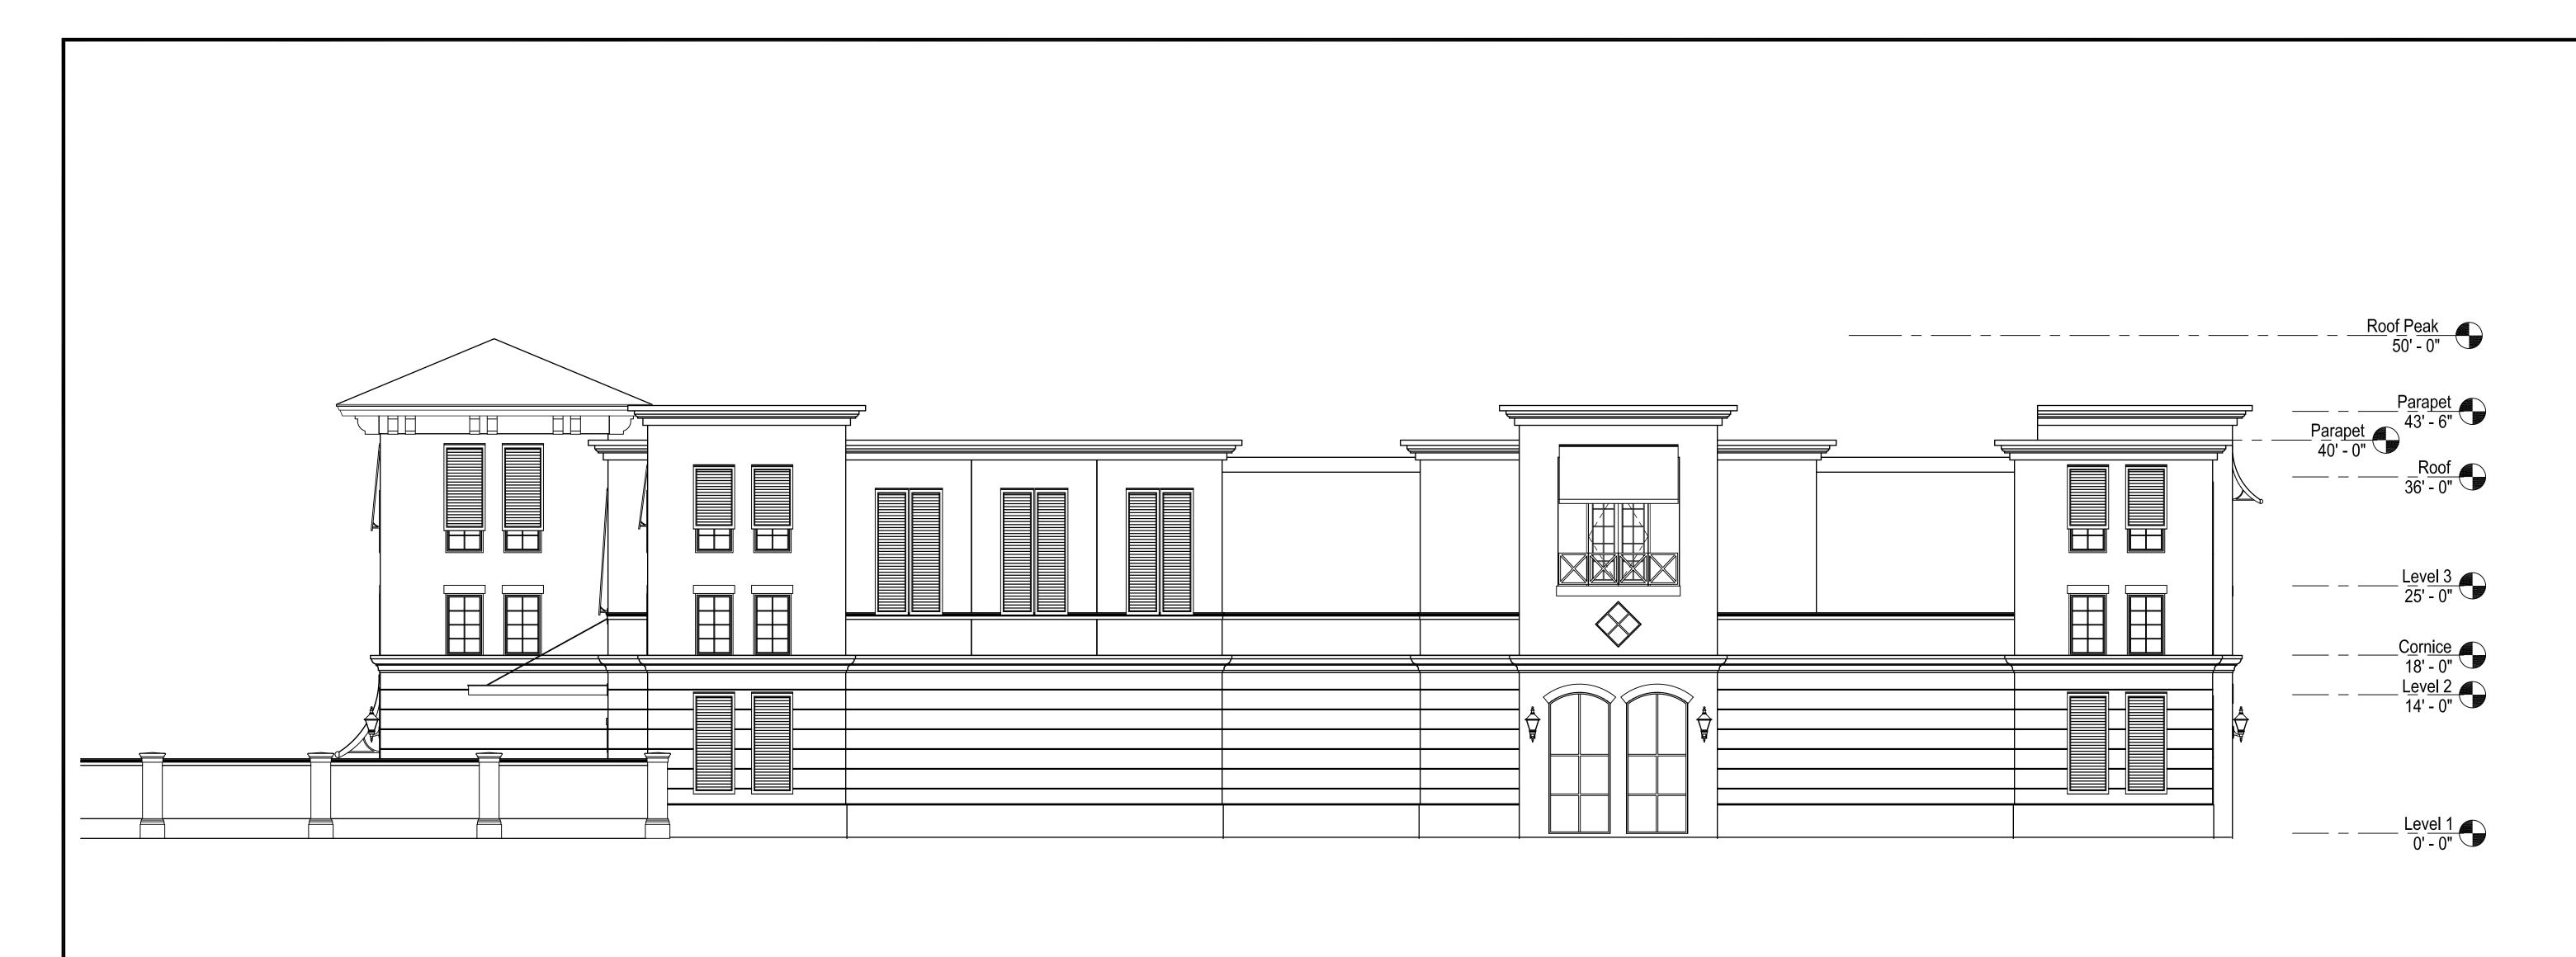
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URE SELF-STORAGE at OAKLAND PARK

ELEVATIONS

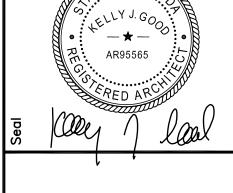




LEFT (WEST) ELEVATION

SCALE: 1/8" = 1'-0 (NW 23rd Terrace)

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By Revisions									
Date									
Symbol									
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URE SELF-STORAGE at OAKLAND PARK


Project SAFF & SECL

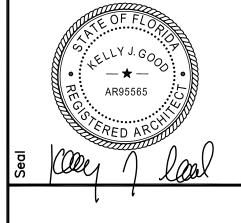ELEVATIONS

Scale Job No.


1/8" = 1'-0" Date Drawn By


8/4/19 Sheet No.

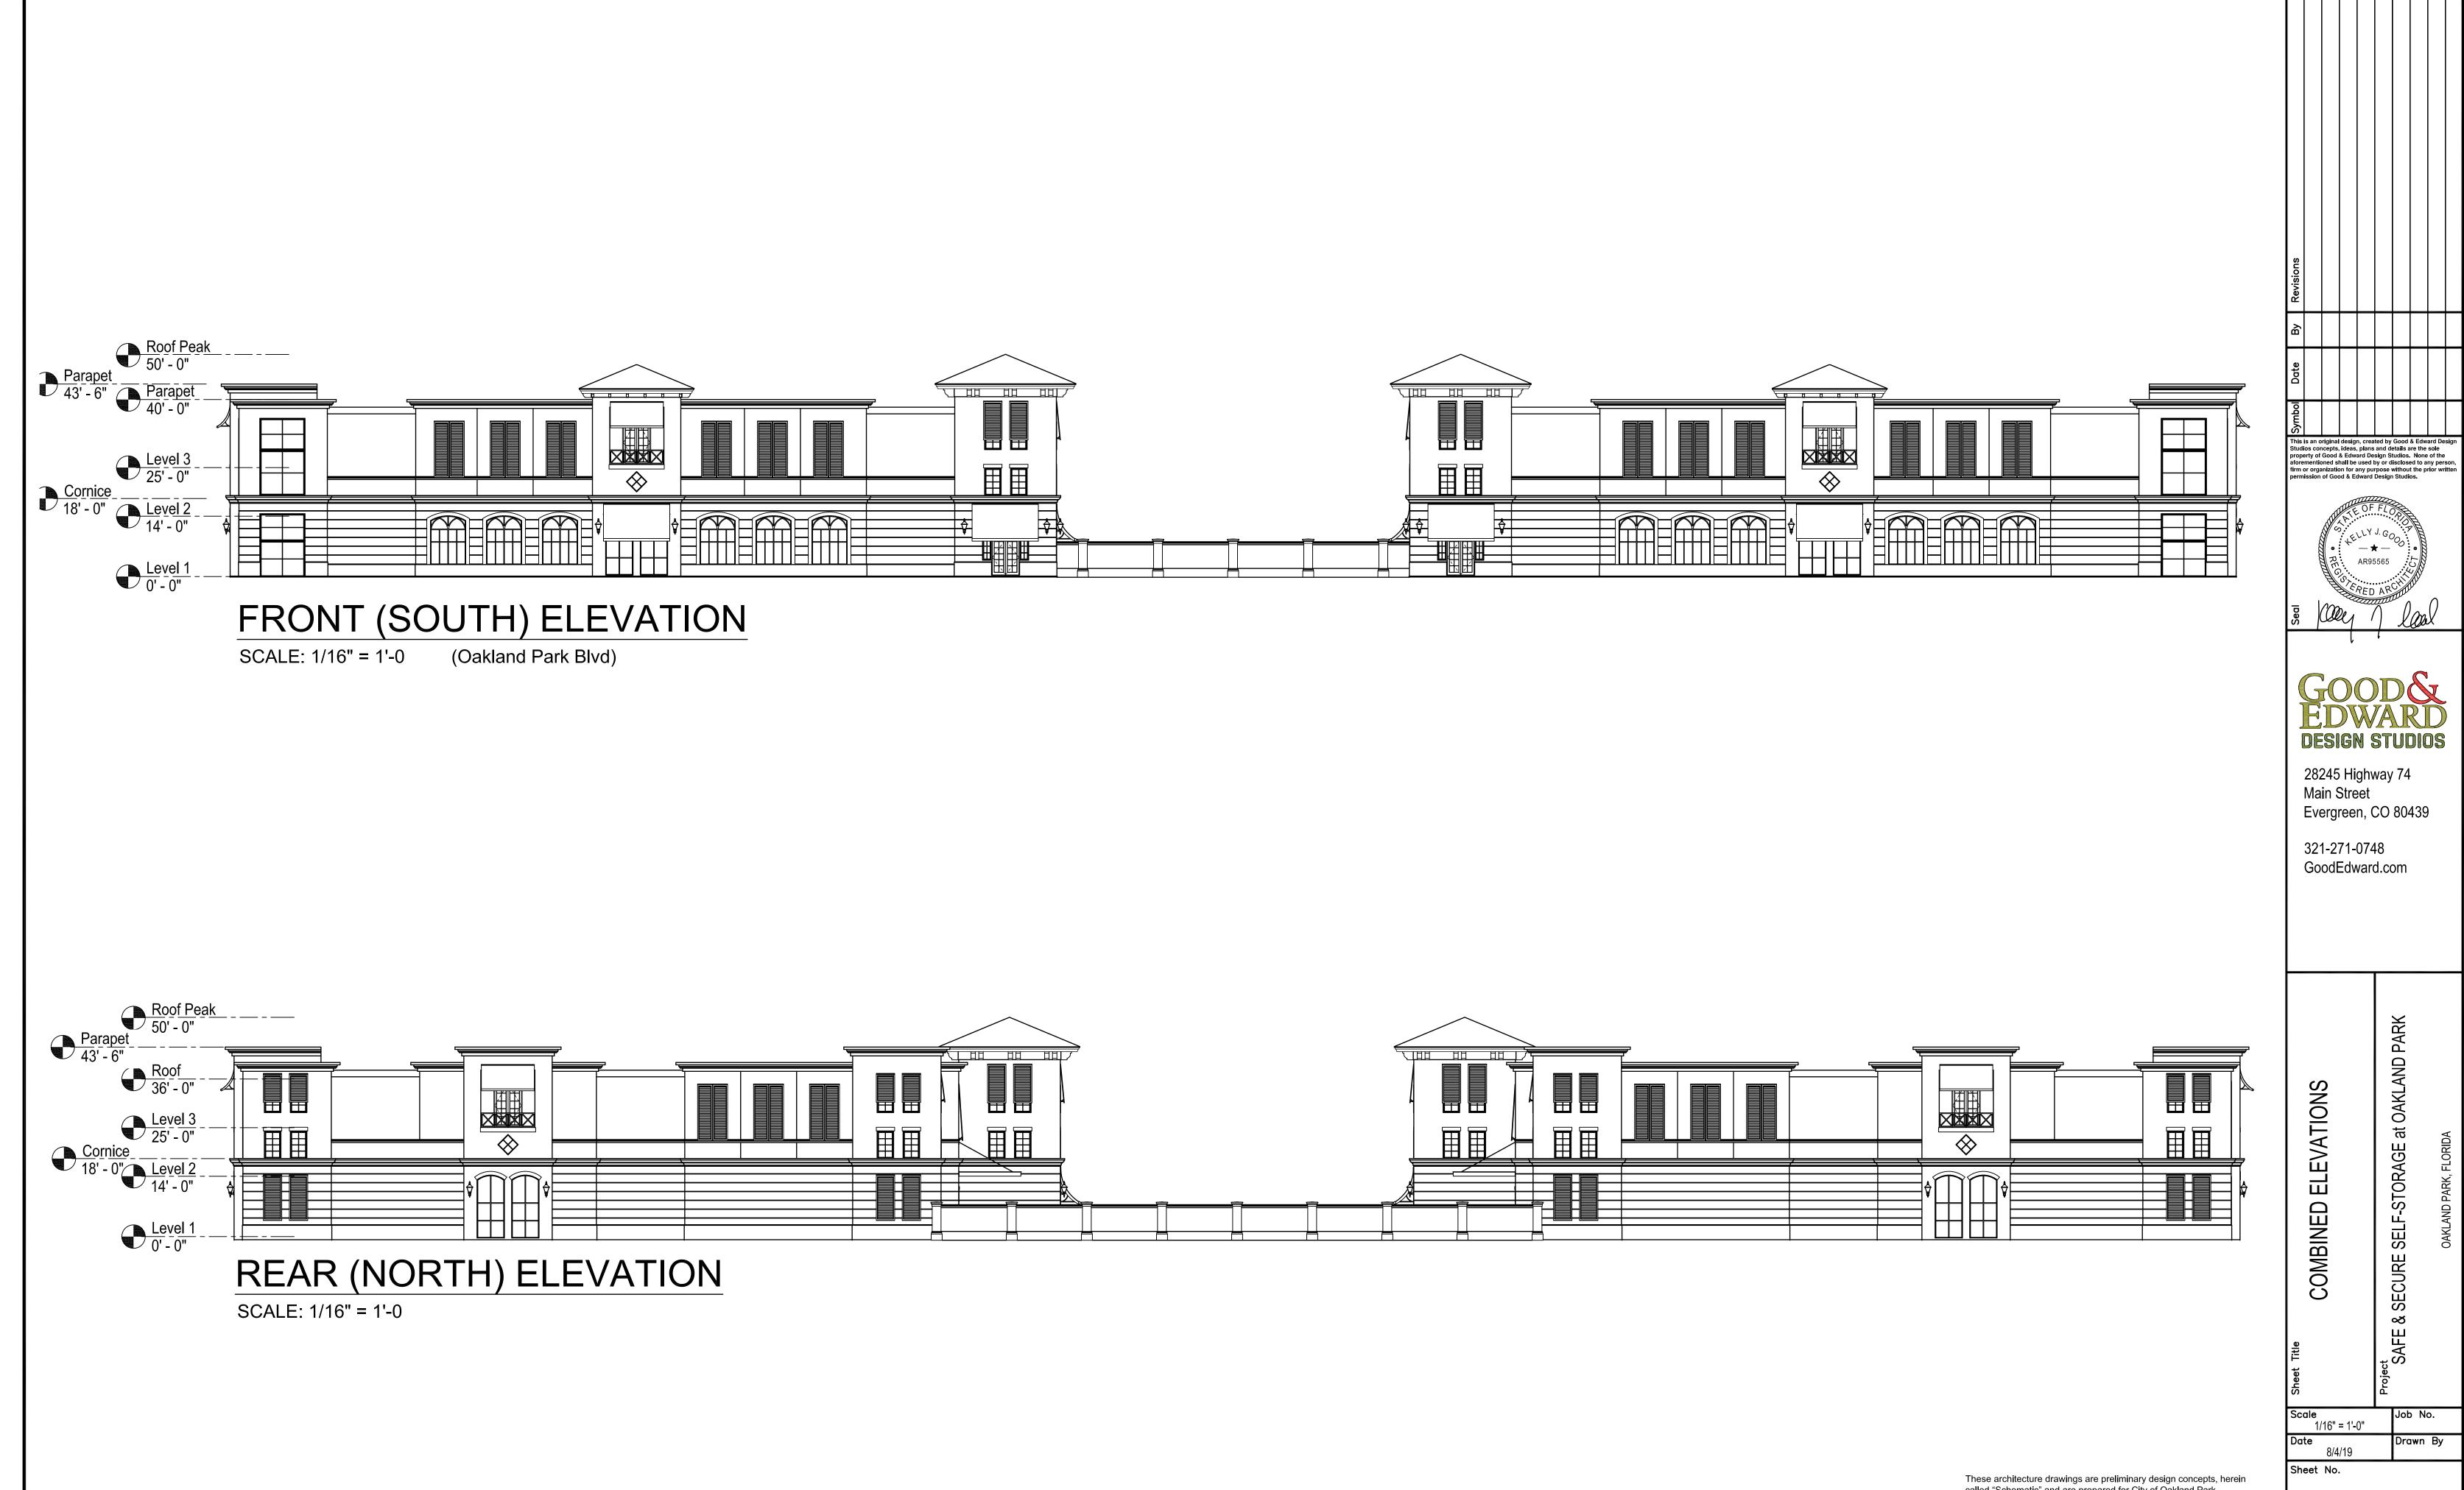

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A1:



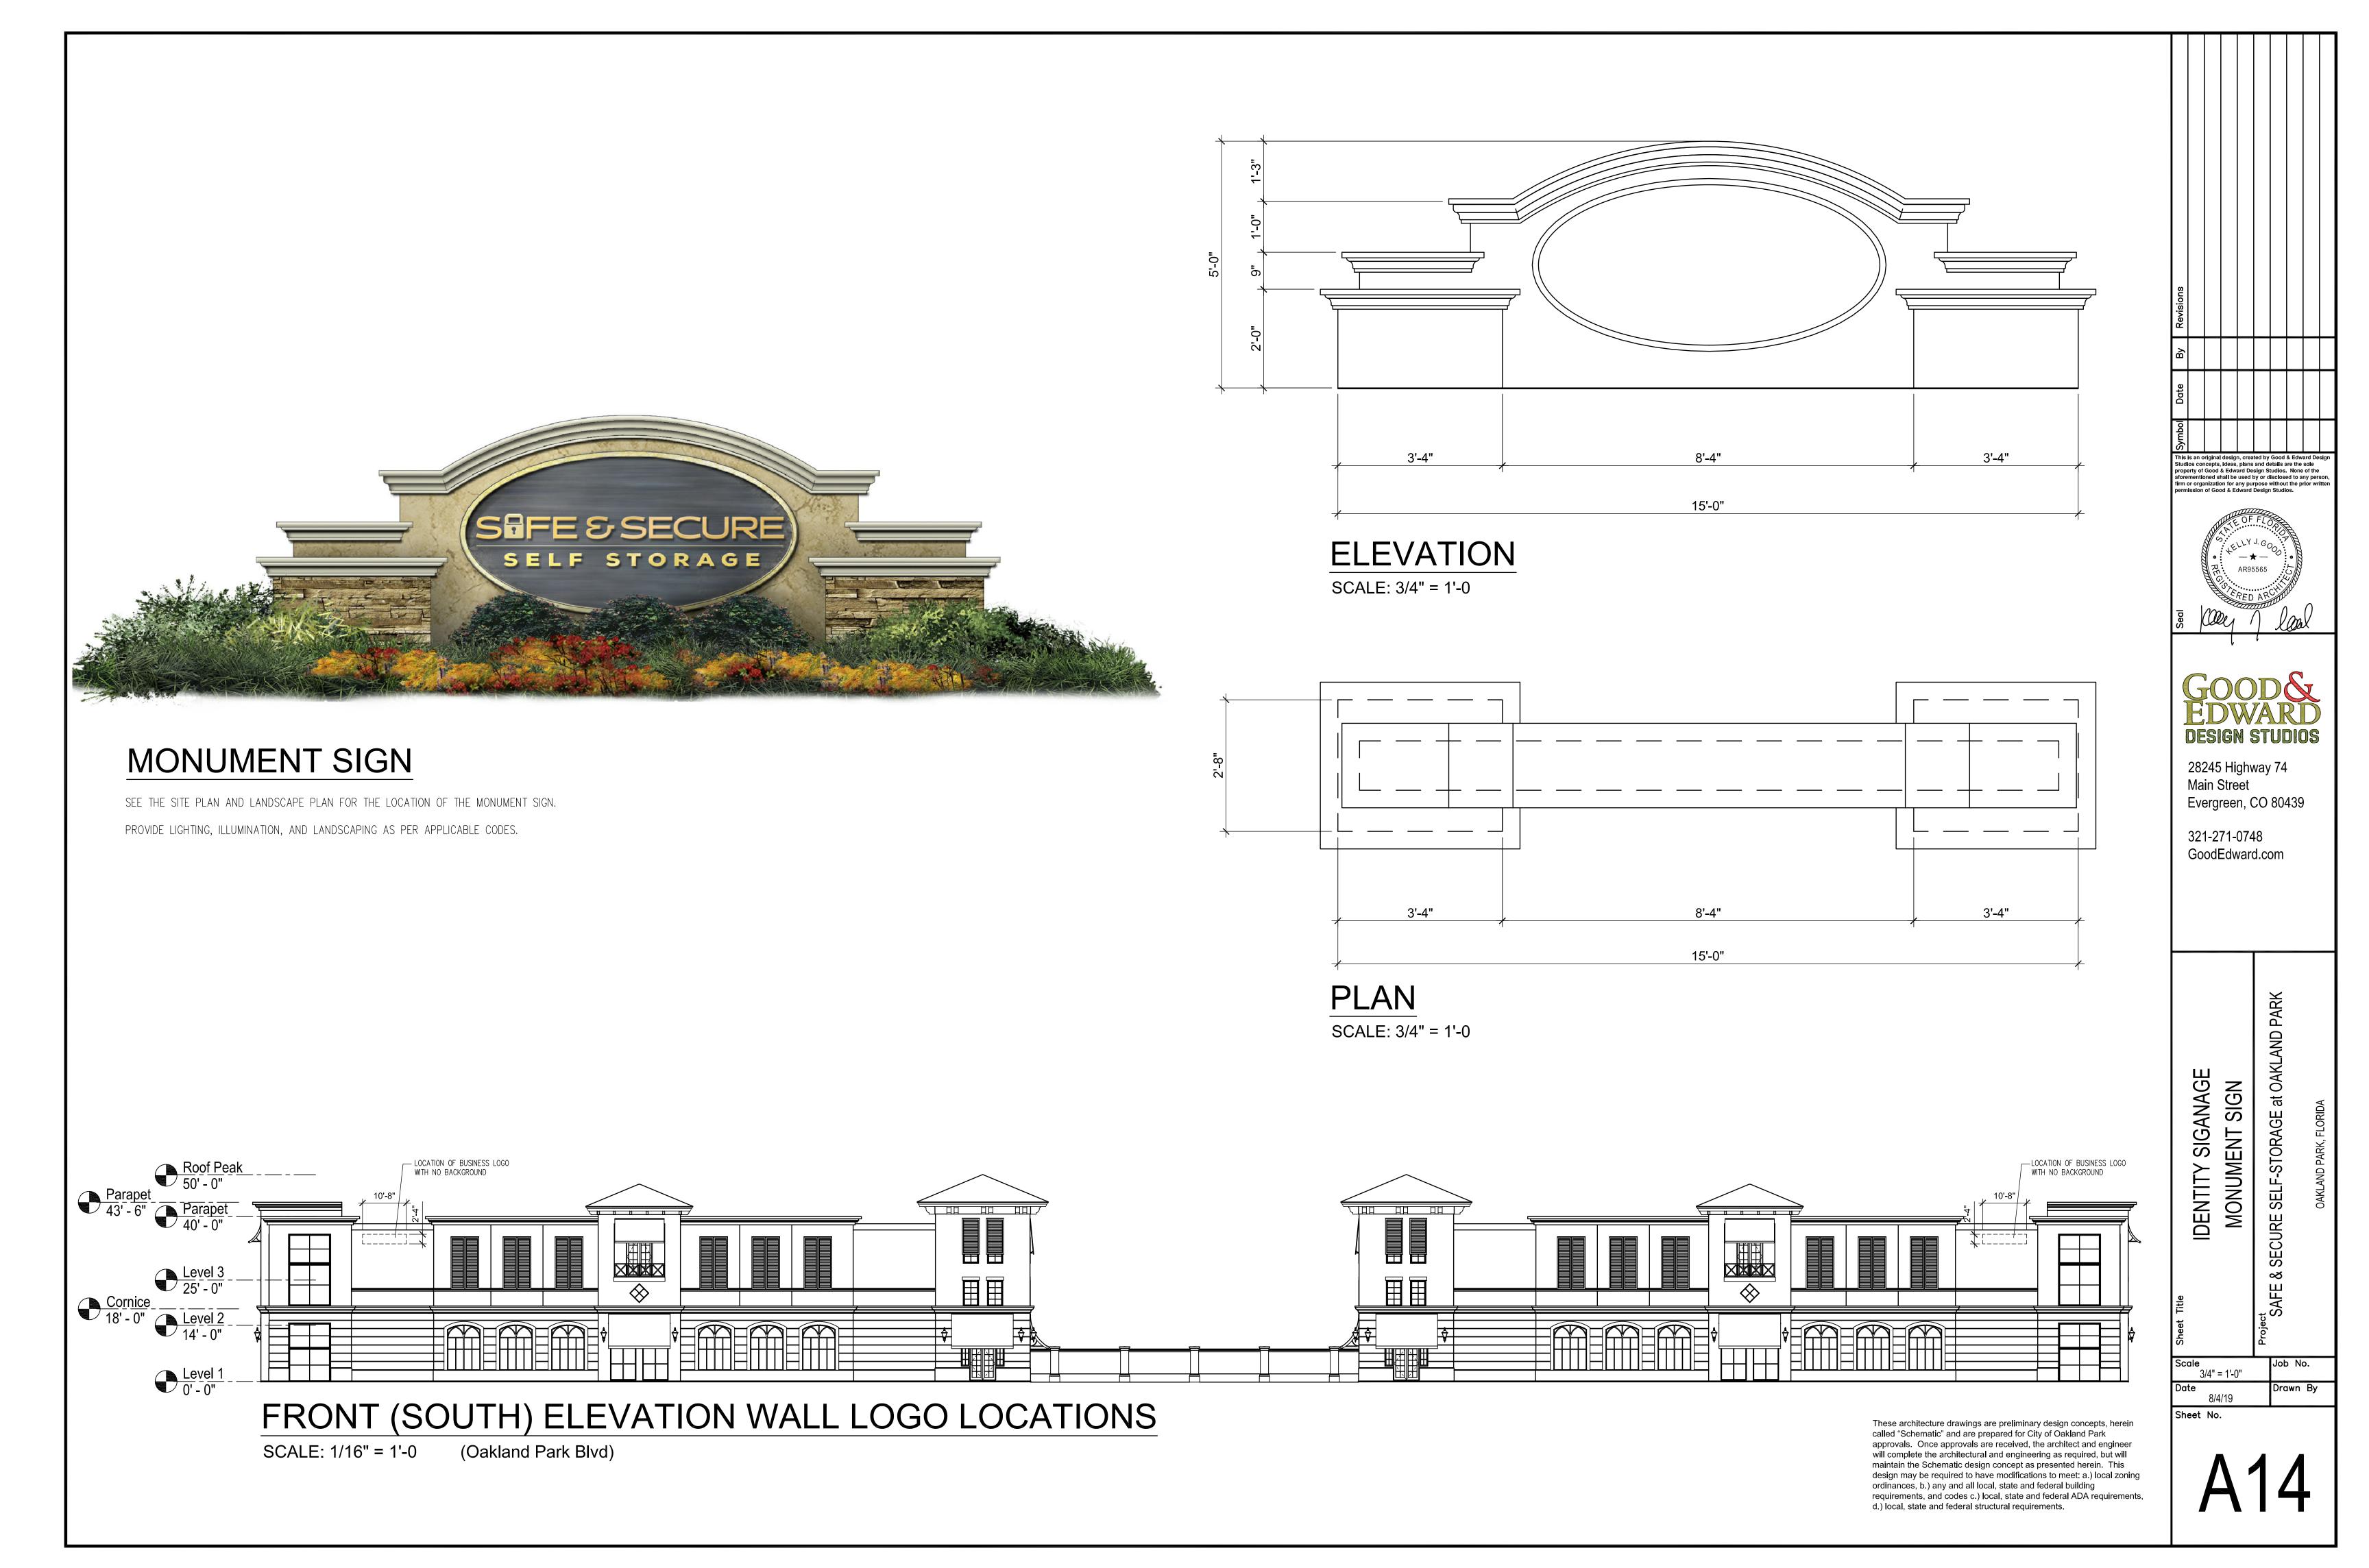

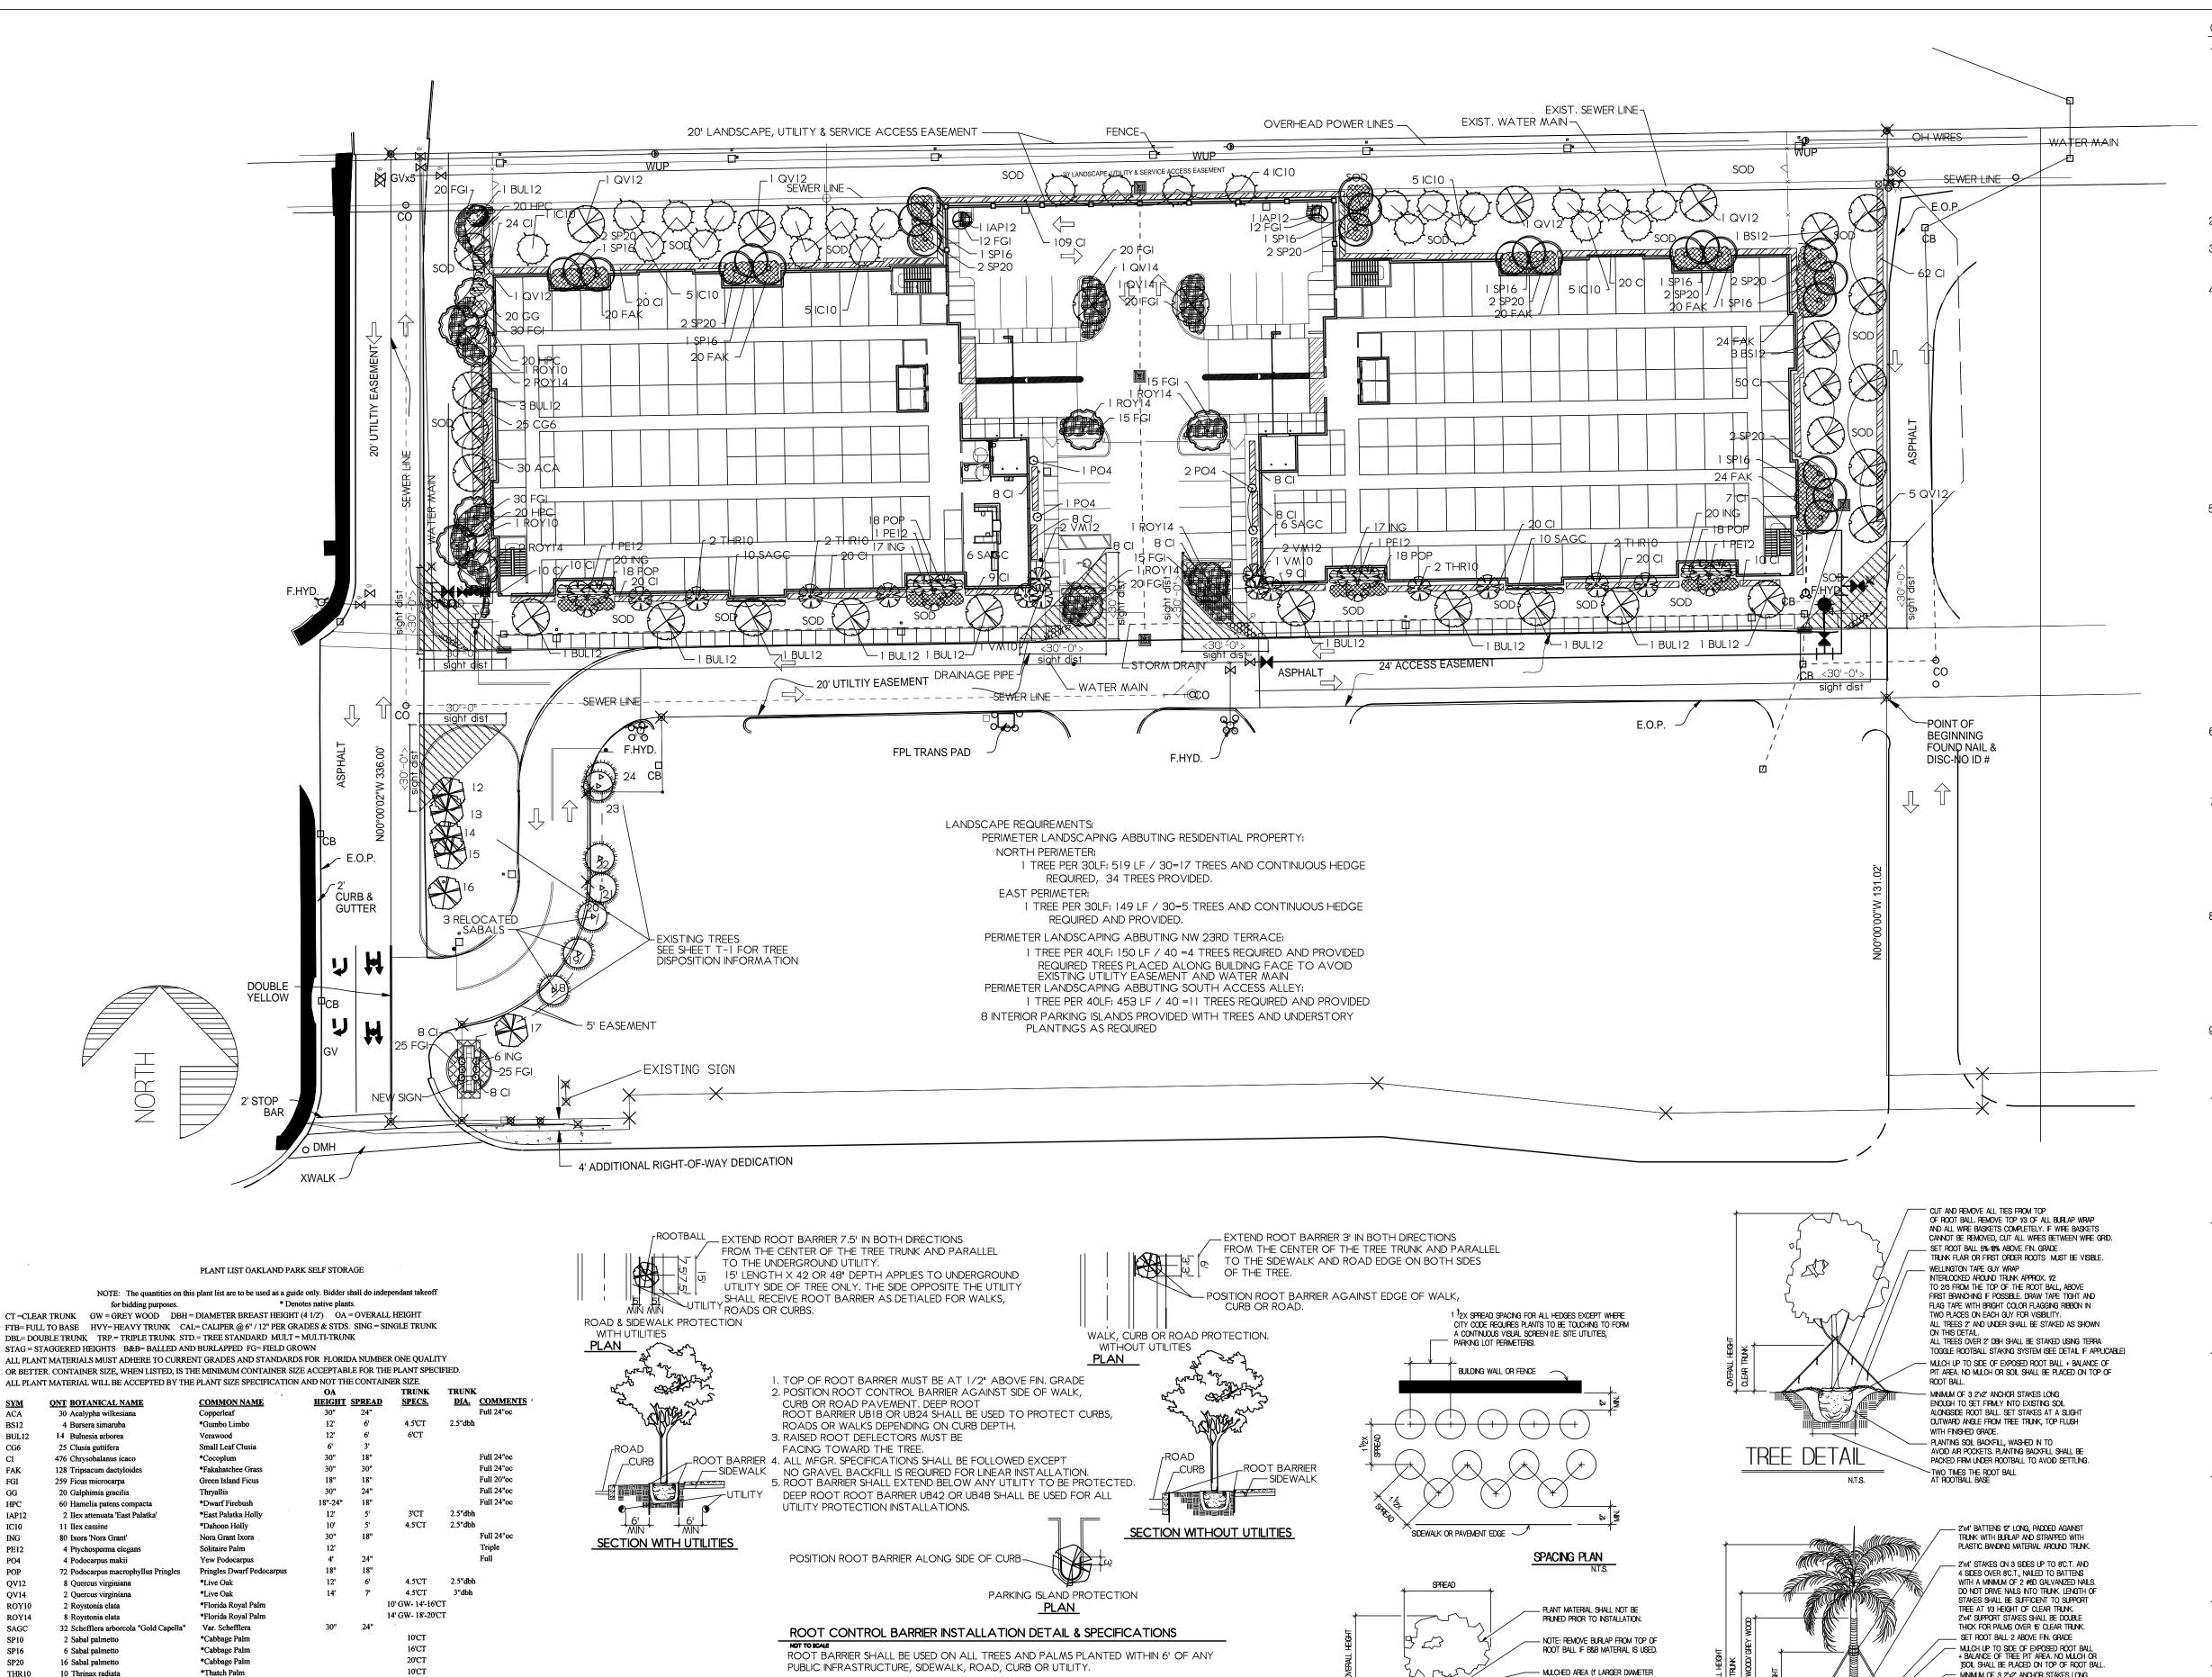EDGE OF PAVEMENT

FIRE HYDRANT CLEAR ZONE
NOT TO SCALE

FIRE HYDRANT CLEAR ZONE REQUIREMENTS
APPLY TO FIRE HYDRANTS, SIAMESE CONNECTIONS

AND ANY OTHER FIRE EQUIPMENT FOR UTILIZING FIRE

SOD ONLY

AND ANY OTHER FIRE EQUIPMENT FOR UTILIZING FIRE
HOSE ON PUBLIC OR PRIVATE PROPERTY.
BY AUTHORITY OF THE SOUTH FLORIDA FIRE PREVENTION CODE SECT. 5211.2
THE CLEAR ZONE SHALL BE FREE OF LANDSCAPE (EXCEPT SOD),
MAILBOXES, PARKING, LAMP-POSTS AND ALL OTHER OBJECTS.
EXCEPTIONS OTHER FIRE FIGHTING EQUIPMENT OR TRAFFIC
POSTS TO PROTECT FIRE FIGHTING EQUIPMENT.

SOD ONLY

THR10

VM10

VM12

10 Thrinax radiata

OTHER LANDSCAPE MATERIALS:

4 Vetchia montgom

Mulch (in Bags)

TO BE MEASURED IN FIELD

Planting Soil (Cubic Yards)

Vetchia montgomerya

Montgomery Palm

10'CT

LOCATION AS SHOWN ON PLAN & GENERAL SPECIFICATIONS

of the State of Florida. plant materials shall be followed. project light poles. the bark of any tree or palm. movement under or around trees. at the time of planting. Spacing of shrubs center to center shall be as specified by the municipality for screening requirements. All mechanical equipment, air conditioning, irrigation pumps, FPL of backfilling. structures or planting beds and shall extend to any abutting street pavement edge and to the mean waterline of any abutting canal, lake General Specifications. The more stringent requirement shall operations begin.

- MINIMUM OF 3 2'x2" ANCHOR STAKES LONG

ENOUGH TO SET FIRMLY INTO EXISTING SOIL

ALONGSIDE ROOT BALL, SET STAKES AT A SLIGHT

OUTWARD ANGLE FROM TREE TRUNK, TOP FLUSH

CUT AND REMOVE ALL TIES FROM TOP

The Landscape Architect of record shall provide a certification letter

to the City certifying that the landscaping was installed according

PALMS SHALL BE PLANTED SO THAT ALL HEADS ARE CLEAR OF BUILDING WALLS AND WINDOWS BY ONE FROND LENGTH PLUS 2.
ALL PLANTING AREAS FOR PALMS SHALL BE EXCAVATED TO A DEPTH OF 36'
AND TO A WIDTH OF TWICE THE ROOT BALL TO REMOVE ALL LIMESTONE

to the approved plans and specifications before the Cities

landscape inspector makes a final inspection.

Landscape Certification:

- PLANTING SOIL BACKFILL, WASHED IN TO

AVOID AIR POCKETS, PLANTING BACKFILL SHALL BE

PACKED FIRM UNDER ROOTBALL TO AVOID SETTLING.

THAN ROOT BALL, MIN.), WHERE SHRUBS

ARE SHOWN IN PLANTING BEDS, ENTIRE

. PLANTING SOIL BACKFILL, WASHED IN

BED TO BE MULCHED.

TO AVOID AIR POCKETS.

SHRUB DETAIL

GENERAL SPECIFICATIONS 1. All plant materials shall be Florida No. 1 or better as set forth by the Florida Department of Agriculture, Grades and Standards for Nursery Plants, current edition. All plants to be graded shall comply with the general requirements listed there in. Certification that all plant materials installed are Florida No. 1 or better shall be the sole responsibility of the Landscape Contractor. Said certification shall be provided to the Owner or his authorized representative at the time of delivery of the plant material to the job site. Any dispute regarding plant material grade shall be determined by a representative of the Division of Plant Industry All rules and guidelines set by the State for the purposes of grading 2. Palms shall be planted so that all heads are clear of building walls and windows at mature spread. 3. All Sabal Palms, Queen Palms, Washingtonia Palms, Phoenix varieties and all other single trunk, upright varieties with six foot (6') of clear trunk or greater shall be staked as detailed. 4. All trees shall be planted so that heads will be clear of building walls, roof lines and windows at mature spread. Shade trees shall not be located closer that fifteen feet (15') from project light poles. Medium to small trees/ palms shall not be planted closer than ten feet (10ft) to Florida Power and Light tree location guidelines shall be followed in all cases relating to FPL power pole or easement locations. Where Codes require, locations of all trees planted in Rights-Of-Way or utility easements shall be confirmed by the landscape contractor with the City or County Engineer before installation. All tree trunk calipers shall be measured at 4 1/2' above top of root ball. All trees that are designated as single - trunk trees shall have a single, dominant leader and a relatively straight trunk. All trees that are designated as multi-trunk trees shall have at least three trunks with equal calipers originating from the base of the trees, and with angles no greater than 45 degrees. Trees with bark inclusion or codominant trunks will not be accepted. 5. All Trees and Palms shall be kept in an upright position. Under no circumstances shall any support method used employ the driving of nails or other mechanical devices of any kind into All staking shall be removed approximately 6 months after planting or at the time of establishment of the tree. Large trees and palms shall be planted a min. of 10' from building foundations and masonry walls. Medium trees and palms a min. of 7ft and small trees/palms a min. of 5ft from masonry structures. All synthetic burlap, synthetic string or cords shall be removed before any trees are planted. All synthetic tape (ie. tagging tape, nursery tape) shall be removed from trunks, branches, etc. before inspection. The top one-third of any natural burlap shall be removed before the trees are backfilled. All wire baskets shall be removed from the top and sides of the rootball to a depth of 3" and all remaining wire shall be cut to prevent gurdling. All trees, (except palms) and other plants shall be planted with the top of their rootballs 5%-10% above the final grade surrounding the planting area as detailed. Palms shall be planted with the top of the rootball flush with the surrounding area. 6. All trees within or overhanging pedestrian areas shall have a clear trunk high enough to allow unobstructed pedestrian Sight distance concerns must be maintained for clear sight visibility from thirty (30) inches to seventy-two (72) inches, tree trunks excluded. 7. All hedges shall be planted with twelve inches (12") clear space between outer branches and building walls, fences or pavement edges and three feet (3') back from edge of parking spaces

transformers, pool pumps, etc., must be screened on three (3) sides 8. Irrigation shall be by underground, automatic, rust free system with 100% coverage and a minimum of 50% overlap of spray. Irrigation rain sensor shall be installed. Irrigation water shall not be directed onto or over impervious surfaces. Irrigation systems other than City water shall require a South Florida Water Management District water use permit prior to the issuance of the required irrigation permit from the City and/or the operation of the irrigation system. Approved irrigation permits shall be required from the City prior to installation. 9. Planting soil shall be at least 30% muck and 70% sand pulverized and weed free, to be mixed with existing soil free from rocks and debris and backfilled into plant pits by washing in. Planting soil for Sabal Palms shall be clean sand. Existing soil may be used as planting soil if approved by the Landscape Architect. 10. Fertilizer for trees and shrubs shall be a general purpose 50% organic fertilizer low in phosphorus, with minor elements, iron and manganese and shall be mixed with the planting soil at the time Fertilizer for palms shall be a palm special type to include

manganese and magnesium sulfate. Application rates for all fertilizers at the time of planting shall be 1/2 the manufacturers recommendations for established

11. Mulch shall be shreaded eucalyptus or other clean hardwood species grade "B" or better set at a 3" minimum depth and wet down to prevent wind displacement. Cypress, red or dyed mulch shall not be accepted. All mulch shall All mulch shall be certified "Arsenic Free". All trees shall have a water ring with a minimum depth of two inches, maximum of three inches, and a diameter of 3 feet to 4 feet around

the base. No mulch shall be placed over the rootball of any tree. All mulch shall be kept two inches from the stems of all shrub plant material. 12. Sod shall be Stenotaphrum secundatum "Floritam" or "Palmetto" solid sod, weed free and set with staggered joints. Sod shall be placed on all areas not used for buildings, vehicular use areas, walks, site

or waterway. Sod shall be placed no closer that three (3) feet from the trunk of any tree. Sod placed adjacent to pavement and curbs shall be set with top of sod-soil set flush with the top of the adjacent pavement and/or curb. 13. Planting plans take precedence over plant lists. The Landscape Contractor shall be responsible for doing his own takeoff. The Landscape Contractor shall familiarize himself with the municipal code and deed restrictions of the municipality in which the project is located. All existing codes and deed restrictions pertaining to the municipality in which the project is located shall apply and may supersede these

14. The Landscape Contractor shall be aware of the locations of all easements and utilities above and below ground and shall call for utility stakeout forty eight (48) hours before any digging


All plant pits located in easements shall be hand dug. 15. The Landscape Contractor shall provide a written guarantee to the Owner for all plant materials and workmanship for a period no less than one year from the time of final inspection and acceptance by the Owner.

At the end of the guarantee period, all plant materials shall be inspected by the Landscape Contractor and the Owner. All plants that are in a healthy, growing condition at the time of the inspection shall be free from further guarantee and shall be the Owners responsibility. All plants that are in questionable condition due to transplant shock shall continue under the guarantee until recovery or, if deemed severely retarded in growth or dead, shall be replaced. Replaced plant material shall be guaranteed for the same time period and under the same conditions as the original plant material. This guarantee does not apply if the plant materials have not been maintained by the Owner as instructed by the Landscape Contractor, are damaged by storms, vandalism, insect or freeze damage or acts of God beyond the Landscape Contractors control. All plants shall be free from harmful plant pests at the time of planting.

CONSTR & EMBO MAY BE


OF: ONE

CONTRACT SIGNATURE DRAWINGS TAL OR ORIGINAL SEALED

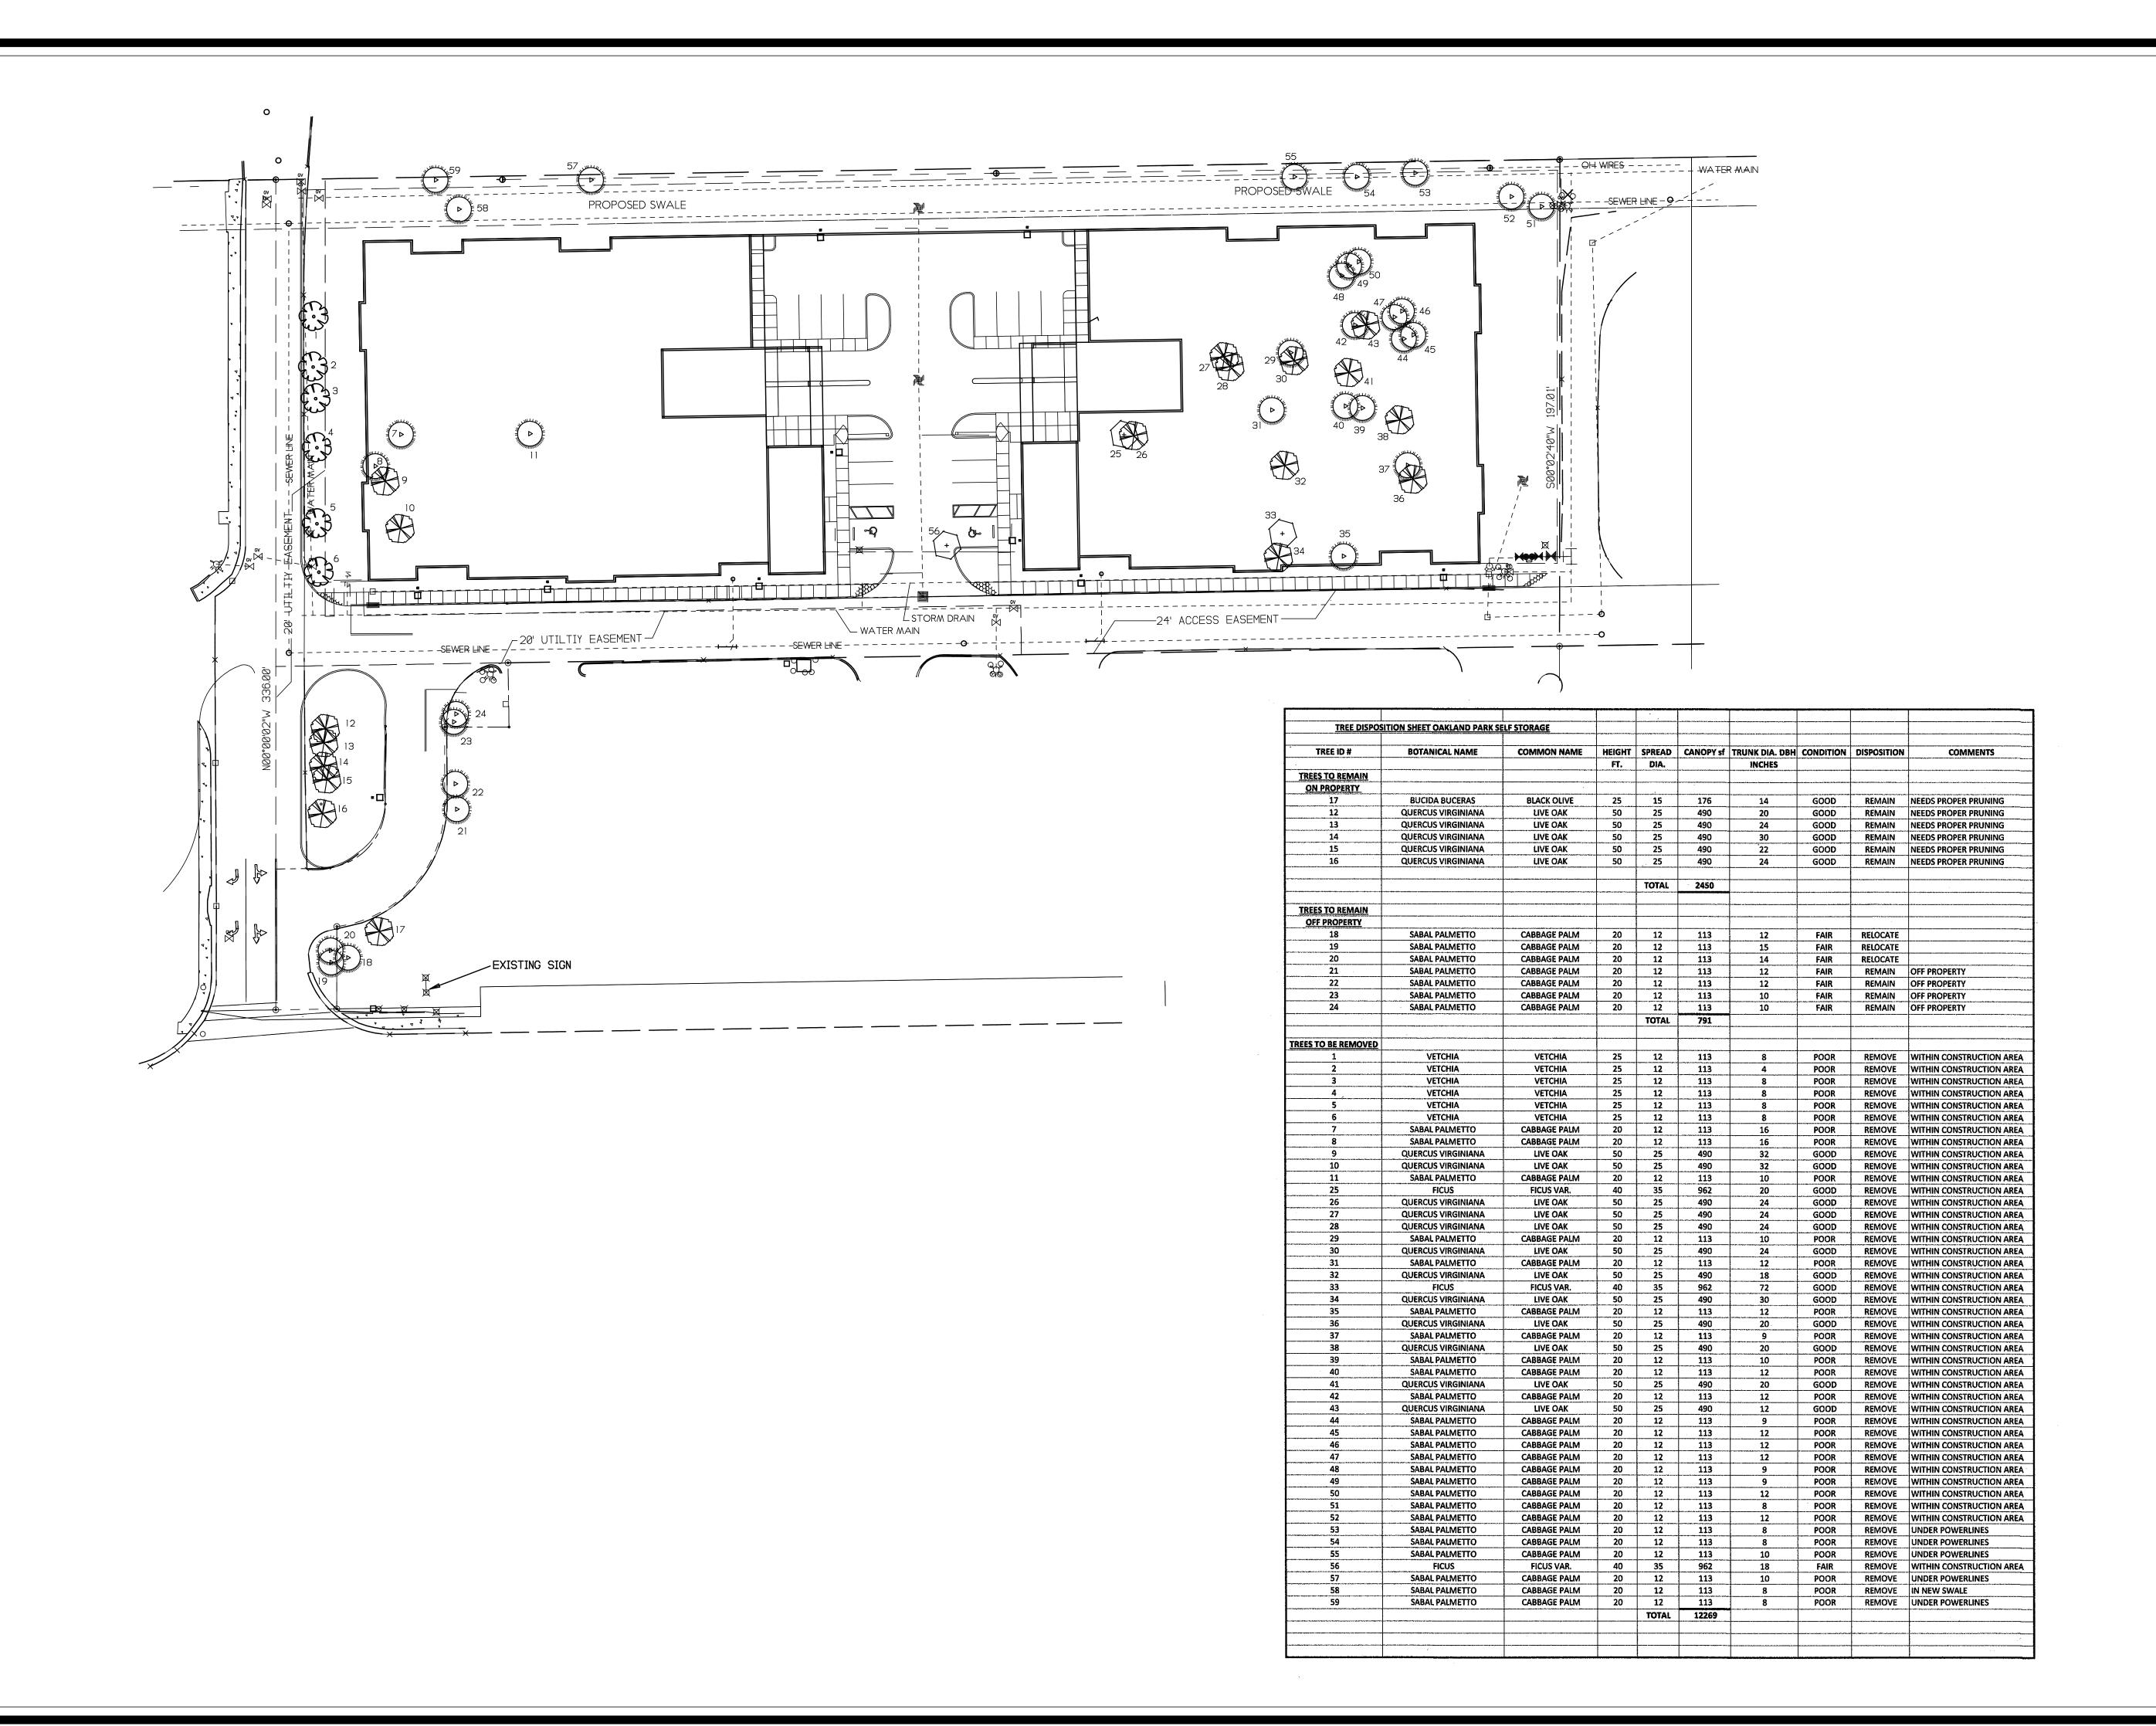

RAWINGS ARE NOT VALID FOR SUBMITTAL OR CONTRACT CONSTRUCTION USE SIGNED, SEALED & DATED WITH AN ORIGINAL SIGNATURE & EMBOSSED SEAL LANDSCAPE ARCHITECT. UNSIGNED & SEALED DRAWINGS MAY BE USED FOR INHOUSE PURPOSES & BIDDING ONLY.

SHEET NO: OF: ONE

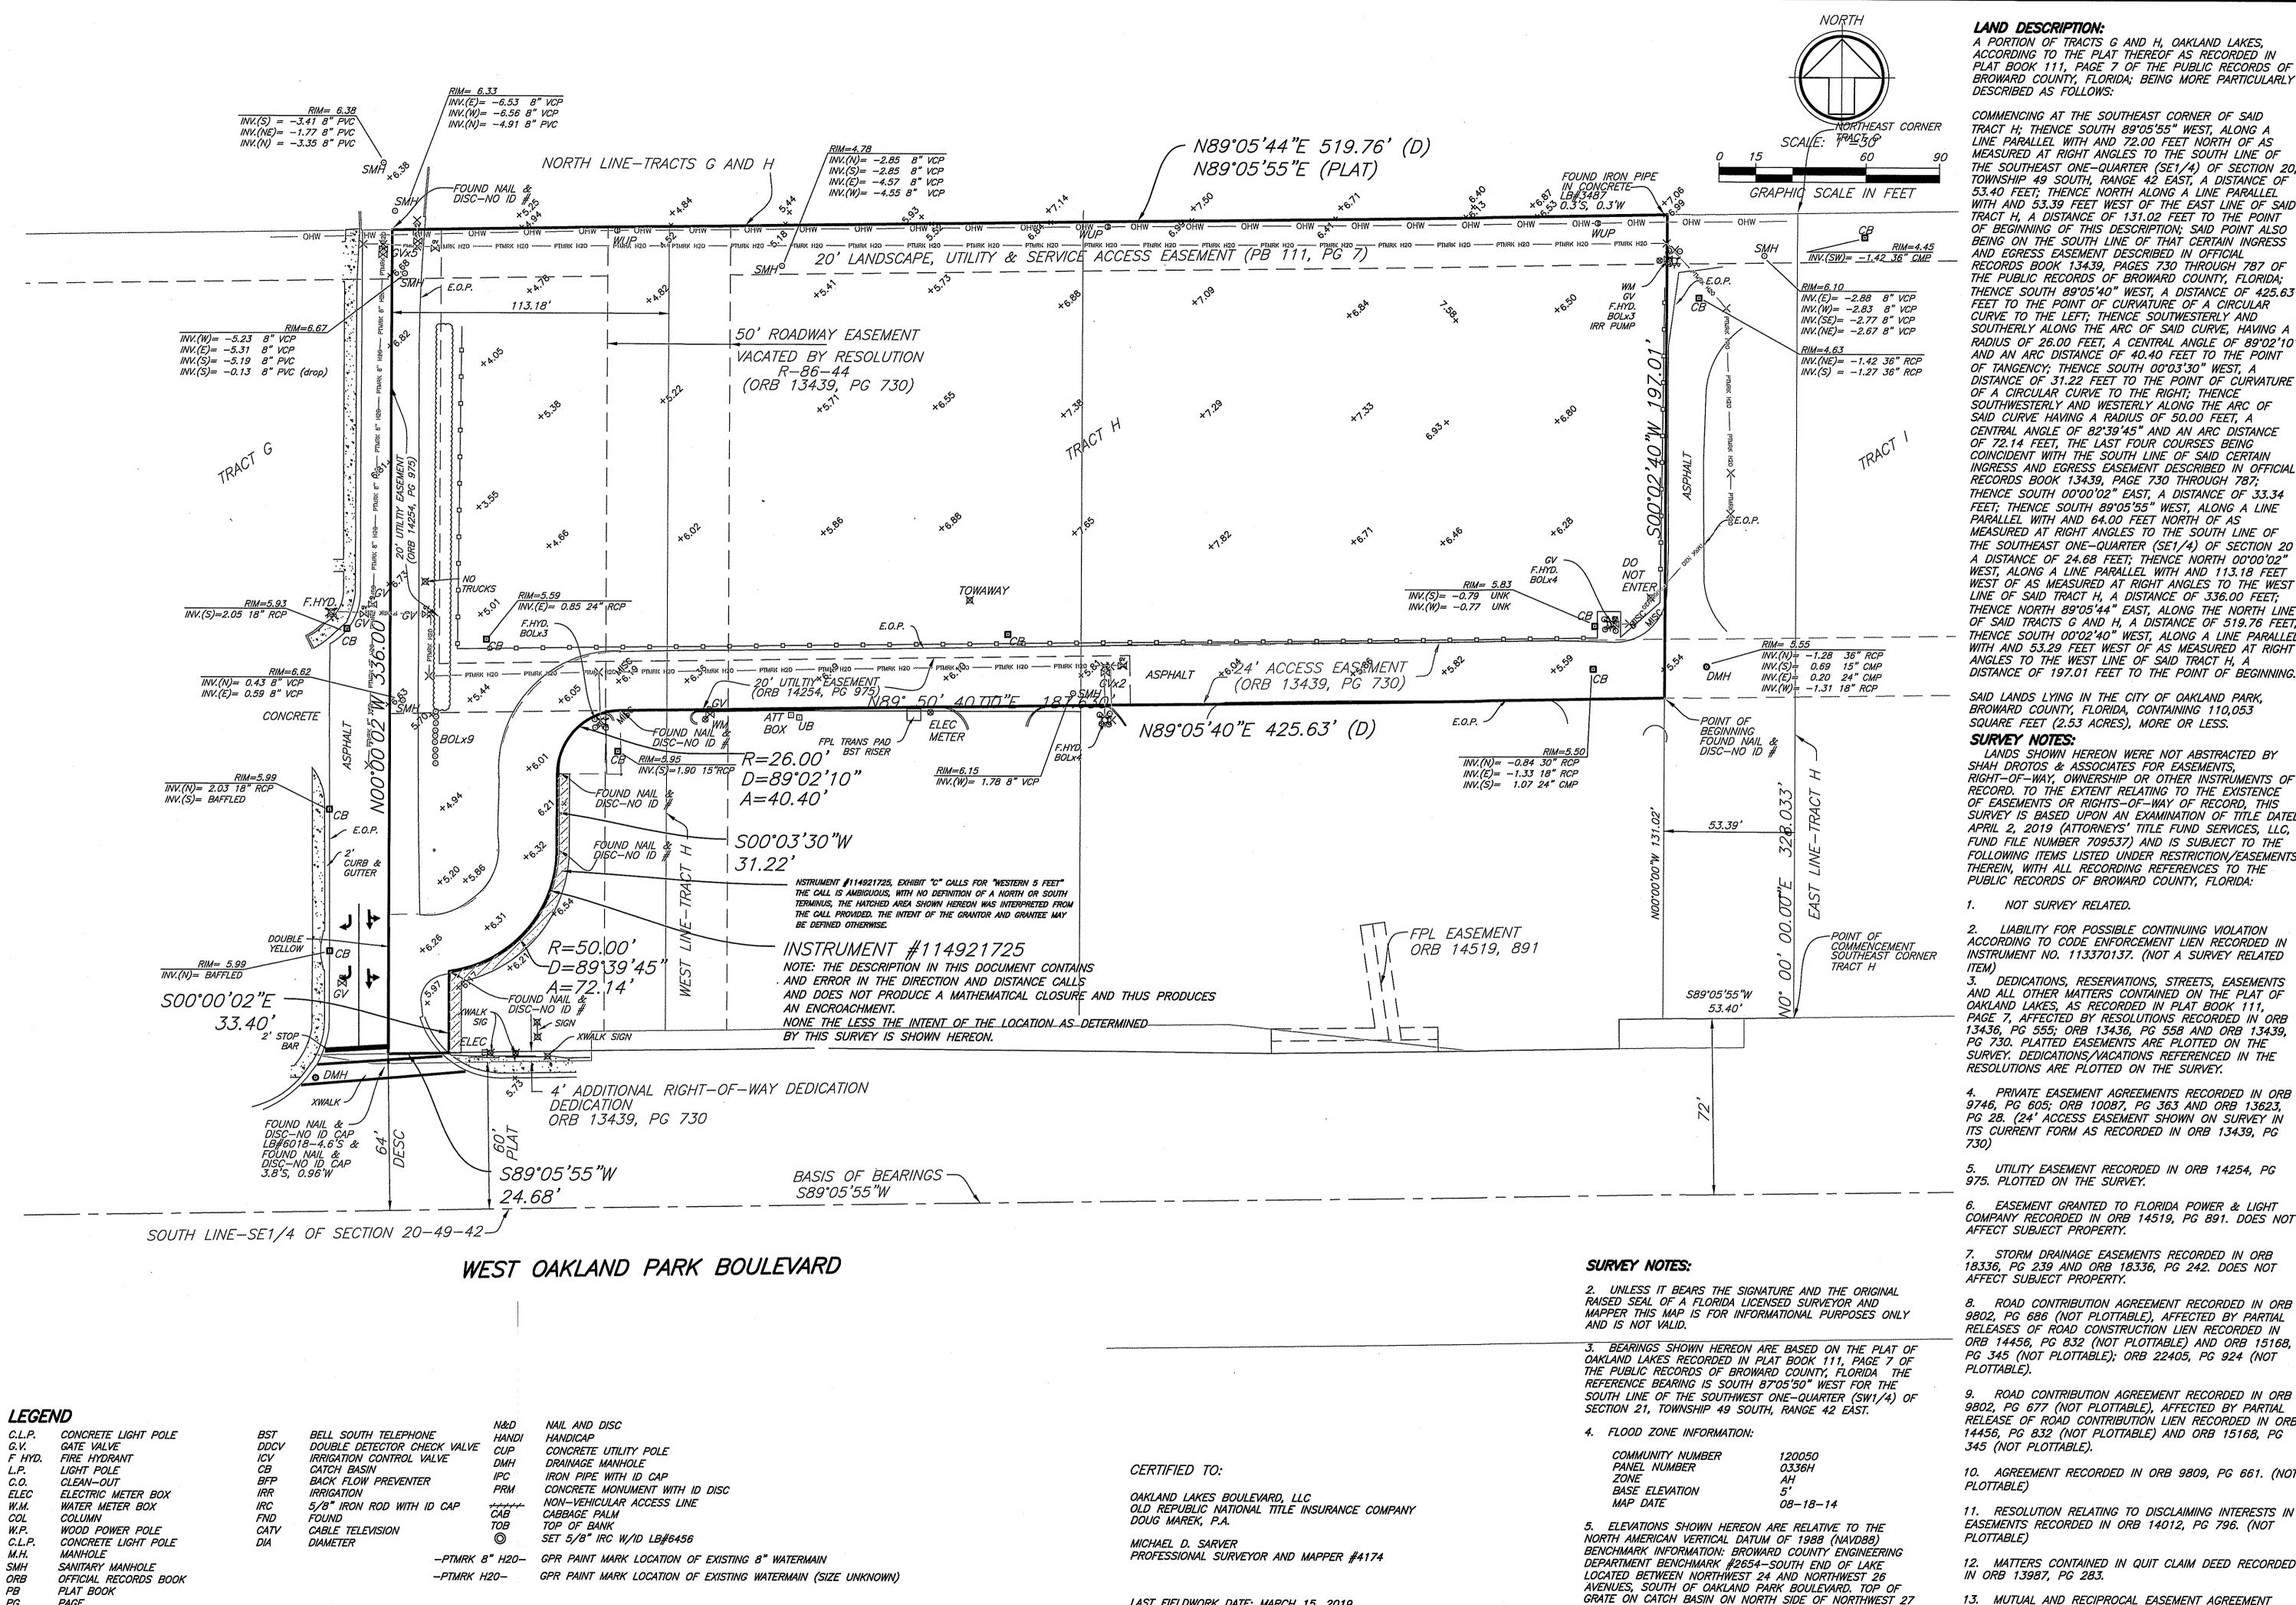

PG

TYP

BOL

PAGE

TYPICAL

BOLLARD

HANDHOLE

FINISHED FLOOR ELEVATION

AMERICAN TELEPHONE/TELEGRAPH

LAST FIELDWORK DATE: MARCH 15, 2019

MAP DATE: JUNE 18, 2019

A PORTION OF TRACTS G AND H, OAKLAND LAKES, ACCORDING TO THE PLAT THEREOF AS RECORDED IN PLAT BOOK 111, PAGE 7 OF THE PUBLIC RECORDS OF BROWARD COUNTY, FLORIDA; BEING MORE PARTICULARLY DESCRIBED AS FOLLOWS:

COMMENCING AT THE SOUTHEAST CORNER OF SAID TRACT H; THENCE SOUTH 89°05'55" WEST, ALONG A LINE PARALLEL WITH AND 72.00 FEET NORTH OF AS MEASURED AT RIGHT ANGLES TO THE SOUTH LINE OF THE SOUTHEAST ONE-QUARTER (SE1/4) OF SECTION 20, TOWNSHIP 49 SOUTH, RANGE 42 EAST, A DISTANCE OF 53.40 FEET; THENCE NORTH ALONG A LINE PARALLEL WITH AND 53.39 FEET WEST OF THE EAST LINE OF SAID TRACT H. A DISTANCE OF 131.02 FEET TO THE POINT OF BEGINNING OF THIS DESCRIPTION; SAID POINT ALSO BEING ON THE SOUTH LINE OF THAT CERTAIN INGRESS AND EGRESS EASEMENT DESCRIBED IN OFFICIAL RECORDS BOOK 13439, PAGES 730 THROUGH 787 OF THE PUBLIC RECORDS OF BROWARD COUNTY, FLORIDA; THENCE SOUTH 89°05'40" WEST, A DISTANCE OF 425.63 FEET TO THE POINT OF CURVATURE OF A CIRCULAR CURVE TO THE LEFT; THENCE SOUTWESTERLY AND SOUTHERLY ALONG THE ARC OF SAID CURVE, HAVING A RADIUS OF 26.00 FEET, A CENTRAL ANGLE OF 89°02'10" AND AN ARC DISTANCE OF 40.40 FEET TO THE POINT OF TANGENCY; THENCE SOUTH 00°03'30" WEST, A DISTANCE OF 31.22 FEET TO THE POINT OF CURVATURE OF A CIRCULAR CURVE TO THE RIGHT; THENCE SOUTHWESTERLY AND WESTERLY ALONG THE ARC OF SAID CURVE HAVING A RADIUS OF 50.00 FEET, A CENTRAL ANGLE OF 82'39'45" AND AN ARC DISTANCE OF 72.14 FEET. THE LAST FOUR COURSES BEING COINCIDENT WITH THE SOUTH LINE OF SAID CERTAIN INGRESS AND EGRESS EASEMENT DESCRIBED IN OFFICIAL RECORDS BOOK 13439, PAGE 730 THROUGH 787; THENCE SOUTH 00'00'02" EAST, A DISTANCE OF 33.34 FEET; THENCE SOUTH 89°05'55" WEST, ALONG A LINE PARALLEL WITH AND 64.00 FEET NORTH OF AS MEASURED AT RIGHT ANGLES TO THE SOUTH LINE OF THE SOUTHEAST ONE-QUARTER (SE1/4) OF SECTION 20 A DISTANCE OF 24.68 FEET; THENCE NORTH 00°00'02" WEST, ALONG A LINE PARALLEL WITH AND 113.18 FEET WEST OF AS MEASURED AT RIGHT ANGLES TO THE WEST LINE OF SAID TRACT H, A DISTANCE OF 336.00 FEET: THENCE NORTH 89'05'44" EAST, ALONG THE NORTH LINE OF SAID TRACTS G AND H, A DISTANCE OF 519.76 FEET; THENCE SOUTH 00°02'40" WEST, ALONG A LINE PARALLEL WITH AND 53.29 FEET WEST OF AS MEASURED AT RIGHT ANGLES TO THE WEST LINE OF SAID TRACT H, A DISTANCE OF 197.01 FEET TO THE POINT OF BEGINNING.

SAID LANDS LYING IN THE CITY OF OAKLAND PARK BROWARD COUNTY, FLORIDA, CONTAINING 110,053 SQUARE FEET (2.53 ACRES), MORE OR LESS.

LANDS SHOWN HEREON WERE NOT ABSTRACTED BY SHAH DROTOS & ASSOCIATES FOR EASEMENTS, RIGHT-OF-WAY, OWNERSHIP OR OTHER INSTRUMENTS OF RECORD. TO THE EXTENT RELATING TO THE EXISTENCE OF EASEMENTS OR RIGHTS-OF-WAY OF RECORD, THIS SURVEY IS BASED UPON AN EXAMINATION OF TITLE DATED APRIL 2, 2019 (ATTORNEYS' TITLE FUND SERVICES, LLC, FUND FILE NUMBER 709537) AND IS SUBJECT TO THE FOLLOWING ITEMS LISTED UNDER RESTRICTION/EASEMENTS THEREIN, WITH ALL RECORDING REFERENCES TO THE PUBLIC RECORDS OF BROWARD COUNTY, FLORIDA:

1. NOT SURVEY RELATED.

2. LIABILITY FOR POSSIBLE CONTINUING VIOLATION ACCORDING TO CODE ENFORCEMENT LIEN RECORDED IN INSTRUMENT NO. 113370137. (NOT A SURVEY RELATED

DEDICATIONS, RESERVATIONS, STREETS, EASEMENTS AND ALL OTHER MATTERS CONTAINED ON THE PLAT OF OAKLAND LAKES, AS RECORDED IN PLAT BOOK 111. PAGE 7, AFFECTED BY RESOLUTIONS RECORDED IN ORB 13436, PG 555; ORB 13436, PG 558 AND ORB 13439, PG 730. PLATTED EASEMENTS ARE PLOTTED ON THE SURVEY. DEDICATIONS/VACATIONS REFERENCED IN THE RESOLUTIONS ARE PLOTTED ON THE SURVEY.

4. PRIVATE EASEMENT AGREEMENTS RECORDED IN ORB 9746, PG 605; ORB 10087, PG 363 AND ORB 13623, PG 28. (24' ACCESS EASEMENT SHOWN ON SURVEY IN ITS CURRENT FORM AS RECORDED IN ORB 13439, PG

5. UTILITY EASEMENT RECORDED IN ORB 14254, PG 975. PLOTTED ON THE SURVEY.

6. EASEMENT GRANTED TO FLORIDA POWER & LIGHT COMPANY RECORDED IN ORB 14519, PG 891. DOES NOT AFFECT SUBJECT PROPERTY.

7. STORM DRAINAGE EASEMENTS RECORDED IN ORB 18336, PG 239 AND ORB 18336, PG 242. DOES NOT AFFECT SUBJECT PROPERTY.

9802, PG 686 (NOT PLOTTABLE), AFFECTED BY PARTIAL RELEASES OF ROAD CONSTRUCTION LIEN RECORDED IN ORB 14456, PG 832 (NOT PLOTTABLE) AND ORB 15168, PG 345 (NOT PLOTTABLE); ORB 22405, PG 924 (NOT

9. ROAD CONTRIBUTION AGREEMENT RECORDED IN ORB 9802, PG 677 (NOT PLOTTABLE), AFFECTED BY PARTIAL RELEASE OF ROAD CONTRIBUTION LIEN RECORDED IN ORB 14456, PG 832 (NOT PLOTTABLE) AND ORB 15168, PG 345 (NOT PLOTTABLE).

10. AGREEMENT RECORDED IN ORB 9809, PG 661. (NOT

11. RESOLUTION RELATING TO DISCLAIMING INTERESTS IN EASEMENTS RECORDED IN ORB 14012, PG 796. (NOT

12. MATTERS CONTAINED IN QUIT CLAIM DEED RECORDED IN ORB 13987, PG 283.

13. MUTUAL AND RECIPROCAL EASEMENT AGREEMENT RECORDED IN ORB 13735, PG 488. (NOT PLOTTABLE)

14. RECIPROCAL EASEMENT AGREEMENT RECORDED IN ORB 18524, PG 905. (NOT PLOTTABLE)

STREET OPPOSITE SOUTHWESTERLY CORNER OF LAKE.

6. THE SURVEY AND THE INFORMATION, DETAILS, COURSES

AND DISTANCES SHOWN THEREON ARE TRUE, CORRECT AND

ELEVATION=6.52 (NGVD29), 4.94 (NAVD88).

ACCURATE.

CHECKED BY: MDR

SO

DESIGNED BY:

APPROVED BY: S.D.A. SCALE:1"=30'

> SURV 11/

TA/NSPS.

SEAL FOR THE FIRM, BY:

MICHAEL D. SARVER PROFESSIONAL SURVEYOR

AND MAPPER LORIDA REG No. LS417

JUNE 2019

1094A.00 SHEET

OF